

								PLANT NC
3	12/JUN/2023	ISSUED FOR PLANNING	DSP	NNC		DAC		
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NO	DATE	REVISIONS AND RECORD OF ISSUE	DRN	DES	снк	PDE	APP	

NOTES

GRADE SHALL SLOPE UNIFORMLY BETWEEN FINISH SPOT ELEVATIONS AND CONTOURS SHOWN ON THE PLANS.

- 2. ALL DIMENSIONS PROVIDED ARE IN METERS UNLESS NOTED OTHERWISE. PIPE SIZES ARE PROVIDED IN MILLIMETERS.
- 3. EXISTING TOPOGRAPHY AND PROPERTY BOUNDARIES WERE PROVIDED TO BLACK & VEATCH FROM NFE.
- 4. ALL STORMWATER PIPING SHALL BE CORRUGATED HDPE OR APPROVED EQUAL.
- 6. ALL MANHOLES AND CATCH BASINS SHALL BE DESIGNED FOR TRUCK TRAFFIC.

PRUJECI (REDLINE) BUUNDARI

- SECURITY FENCE
- 2.9 M HIGH CHAIN LINK SECURITY FENCE WITH BARBED WIRE
- 4.0 M HIGH PALISADE AND ELECTRIC WIRE FENCE
- NEW CONTOUR
- EXISTING CONTOUR
- GRADE SURFACE FLOW INDICATOR

NEW CULVERT

PROPOSED STORMWATER PIPE AND CATCH BASIN

HYDRANT


FIRE WATER PIPING

- POTABLE WATER PIPING
- SANITARY PIPING

- PETROLEUM INTERCEPTOR
- PROPOSED SWALE
- ELEVATED FIREWATER MONITOR
- OILY DRAINAGE LINE
- FLOOR/DRAIN SUMP

## NOT TO BE USED FOR CONSTRUCTION THE DISTRIBUTION AND USE OF THE NATIVE FORMAT CAD

LATEST CONTROLLED VERSION.				1	
SHANNON LNG LIMITED	PROJECT	DRAWING NUMBER	REV		
IANNON TECHNOLOGY AND ENERGY PARK (STEP)	198291-1STF-S3000				
KEY PLAN, GENERAL NOTES AND LEGEND	CODE				

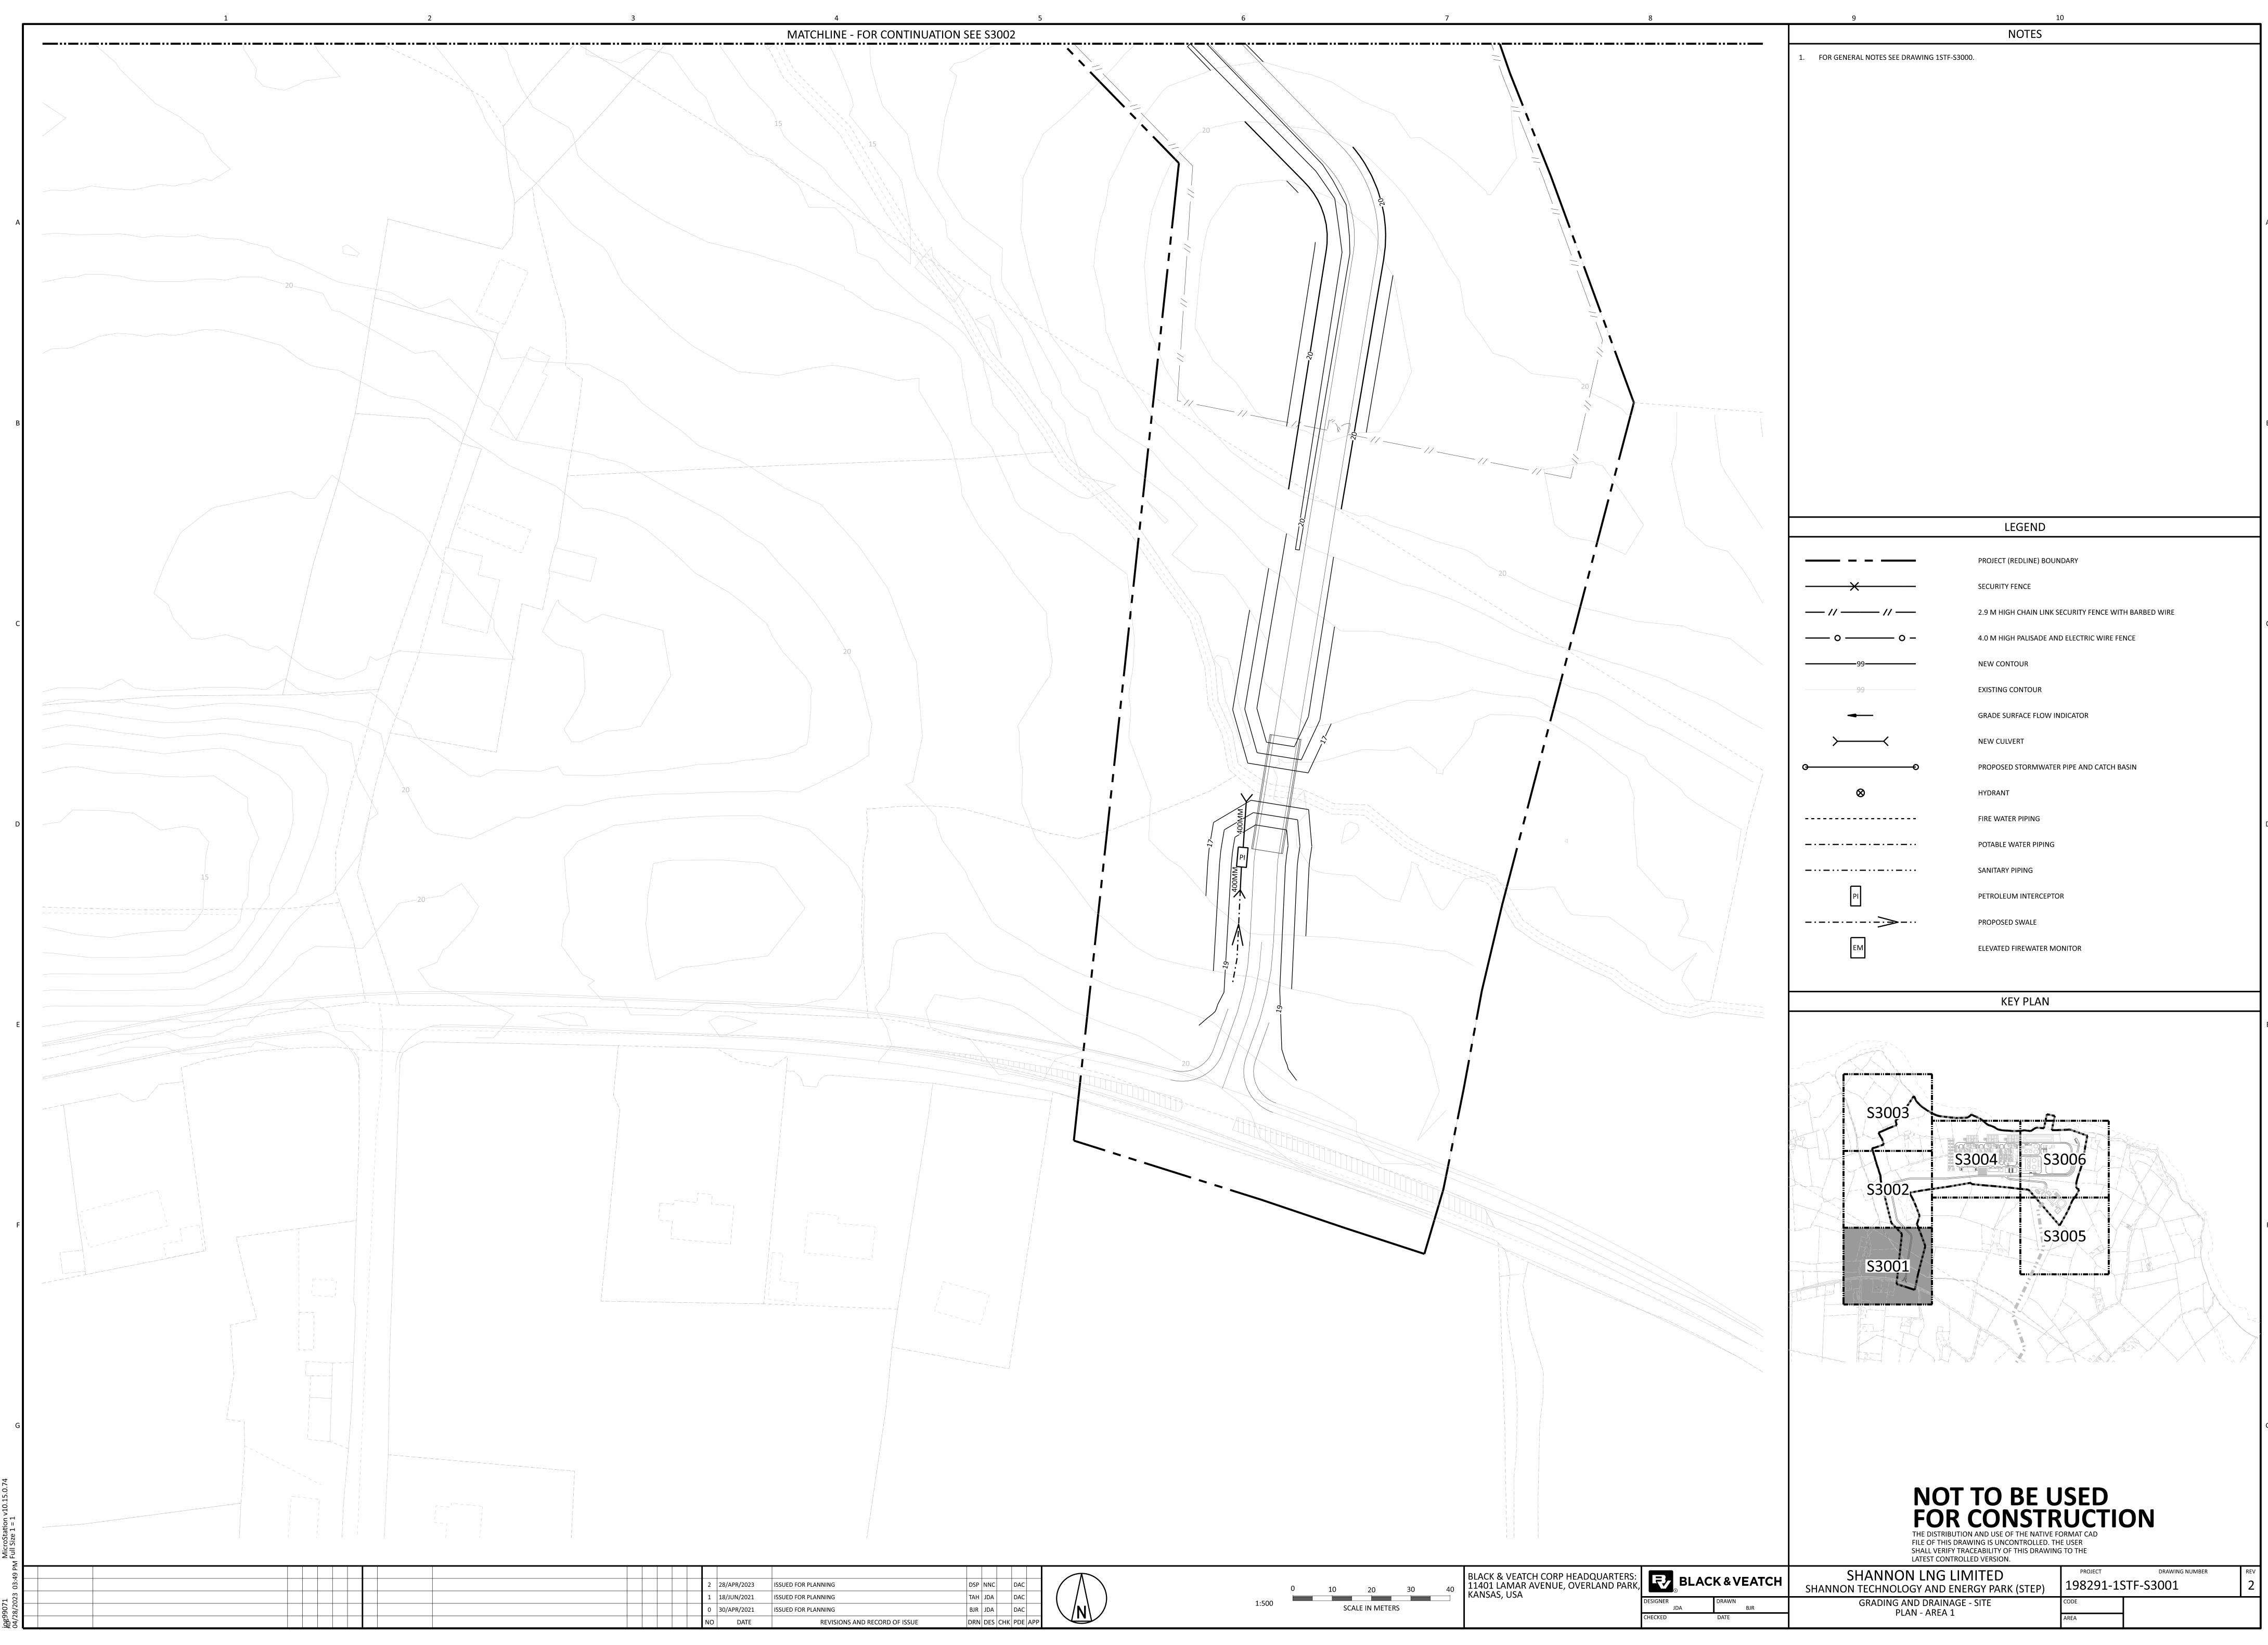


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			0	30/APR/2021	ISSUED FOR PLANNING	BJR	JDA	DAC		\ /N\ /
			NO	DATE	REVISIONS AND RECORD OF ISSUE	DRN	DES CH	PDE	APP	

<b>NOT TO BE U</b> <b>FOR CONSTRUCTION</b> THE DISTRIBUTION AND USE OF THE NATIVE FOR FILE OF THIS DRAWING IS UNCONTROLLED. THI SHALL VERIFY TRACEABILITY OF THIS DRAWING LATEST CONTROLLED VERSION.	UCTI DRMAT CAD E USER	ON
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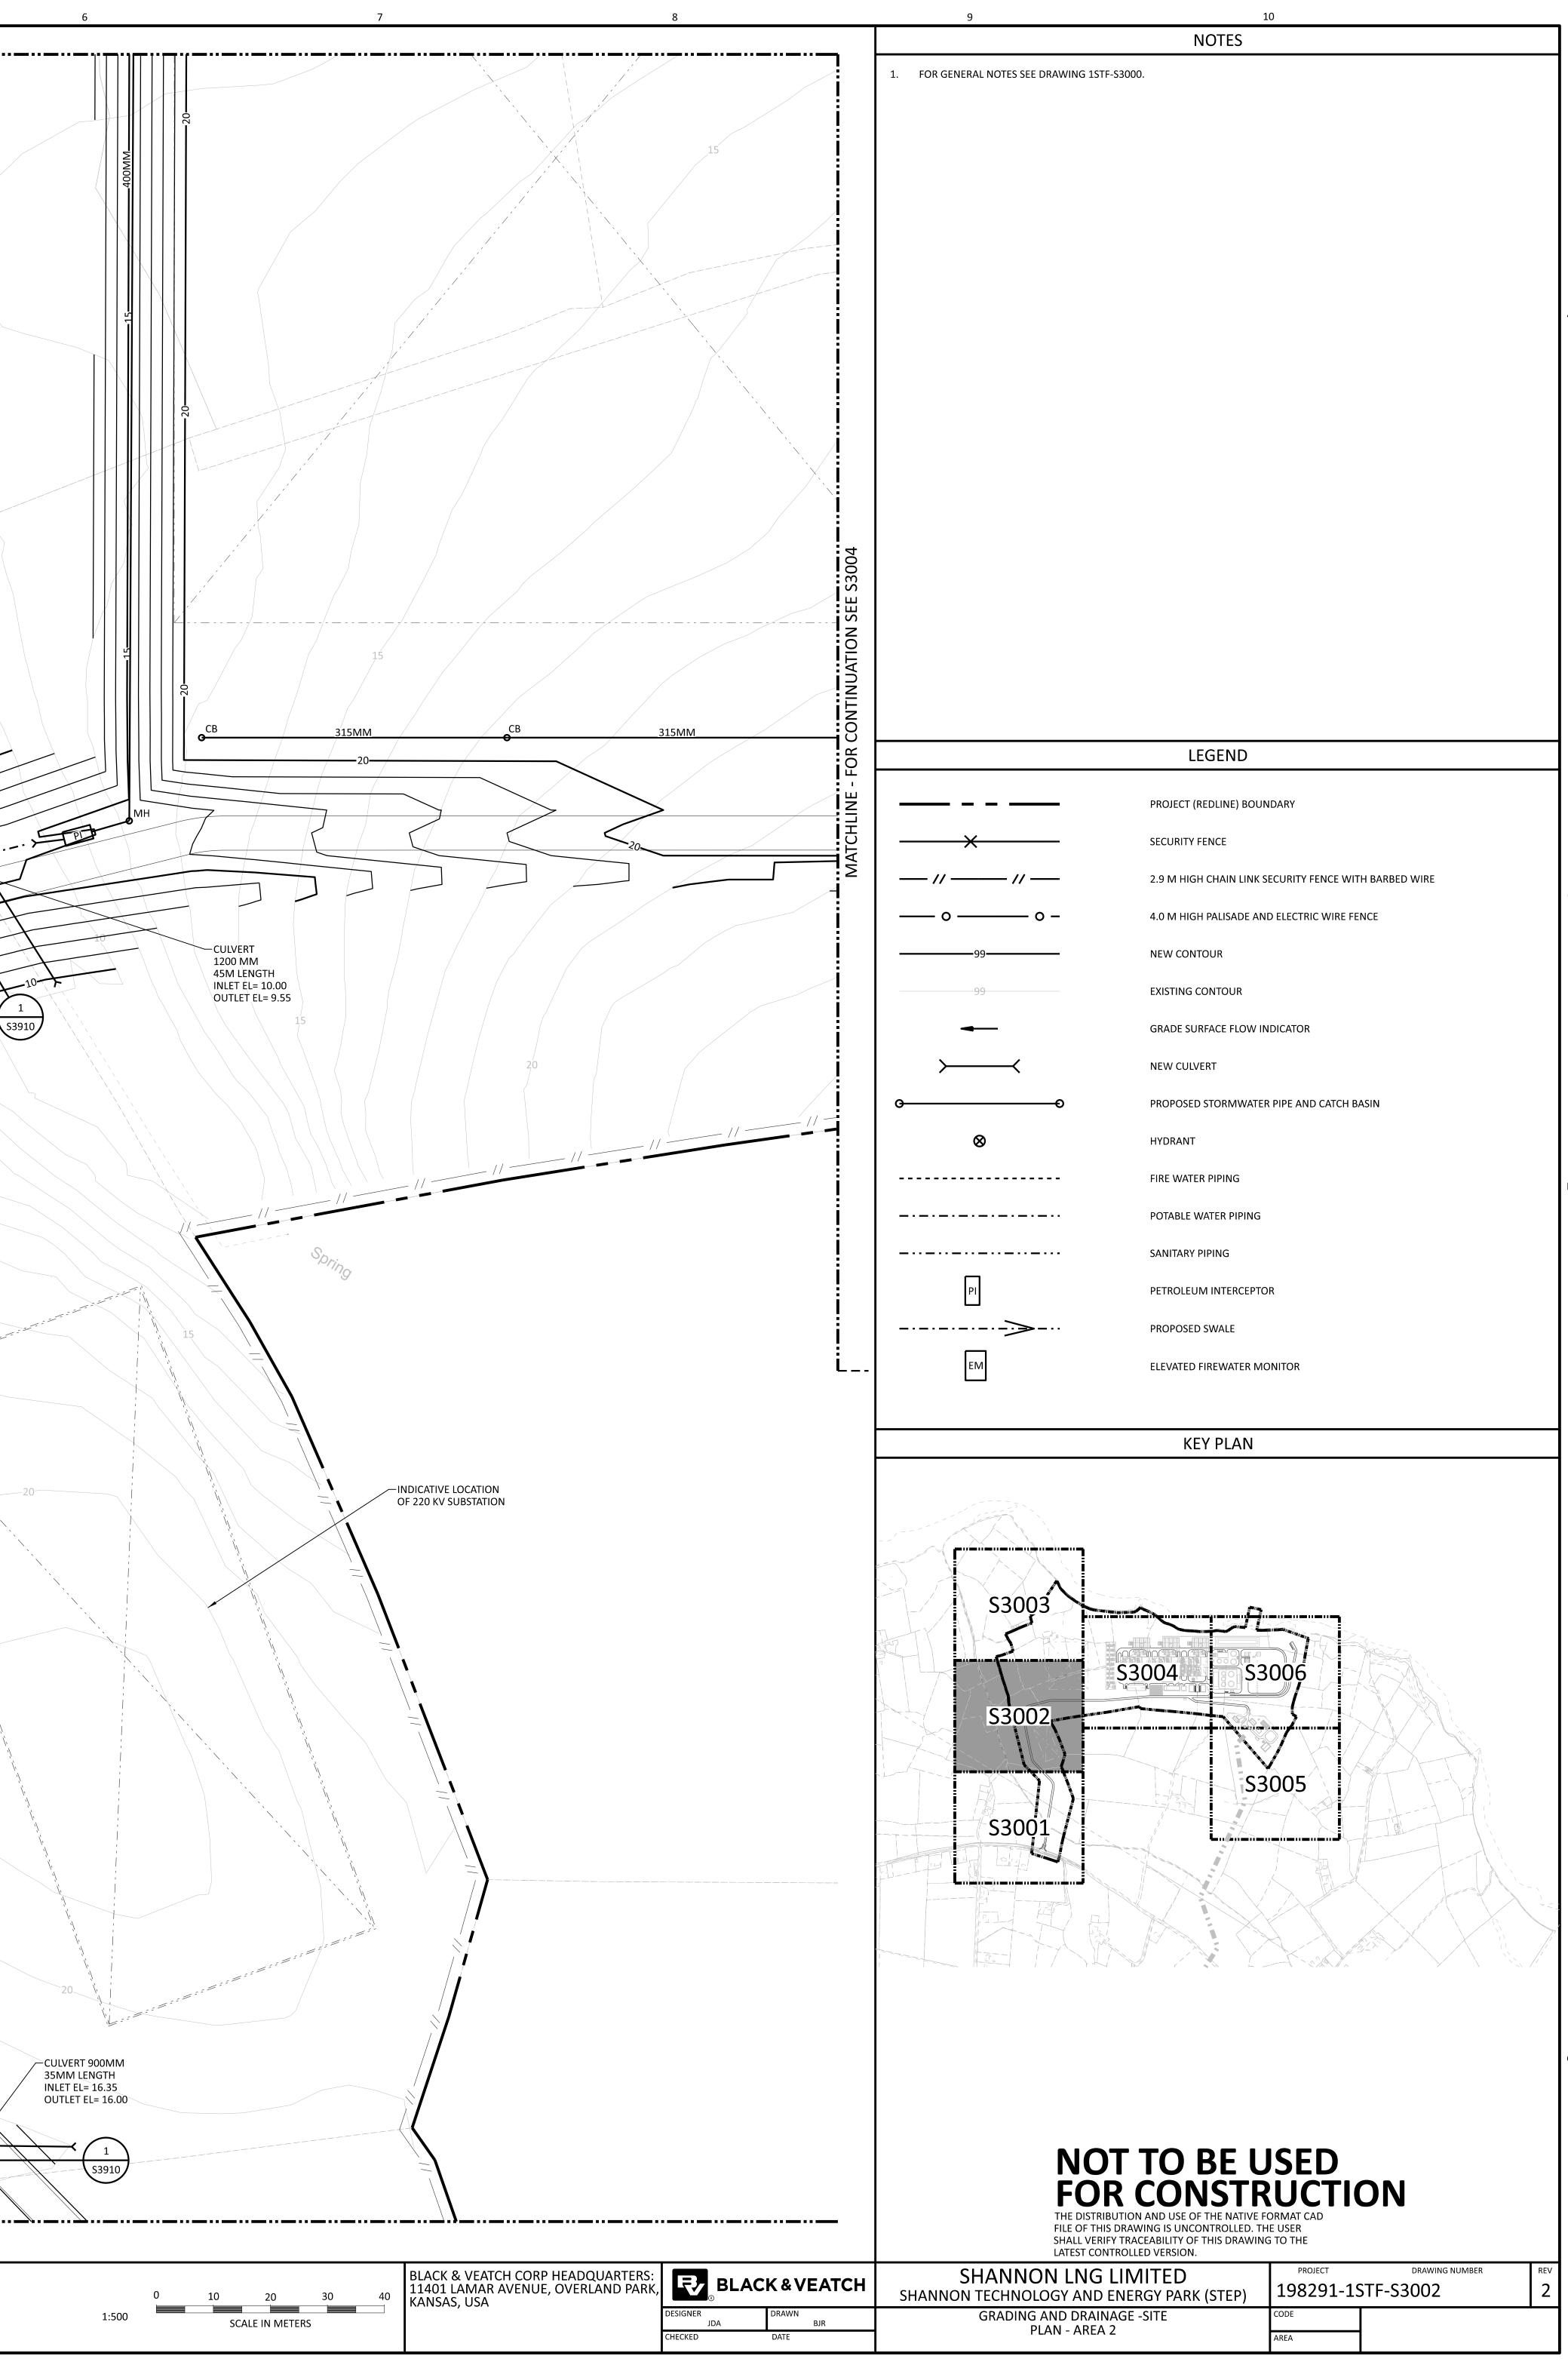
FILE OF THIS DRAWING IS UNCONTROLLED. THE USER SHALL VERIFY TRACEABILITY OF THIS DRAWING TO THE LATEST CONTROLLED VERSION.											
SHANNON LNG LIMITED ANNON TECHNOLOGY AND ENERGY PARK (STEP)	PROJECT 198291-15	drawing number STF-S3001	<sup>REV</sup>								
GRADING AND DRAINAGE - SITE PLAN - AREA 1	CODE										



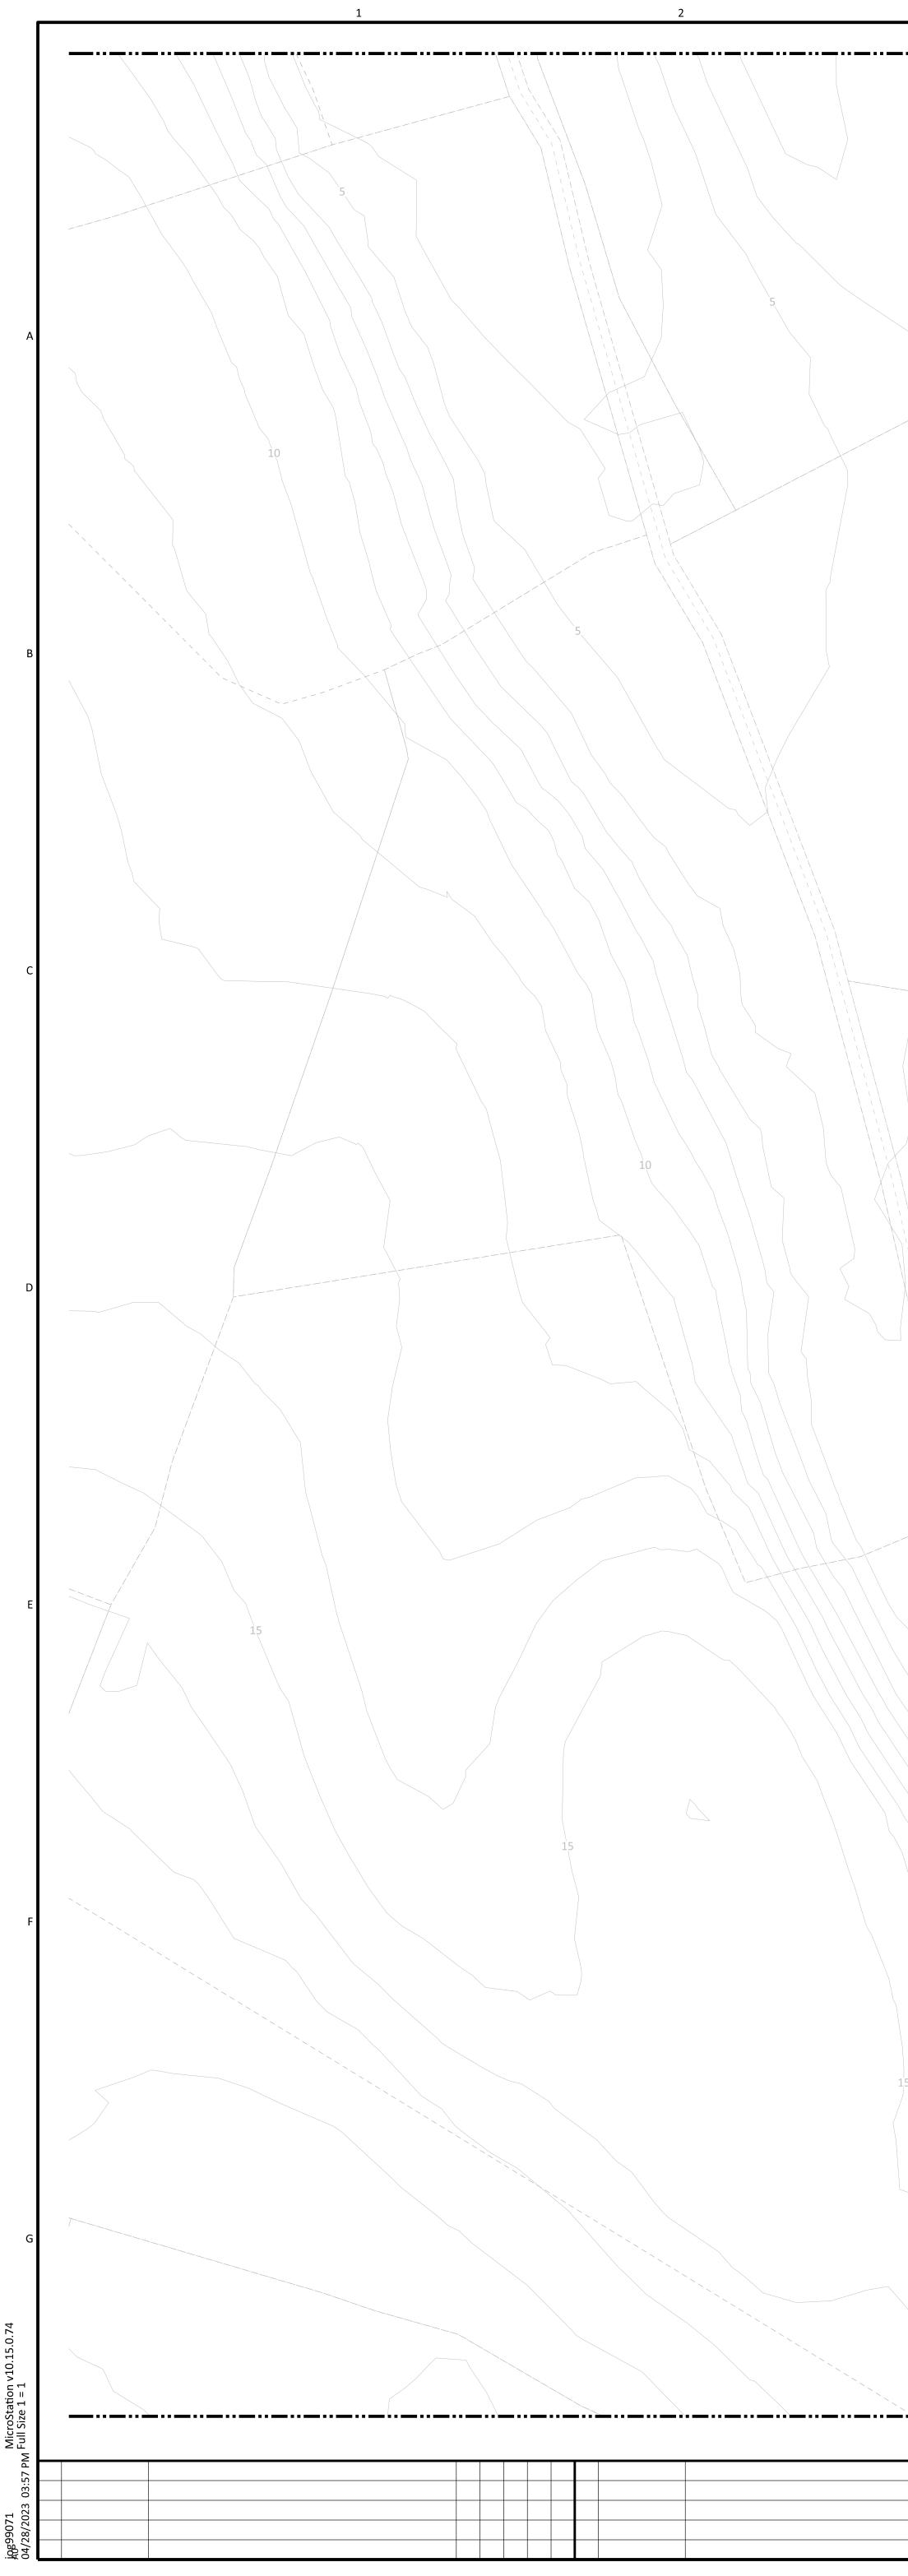


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			NO	DATE	REVISIONS AND RECORD OF ISSUE	DRN	DES	СНК	PDE APP	




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SHANNON LNG LIMITED	PROJECT	DRAWING NUMBER

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SHANNON LNG LIMITED	PROJECT	DRAWING NUMBER	REV
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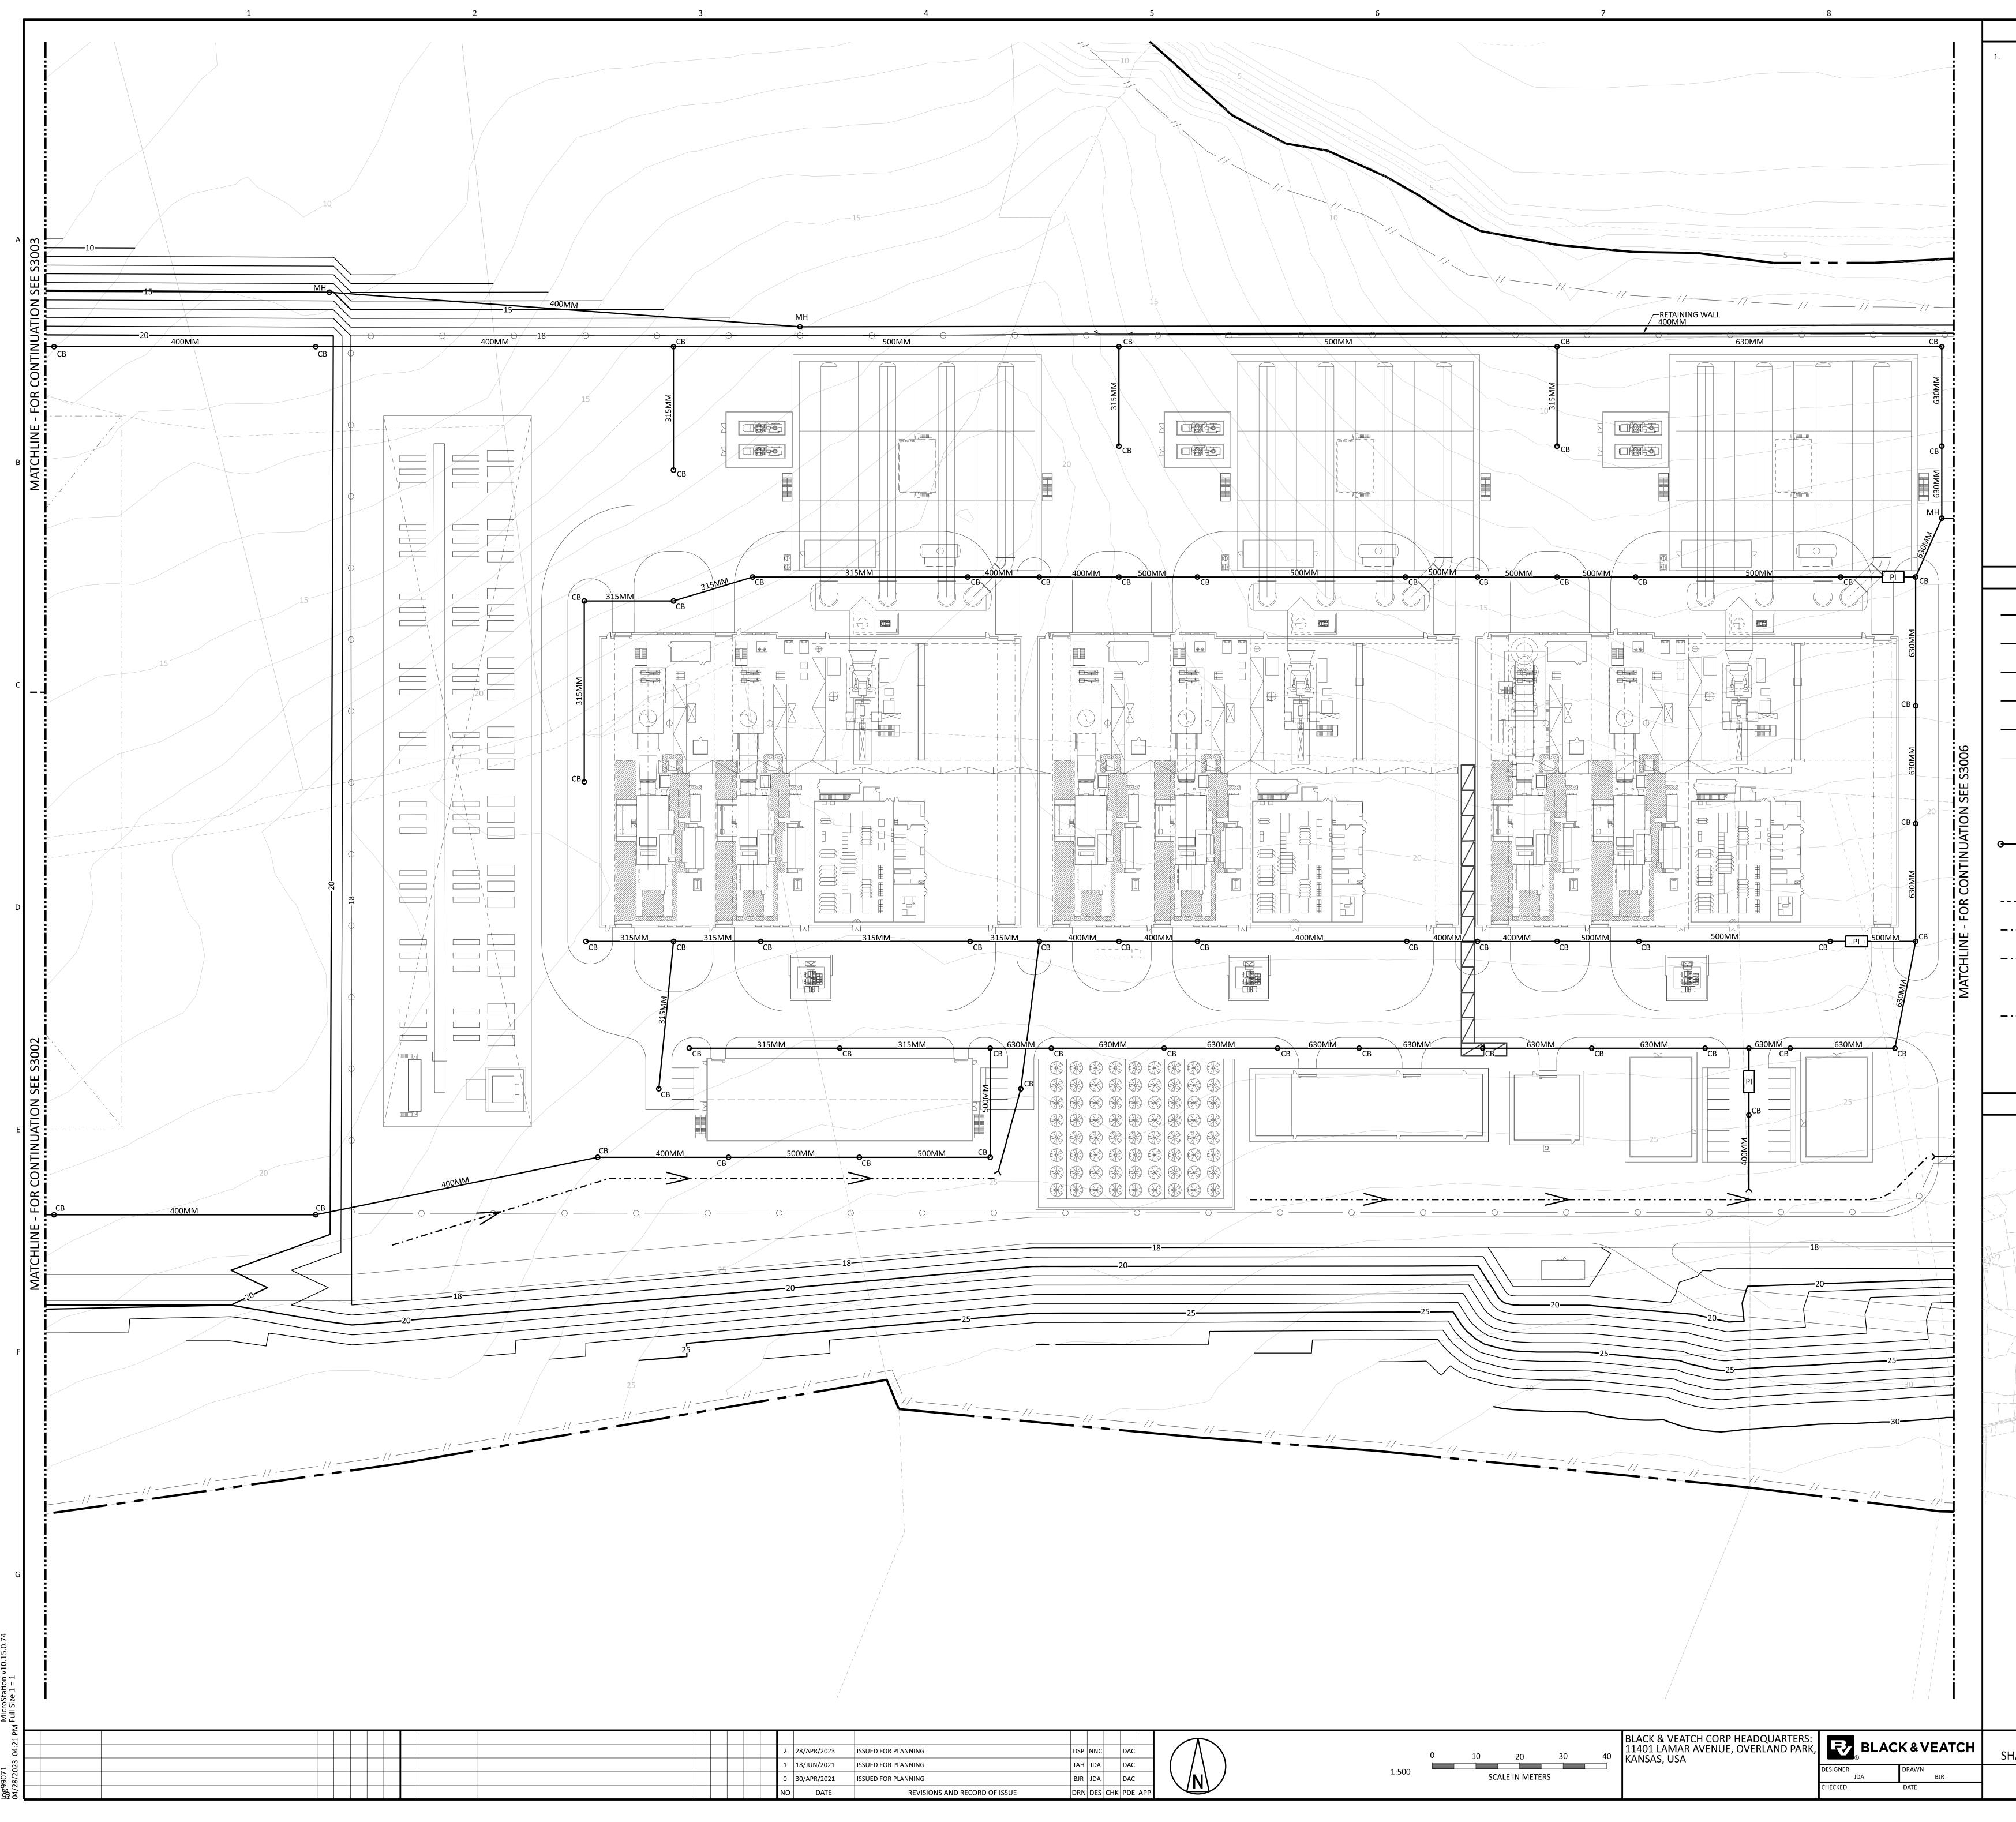


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			NO	DATE	REVISIONS AND RECORD OF ISSUE	DRN	DES	СНК	PDE	APP	

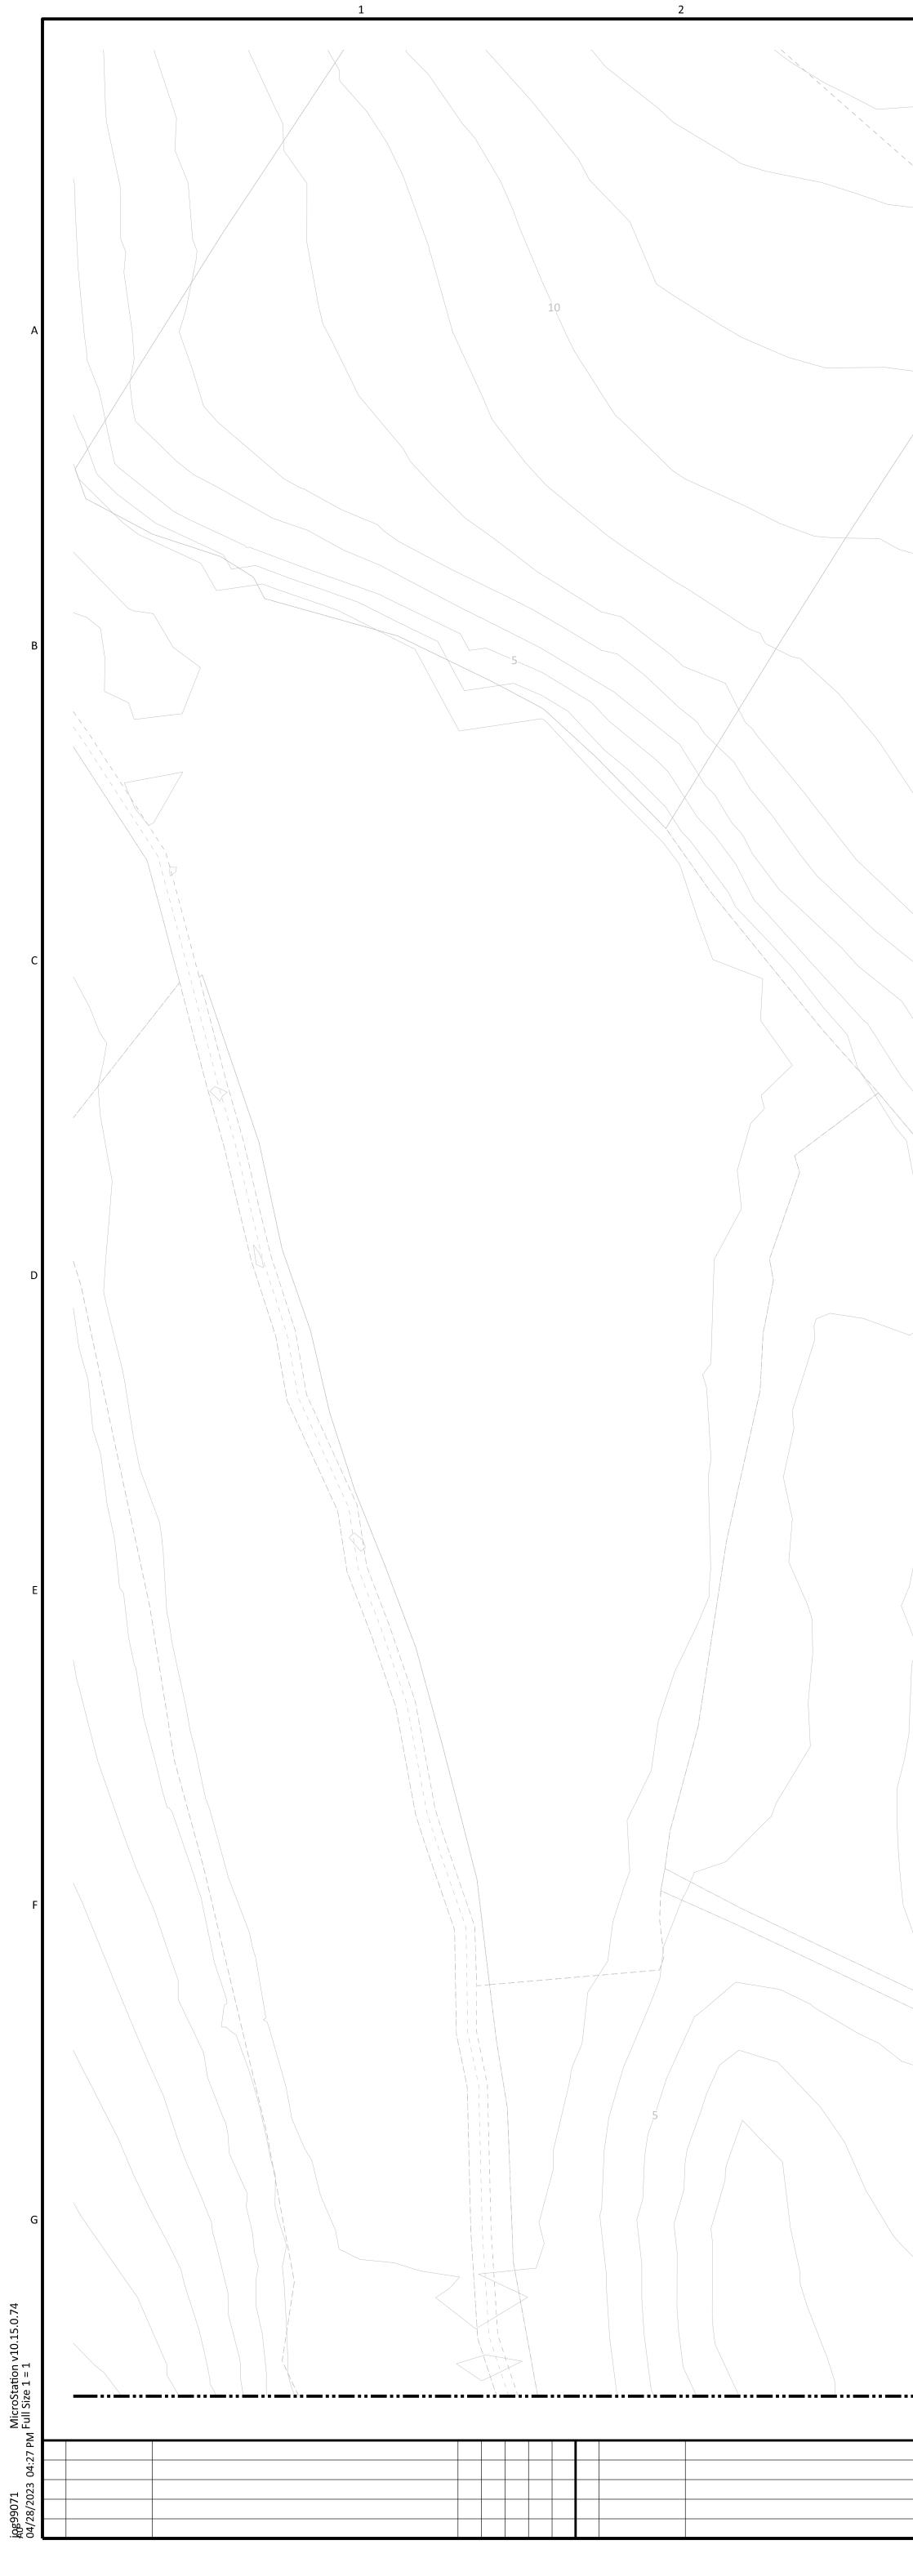

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SHANNON LNG LIMITED			F

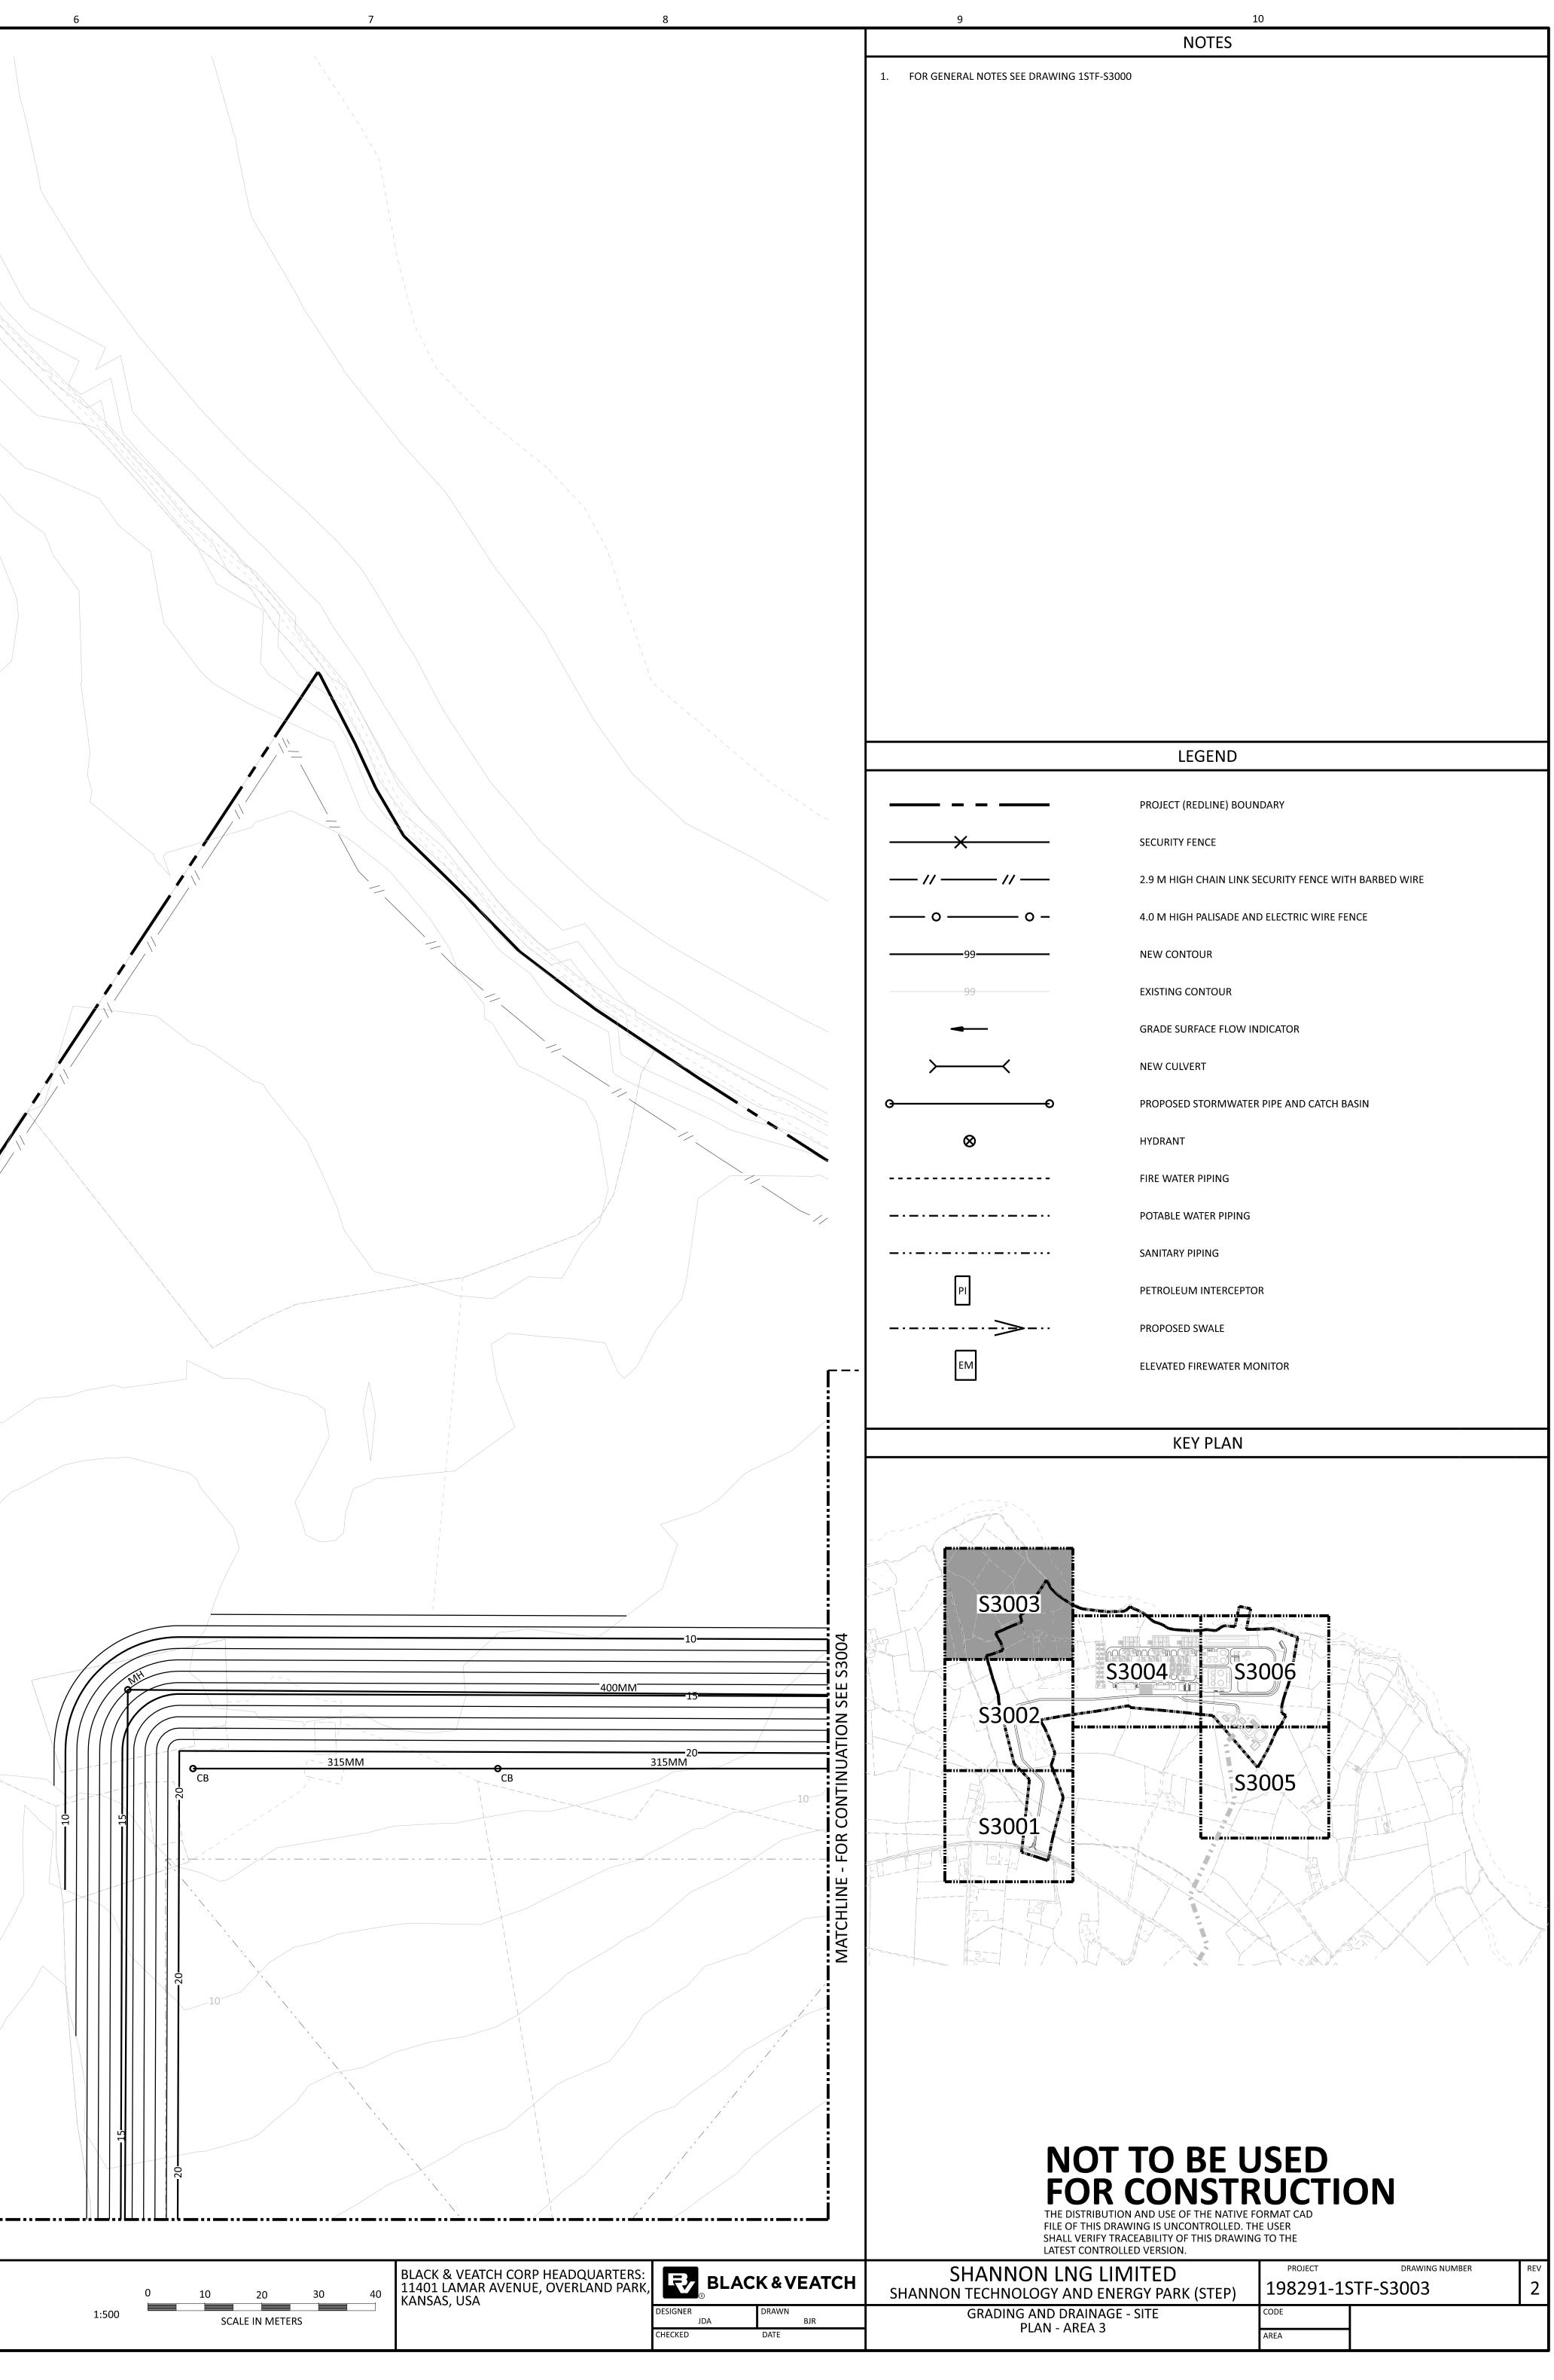

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SHANNON LNG LIMITED	PROJECT	drawing number
SHANNON TECHNOLOGY AND ENERGY PARK (STEP)	198291-15	TF-S3004

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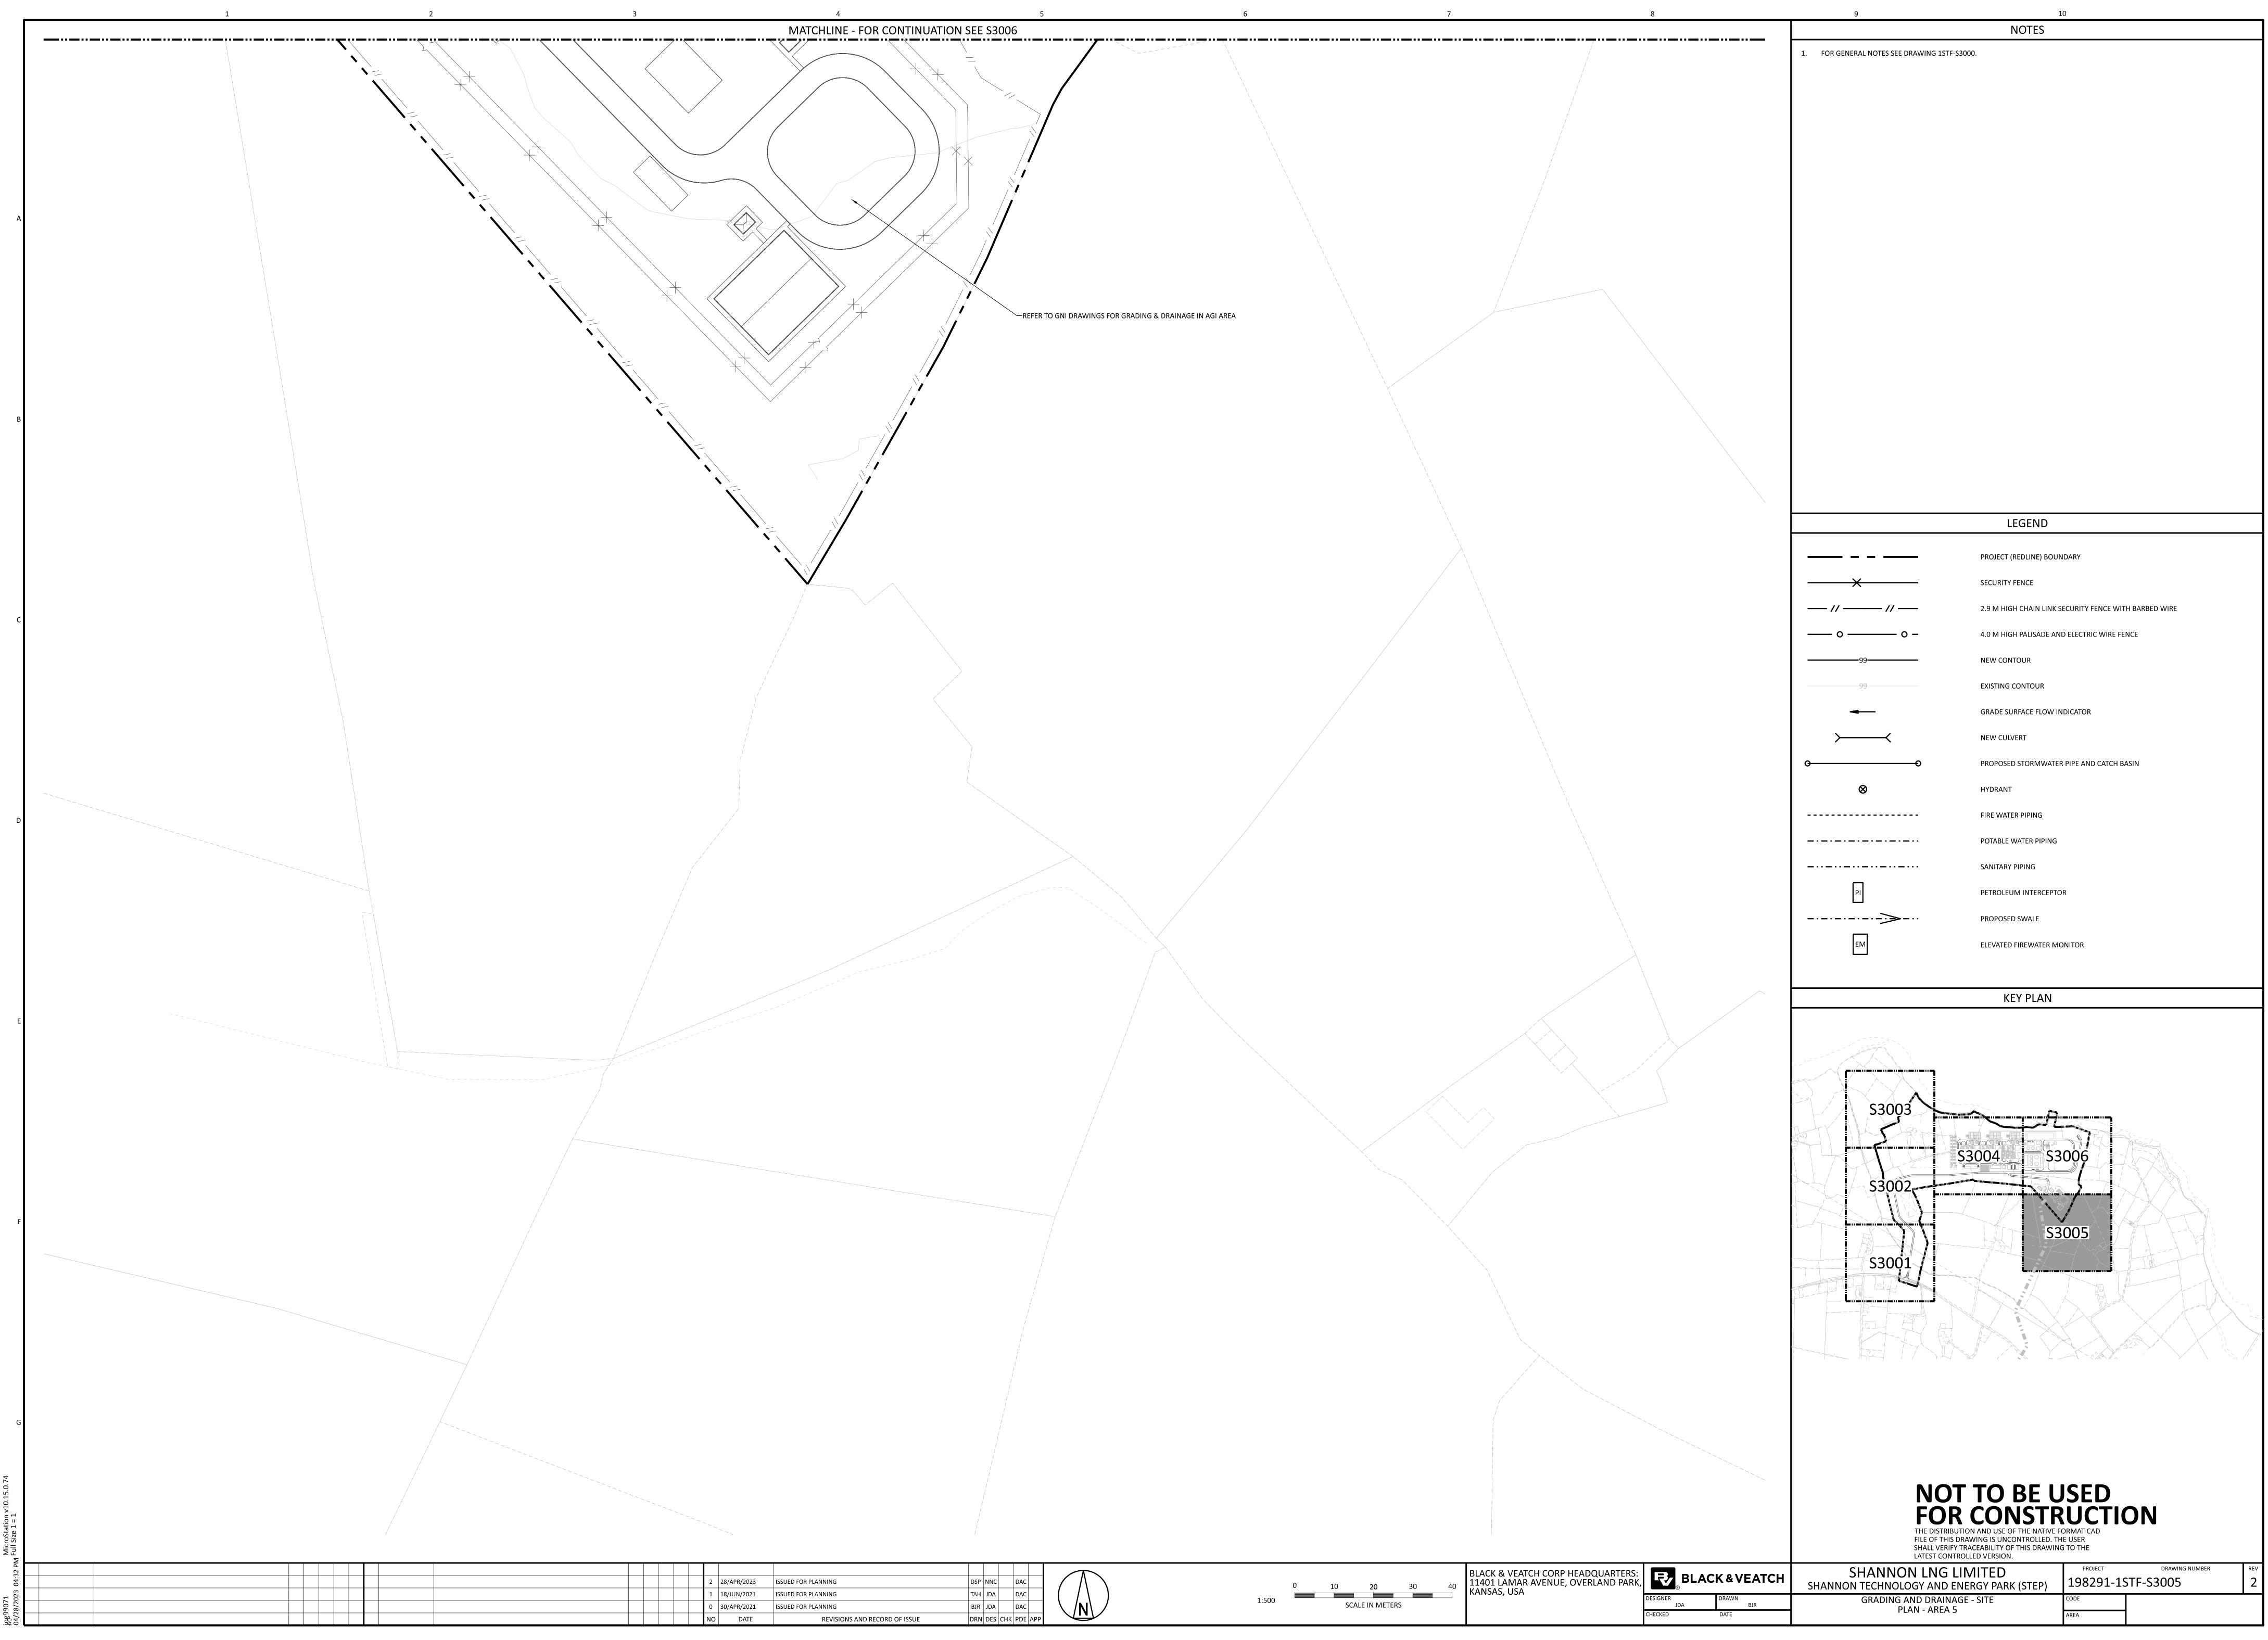
GRADING AND DRAINAGE - SITE PLAN - AREA 4

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S3002,	S3004 S3006
33002	S3005
S3001	


## KEY PLAN

	LEGEND	
	PROJECT (REDLINE) BOUNDARY	
——————————————————————————————————————	SECURITY FENCE	
// //	2.9 M HIGH CHAIN LINK SECURITY FENCE WITH BARBED WIRE	с
—— o —— o –	4.0 M HIGH PALISADE AND ELECTRIC WIRE FENCE	
99	NEW CONTOUR	
99	EXISTING CONTOUR	
	GRADE SURFACE FLOW INDICATOR	
$\rightarrow$	NEW CULVERT	
θθ	PROPOSED STORMWATER PIPE AND CATCH BASIN	
$\otimes$	HYDRANT	
	FIRE WATER PIPING	D
	POTABLE WATER PIPING	
	SANITARY PIPING	
PI	PETROLEUM INTERCEPTOR	
>	PROPOSED SWALE	
EM	ELEVATED FIREWATER MONITOR	

LEGEND




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ANNON LNG LIMITED	PROJECT	DRAWING NUMBER	REV				
CHNOLOGY AND ENERGY PARK (STEP)	198291-1STF-S3006						
RADING AND DRAINAGE - SITE	CODE						
PLAN - AREA 6	AREA						

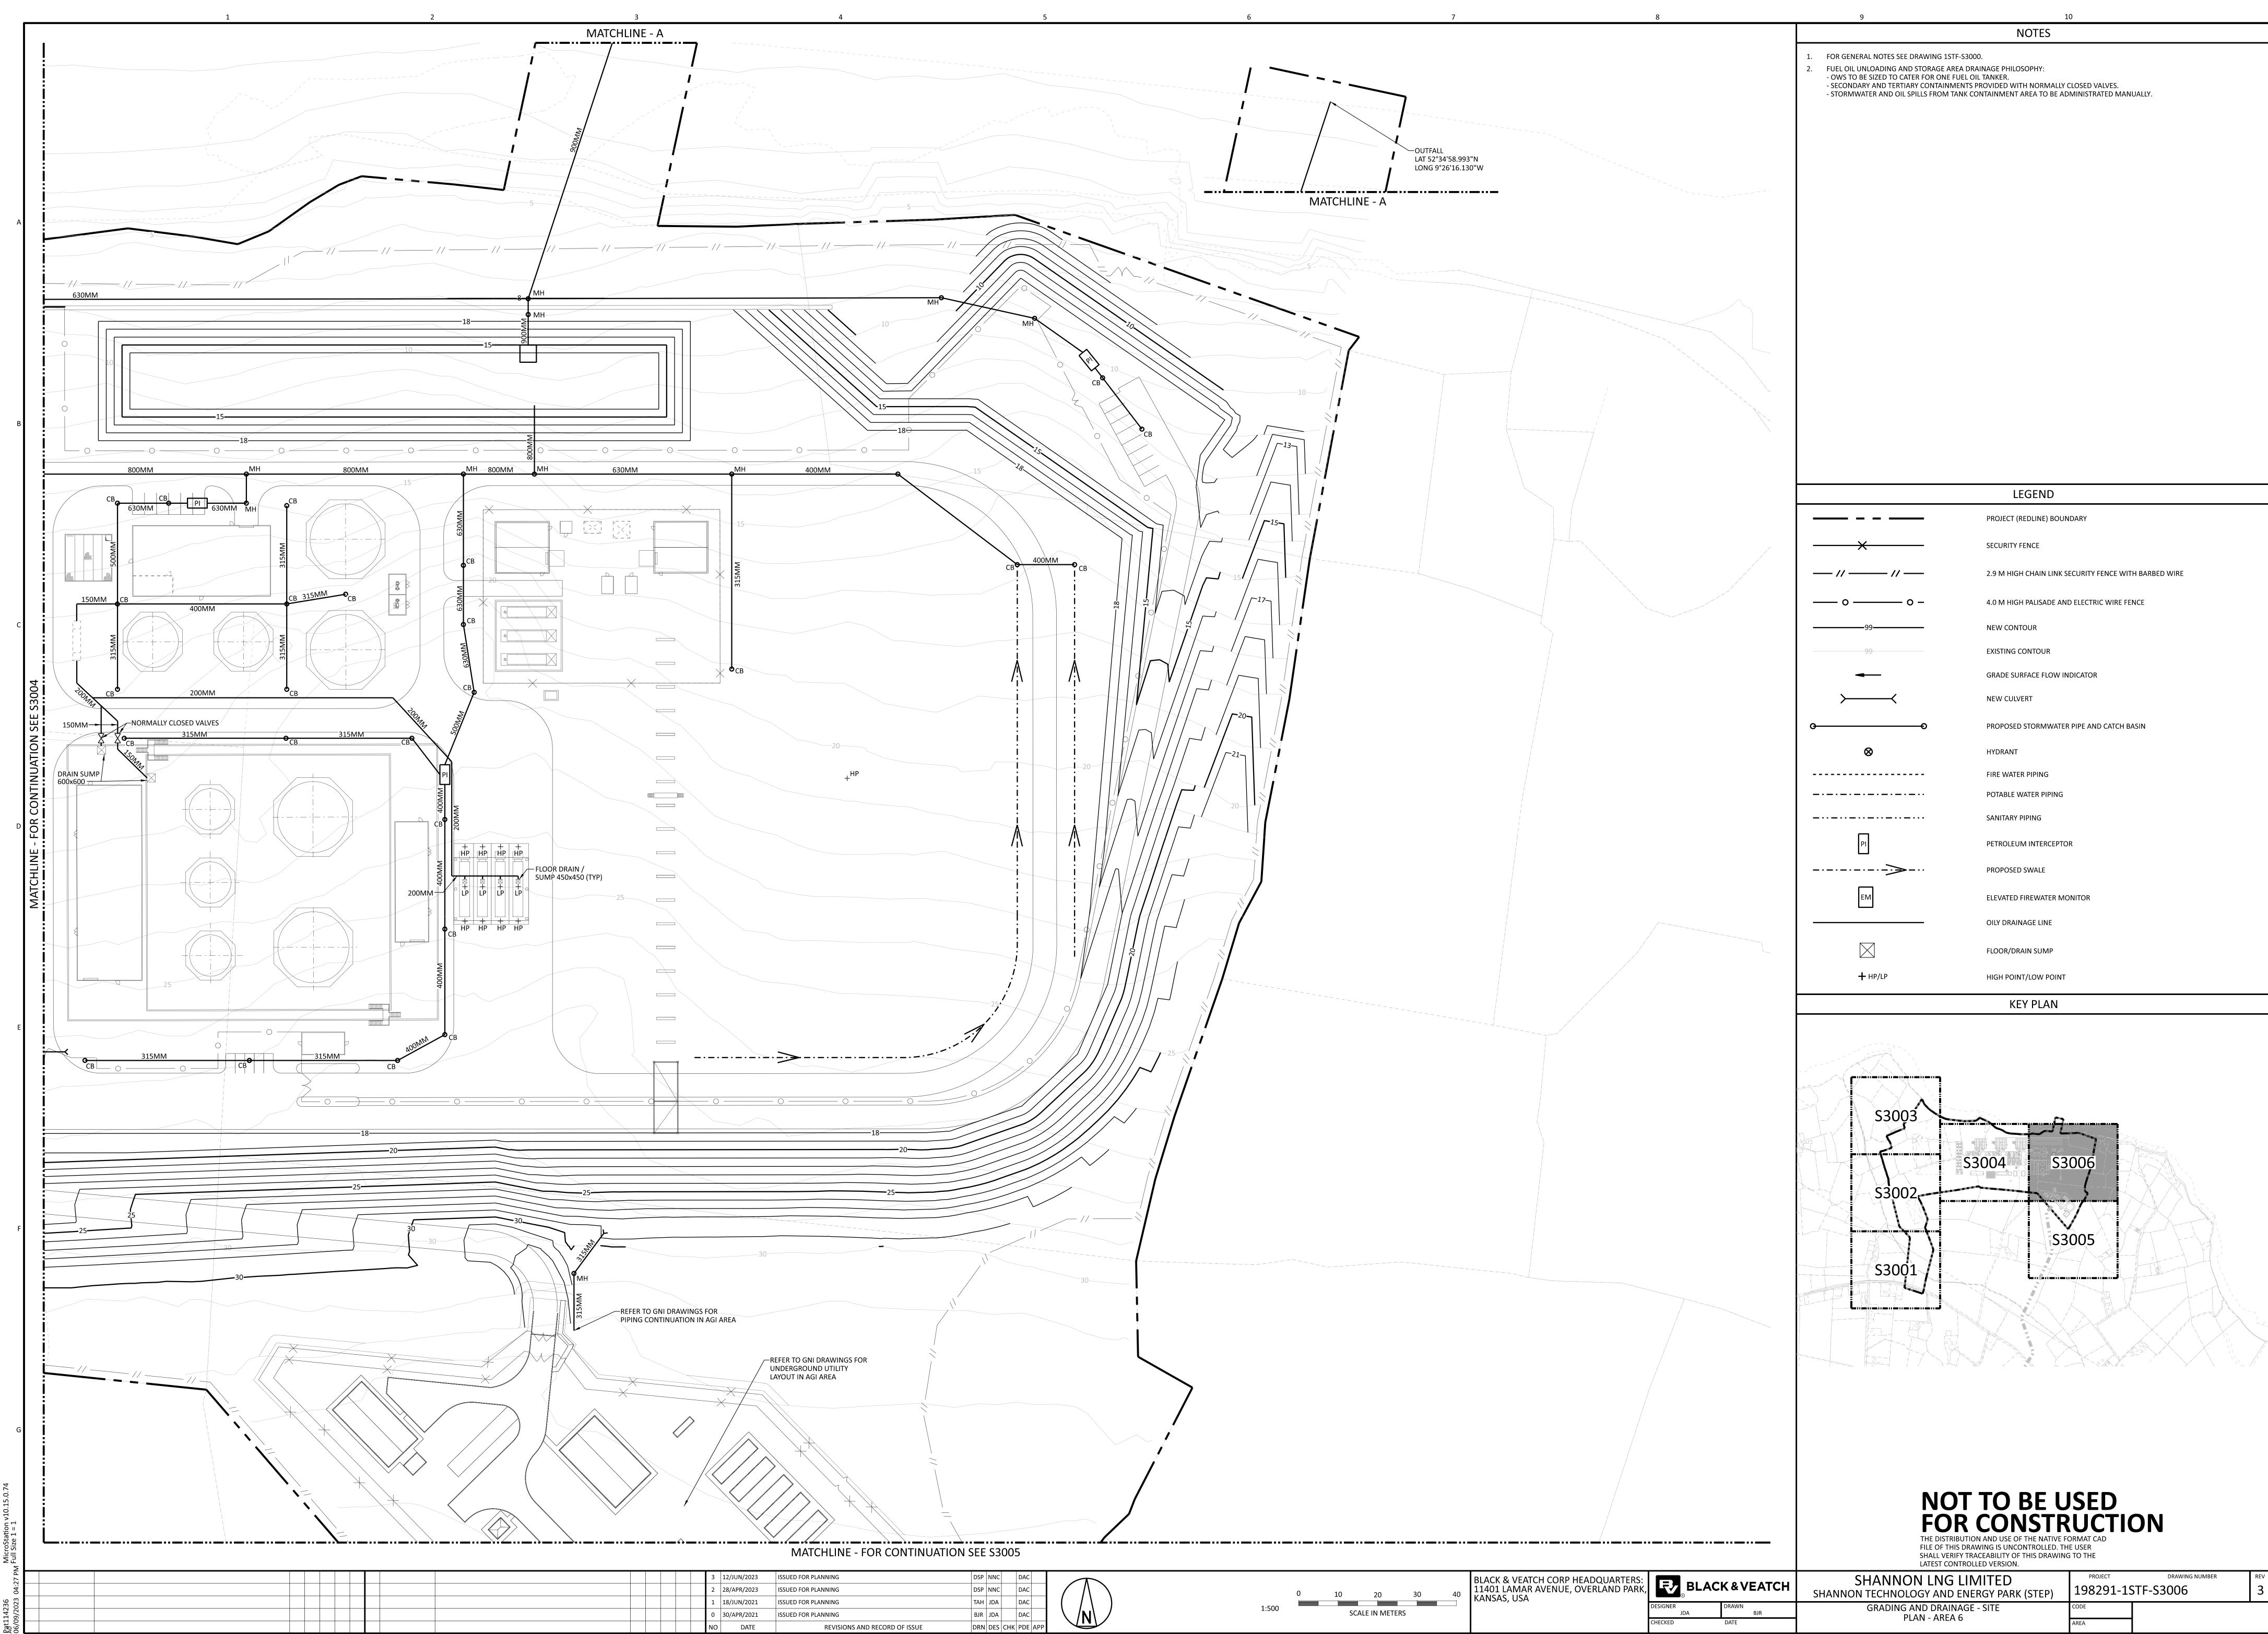

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FILE OF THIS DRAWING IS UNCONTROLLED. TH SHALL VERIFY TRACEABILITY OF THIS DRAWING LATEST CONTROLLED VERSION.			
SHANNON LNG LIMITED NON TECHNOLOGY AND ENERGY PARK (STEP)	PROJECT	DRAWING NUMBER	<sup>REV</sup>
SANITARY LAYOUT - SITE PLAN - AREA 1	CODE	S3301A	

# NOT TO BE USED FOR CONSTRUCTION THE DISTRIBUTION AND USE OF THE NATIVE FORMAT CAD

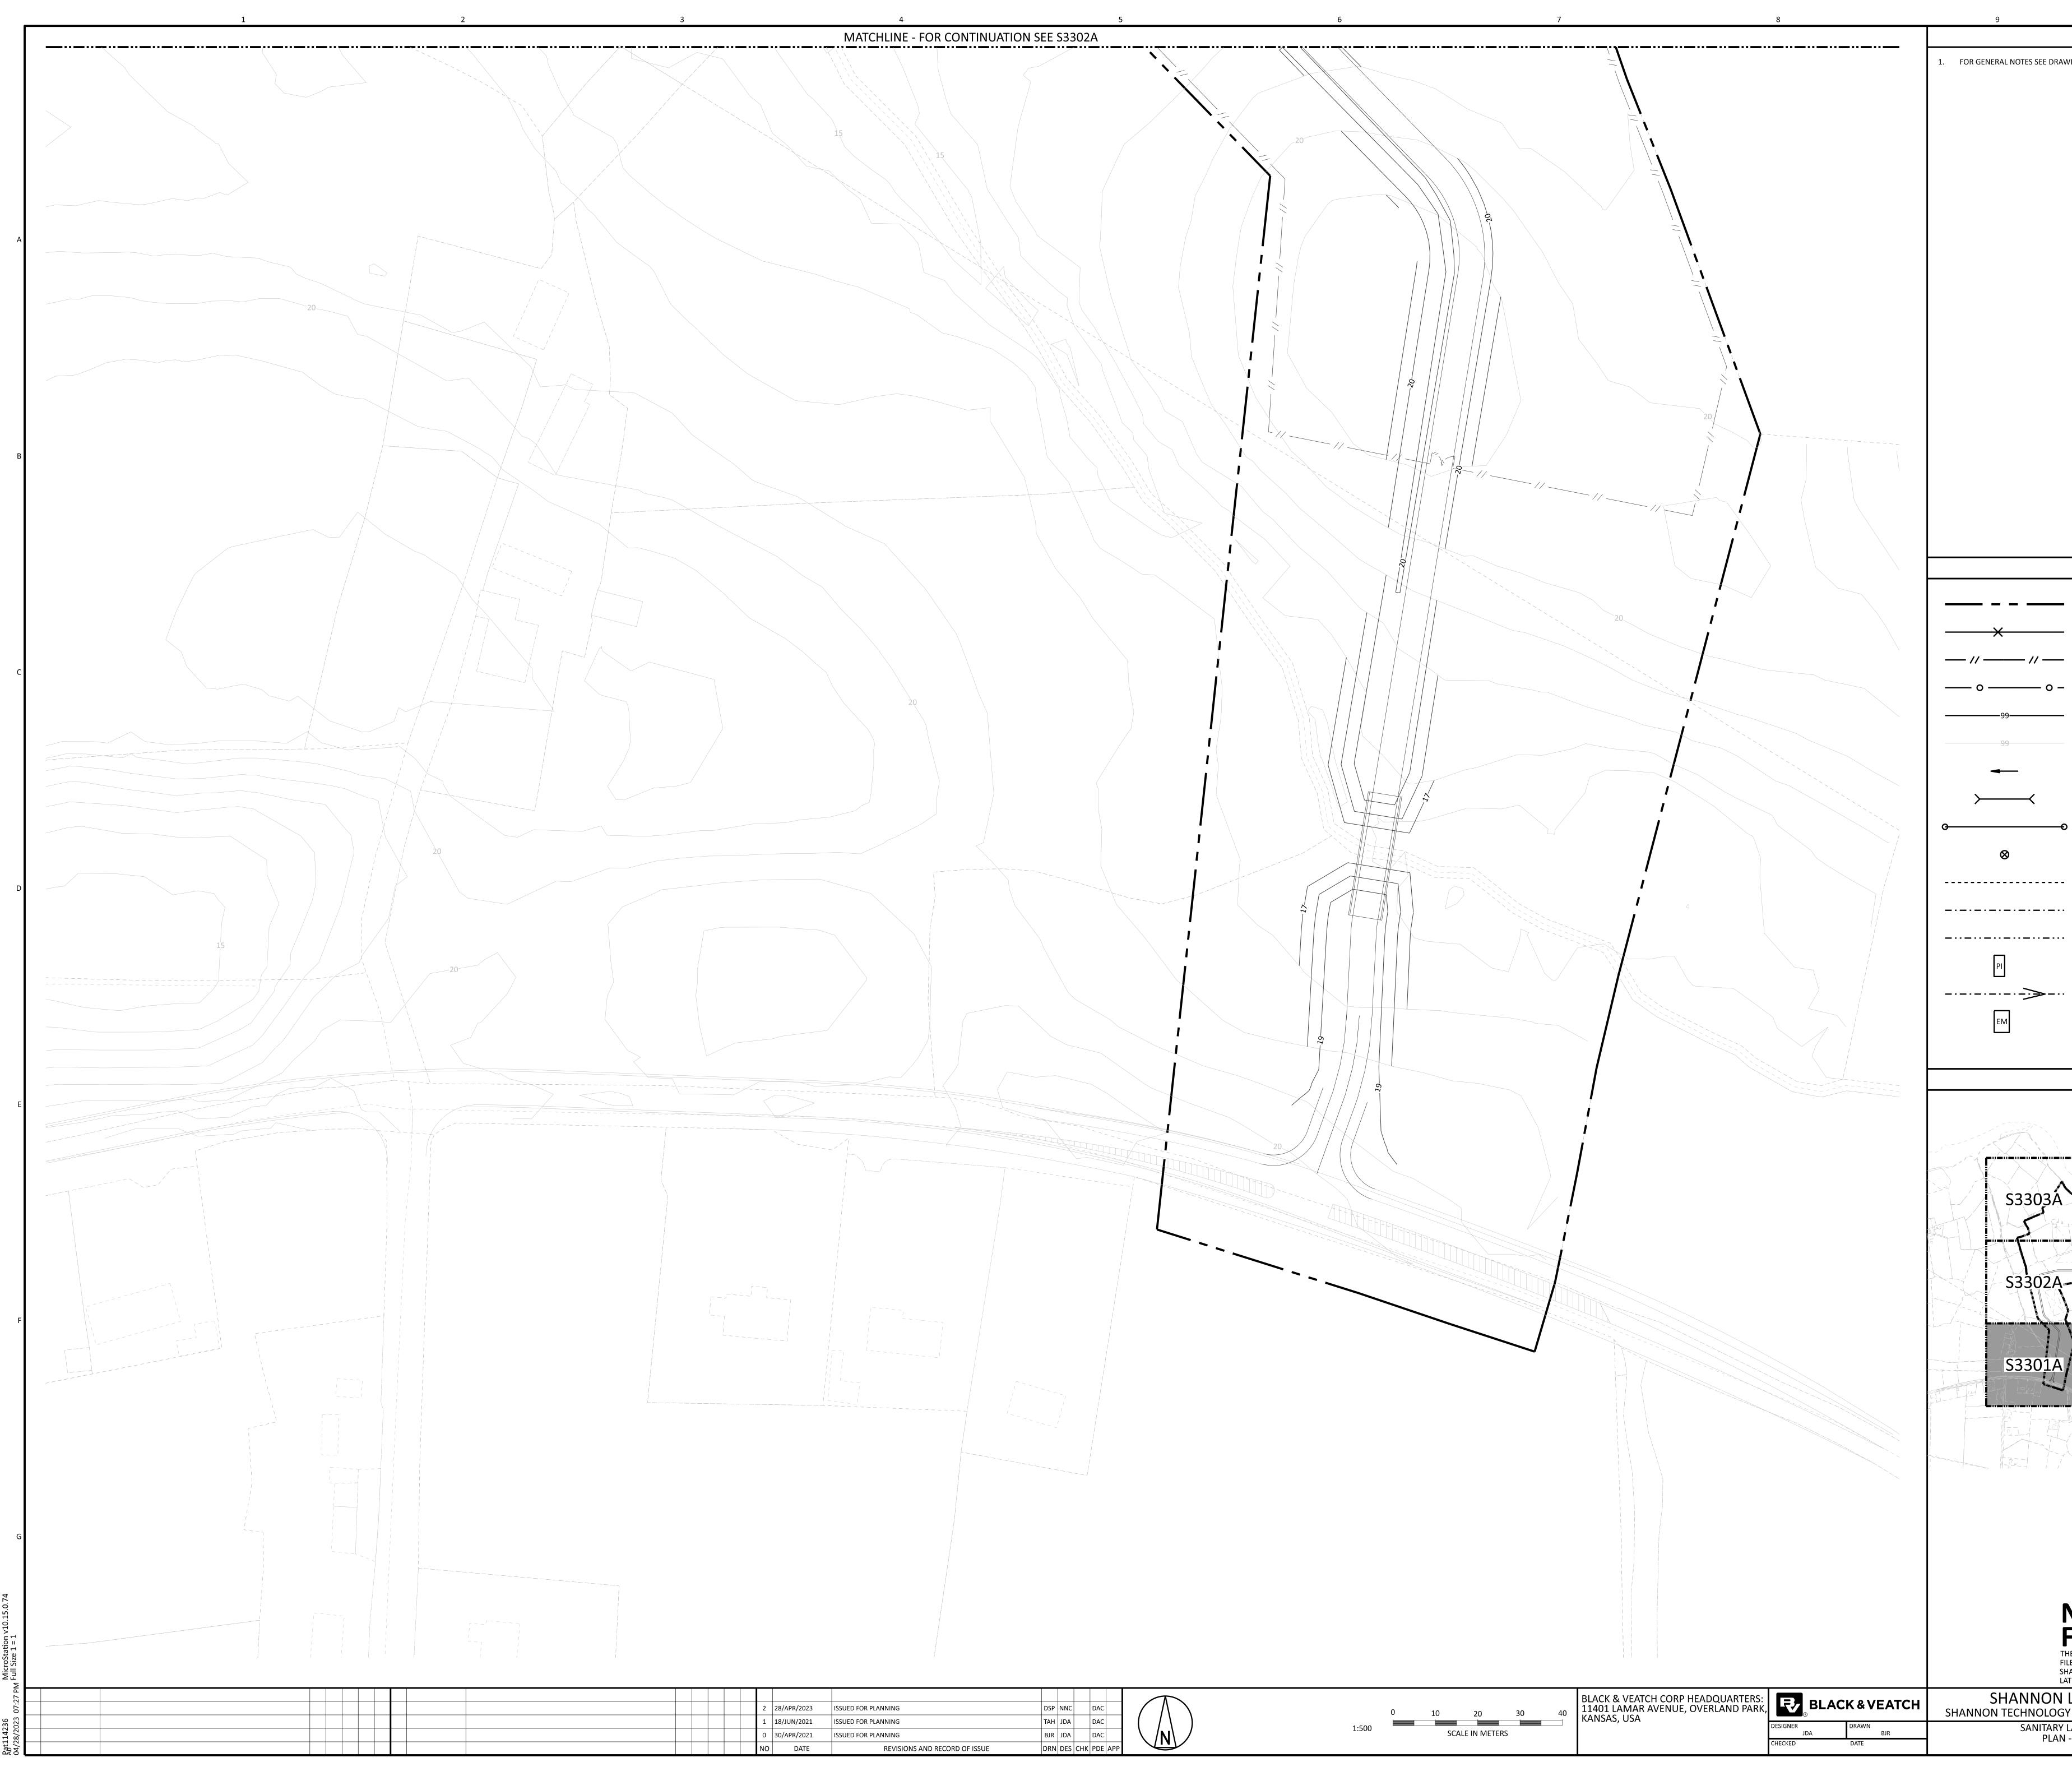$\prec$	NEW CULVERT
Θ	PROPOSED STORMWATER PIPE AND CATCH BASIN
	HYDRANT
	FIRE WATER PIPING
	POTABLE WATER PIPING
	SANITARY PIPING
	PETROLEUM INTERCEPTOR
->	PROPOSED SWALE
	ELEVATED FIREWATER MONITOR

KEY PLAN

S3300

S3305A

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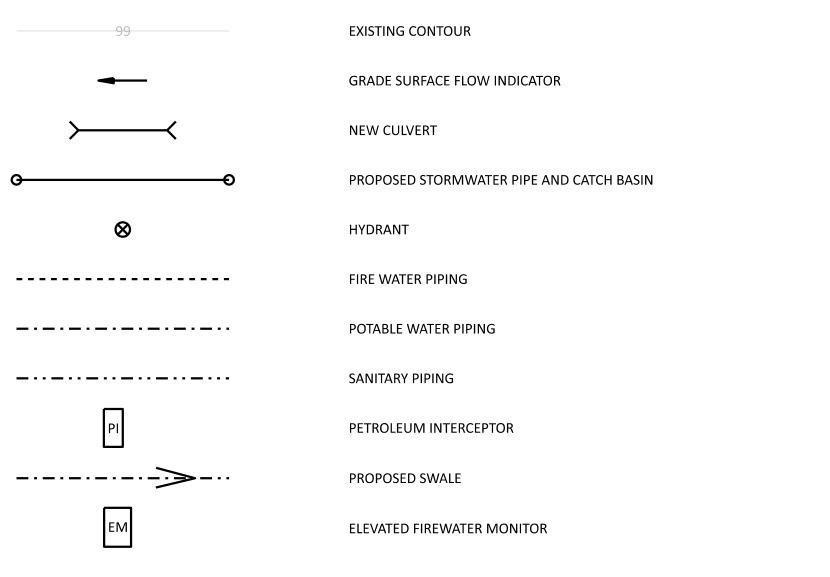
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S3304A



LEGEND

PROJECT (REDLINE) BOUNDARY


2.9 M HIGH CHAIN LINK SECURITY FENCE WITH BARBED WIRE

4.0 M HIGH PALISADE AND ELECTRIC WIRE FENCE

SECURITY FENCE


NEW CONTOUR

1. FOR GENERAL NOTES SEE DRAWING 1STF-S3000.

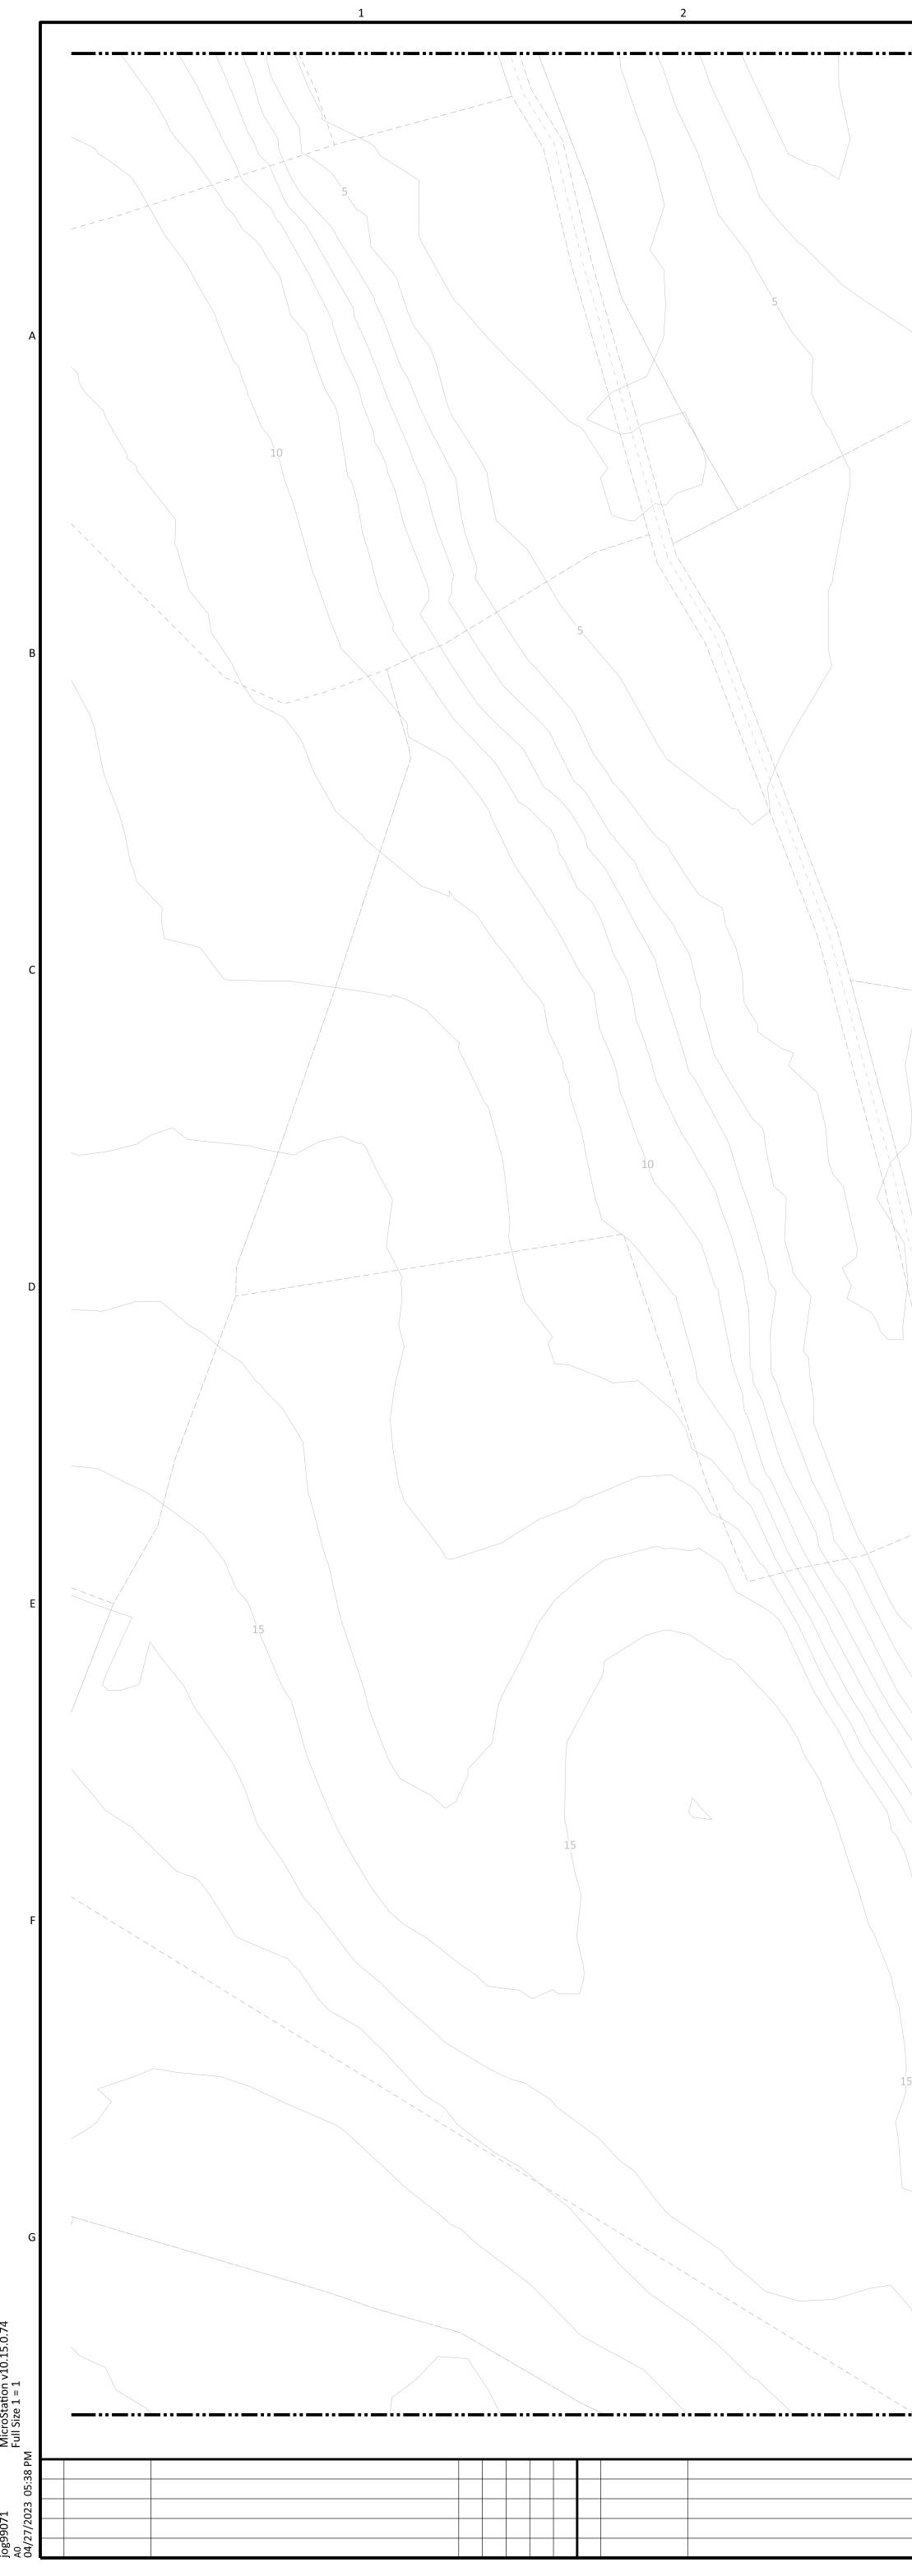


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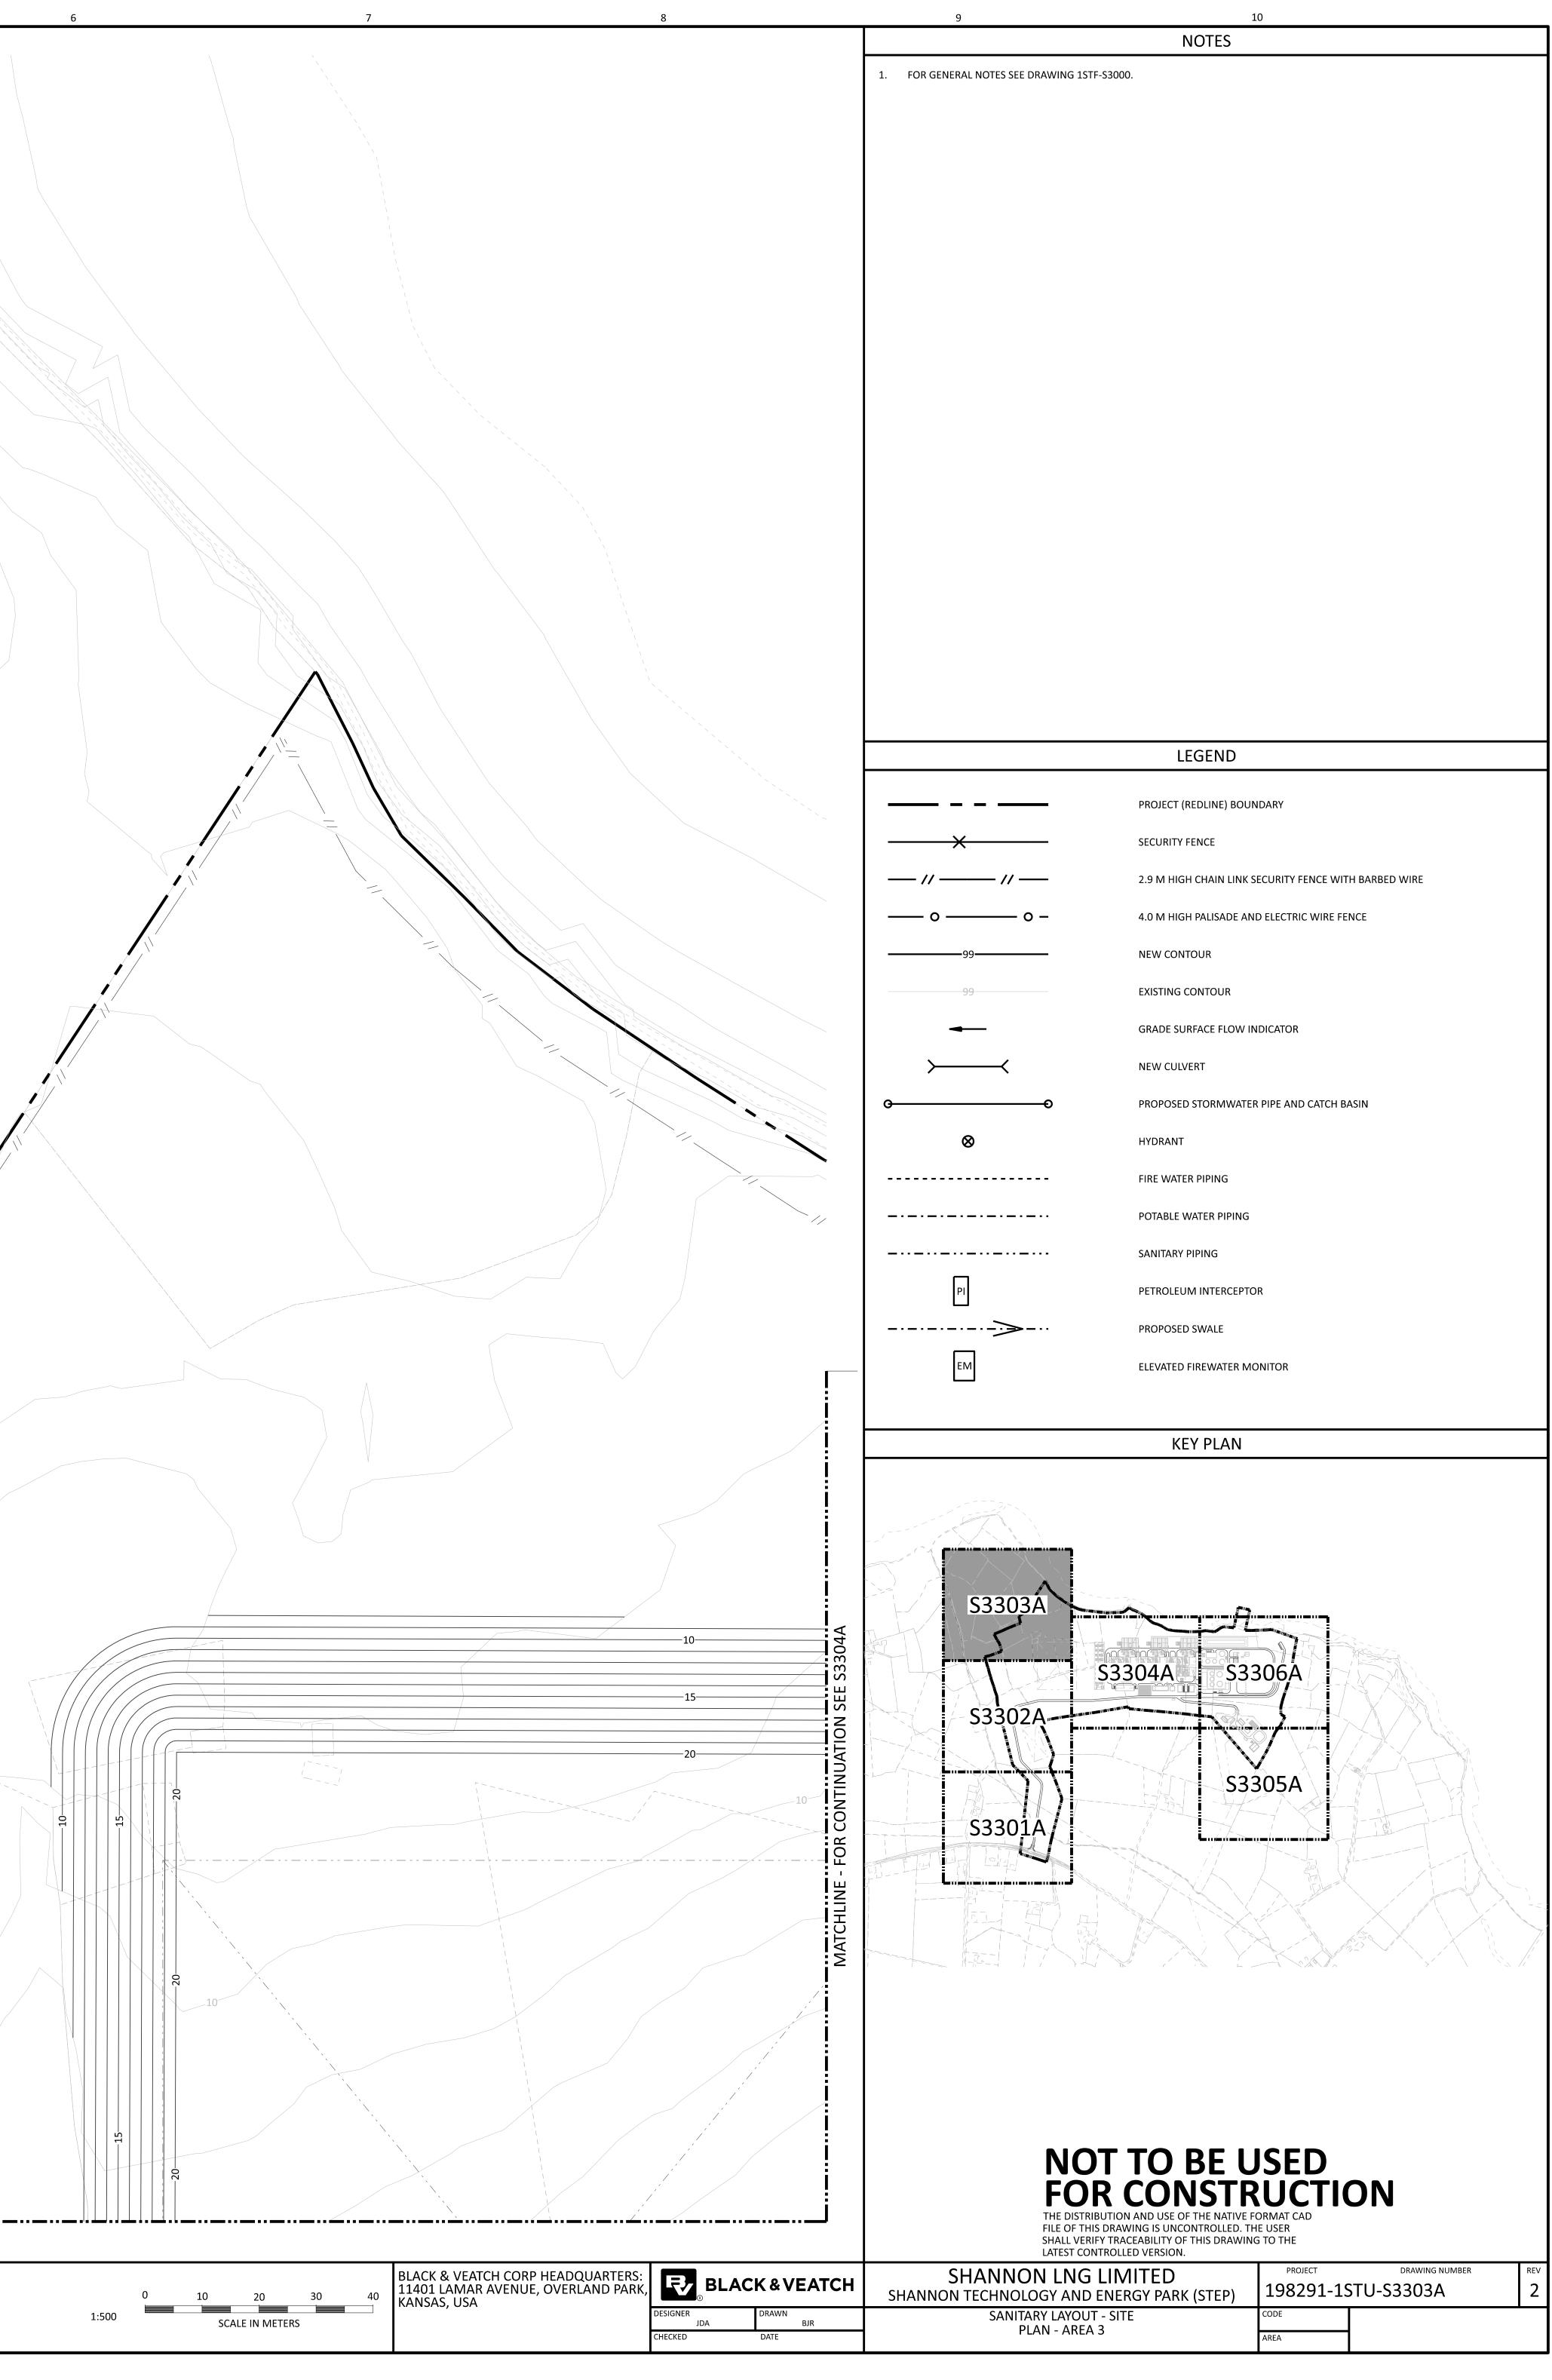
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SHANNON LNG LIMITED	PROJECT	DRAWING NUMBER	ſ

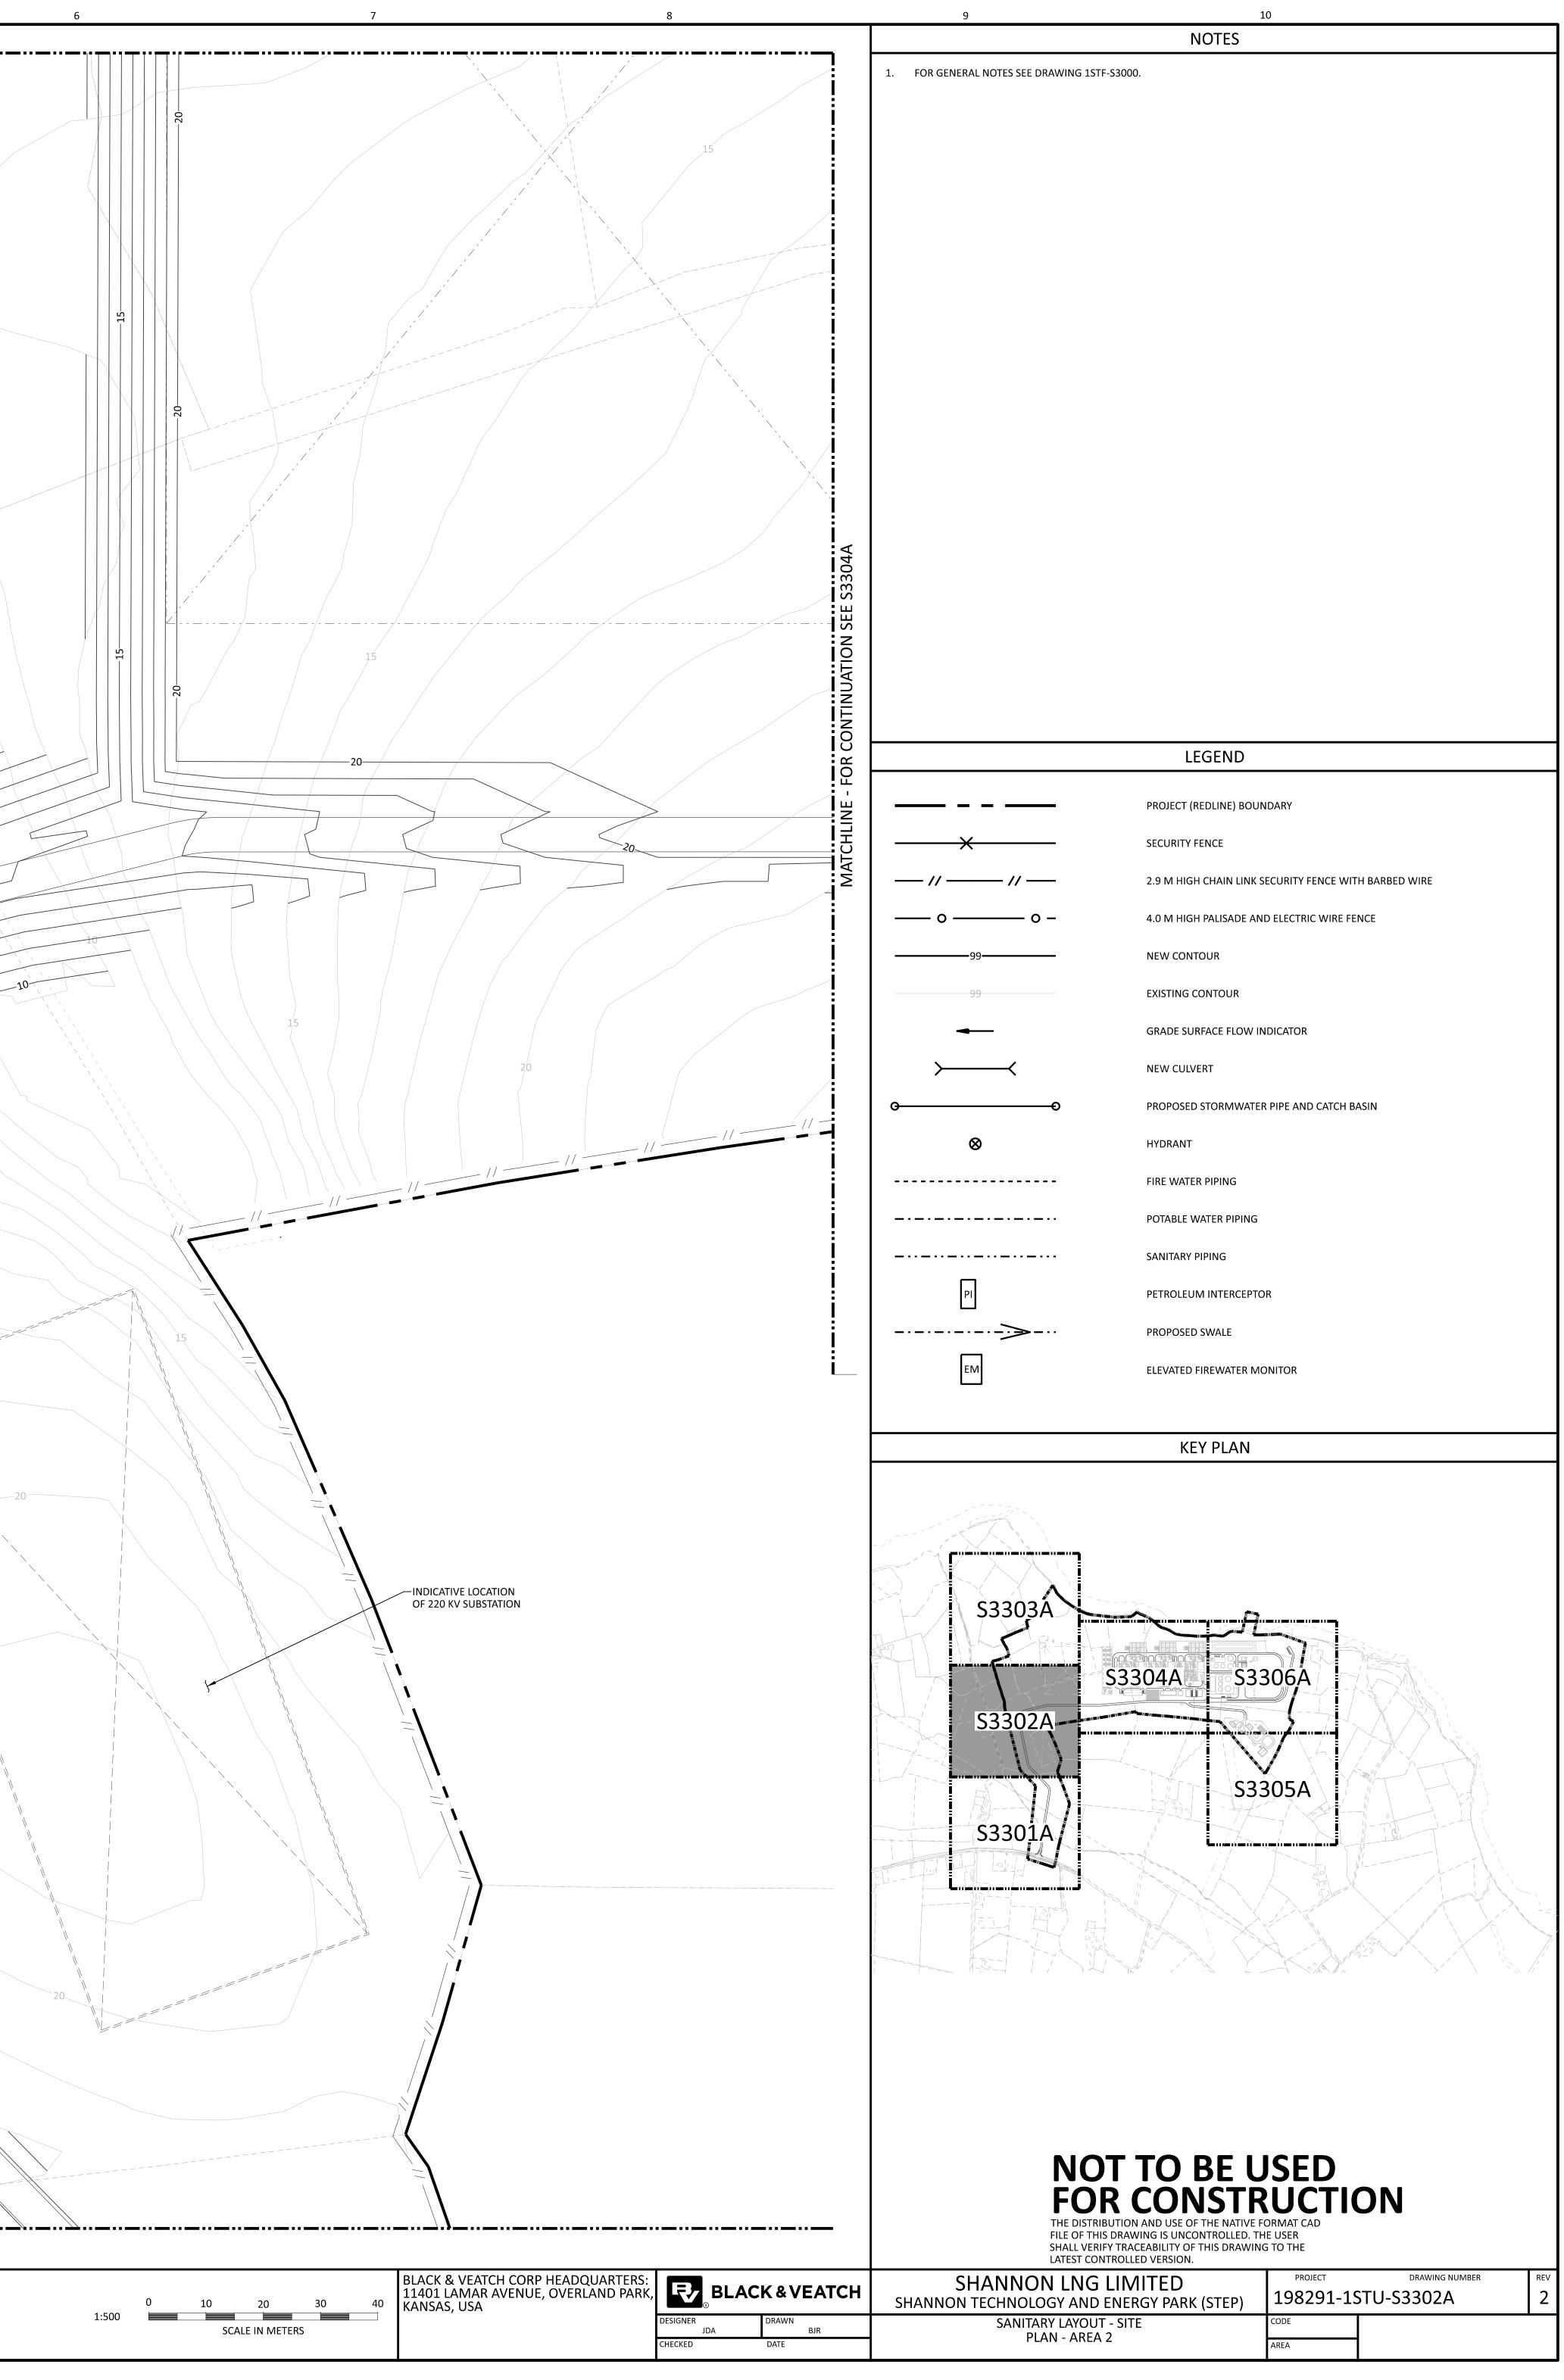


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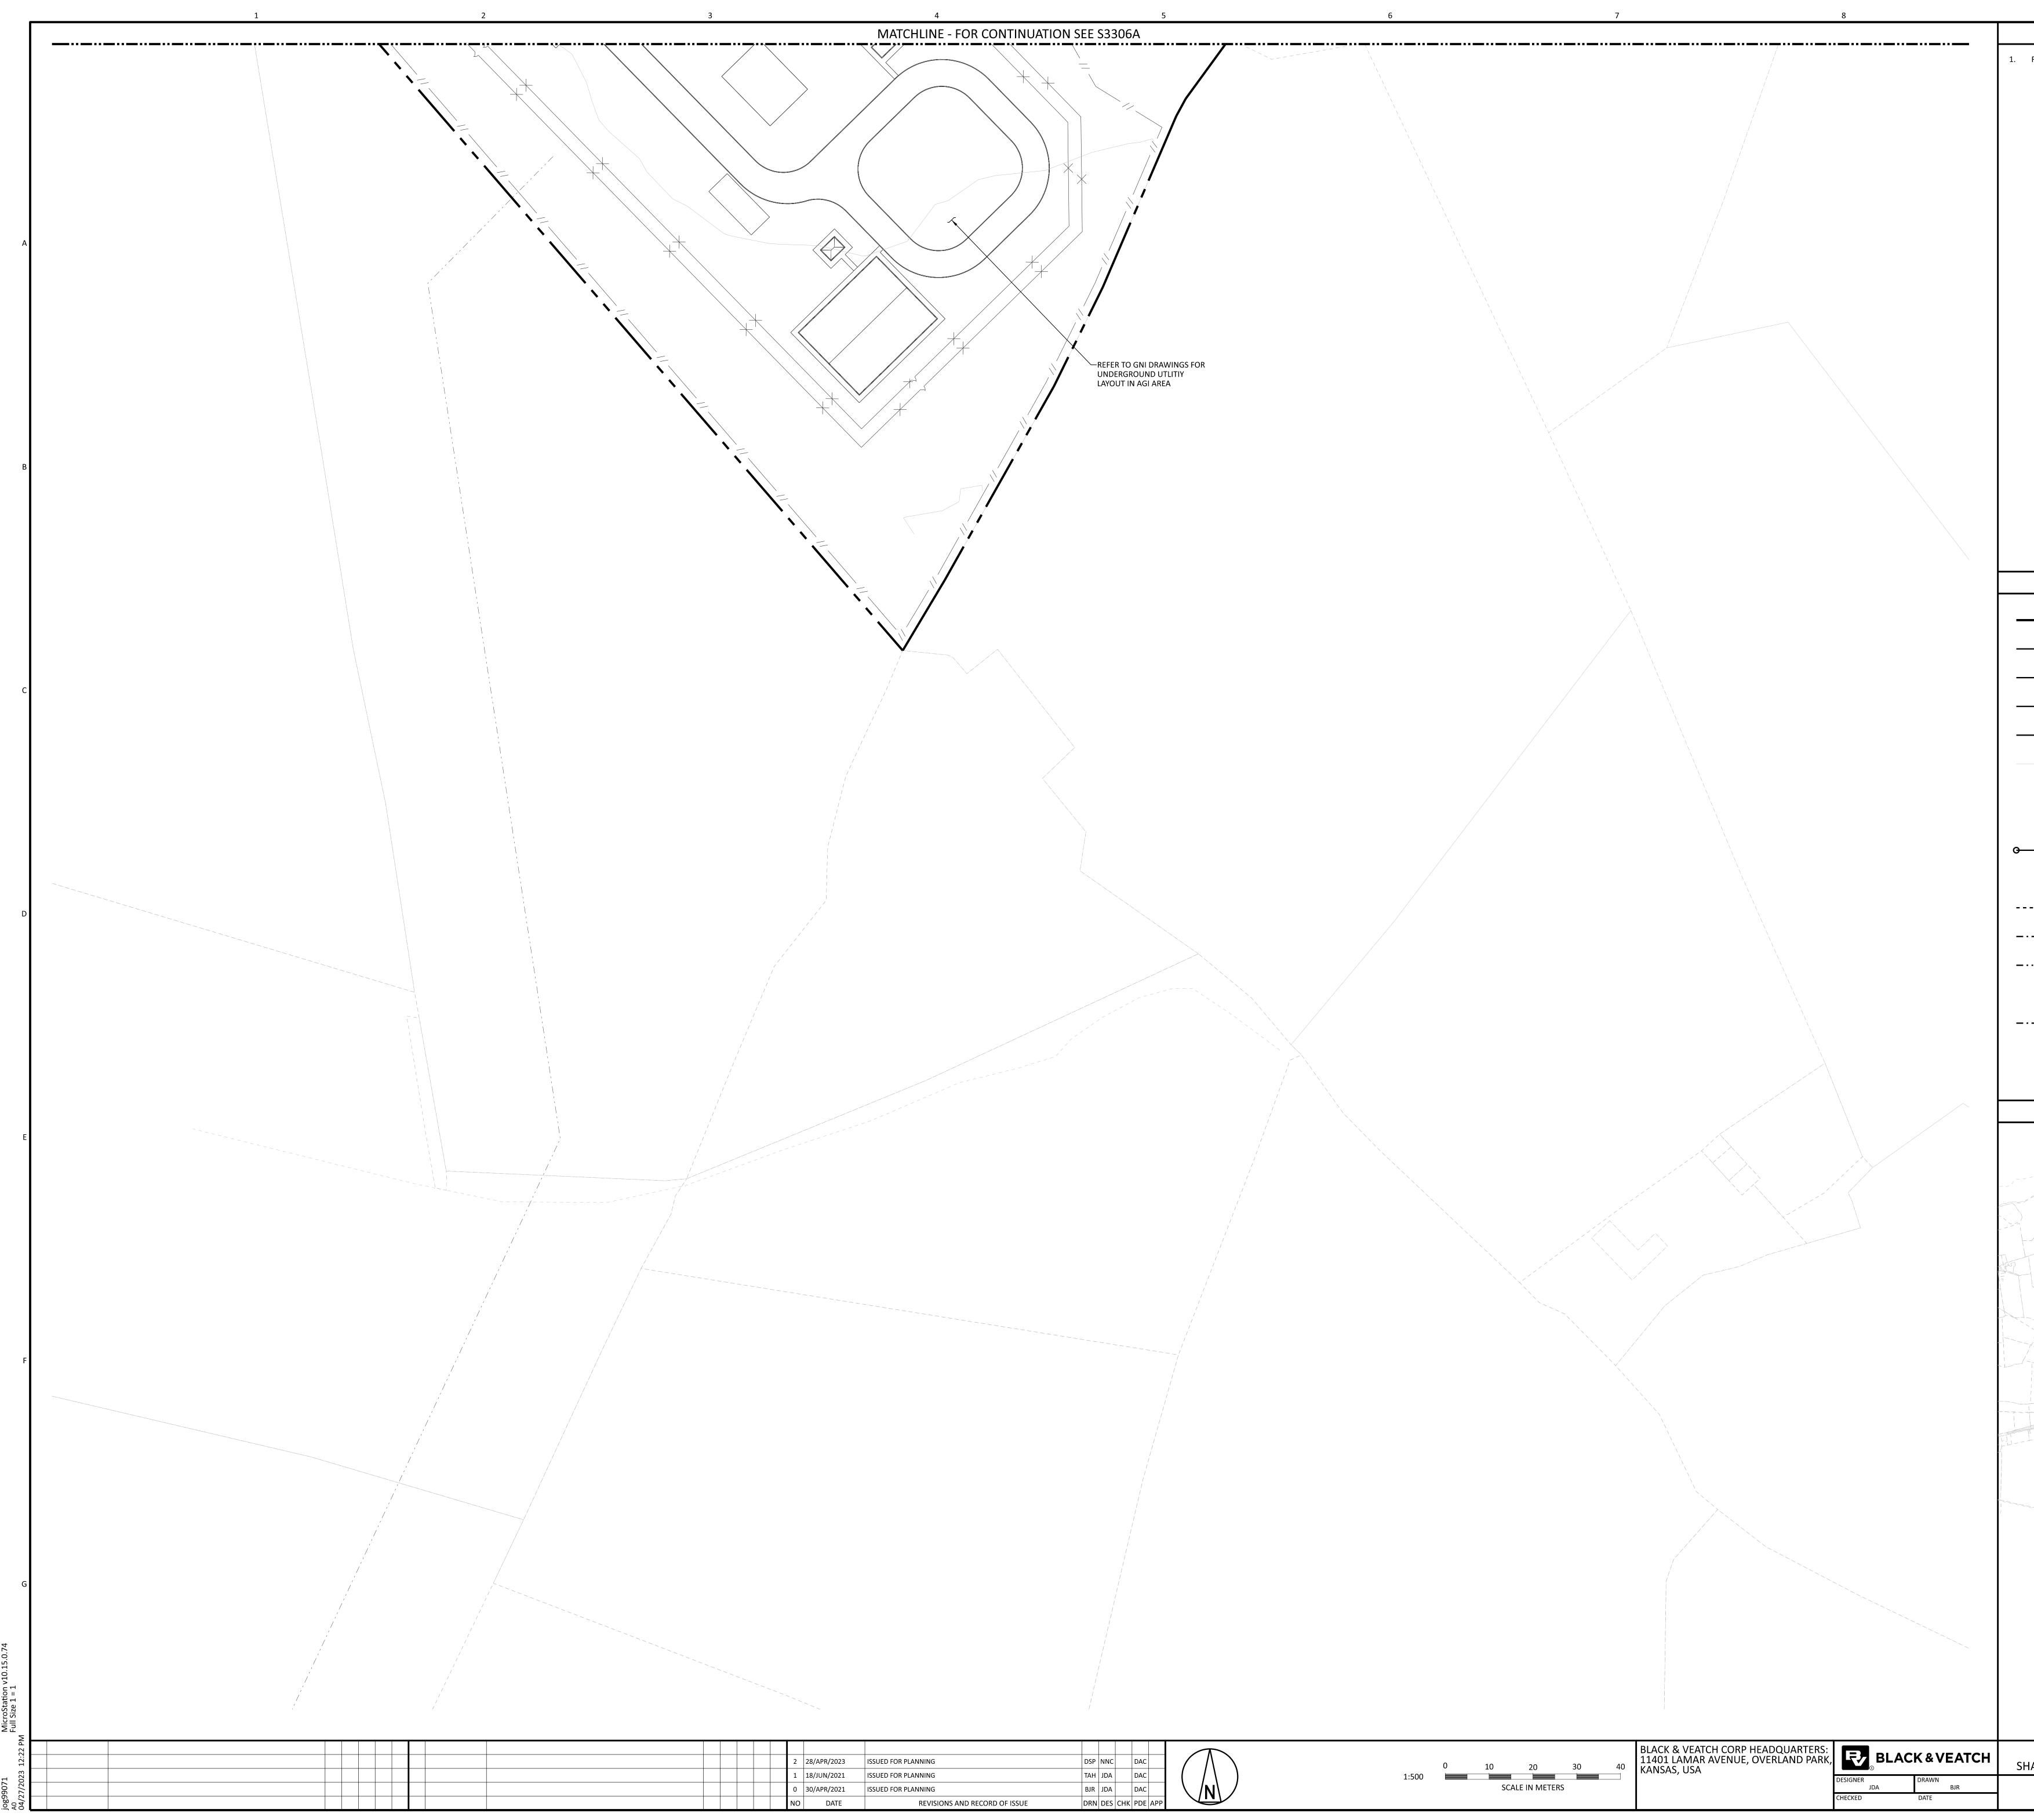


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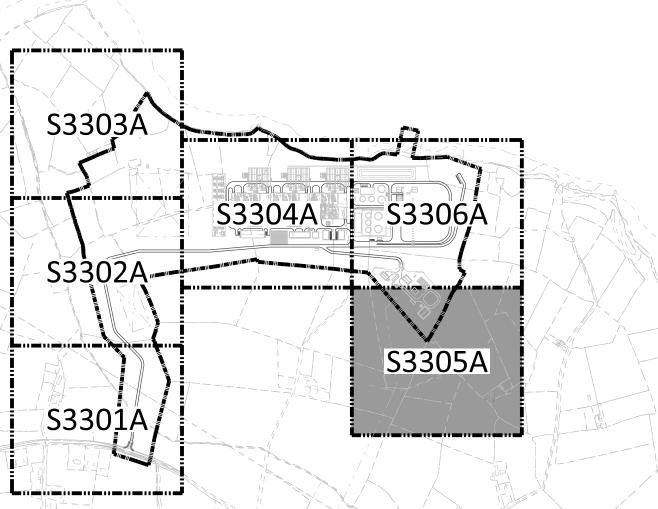

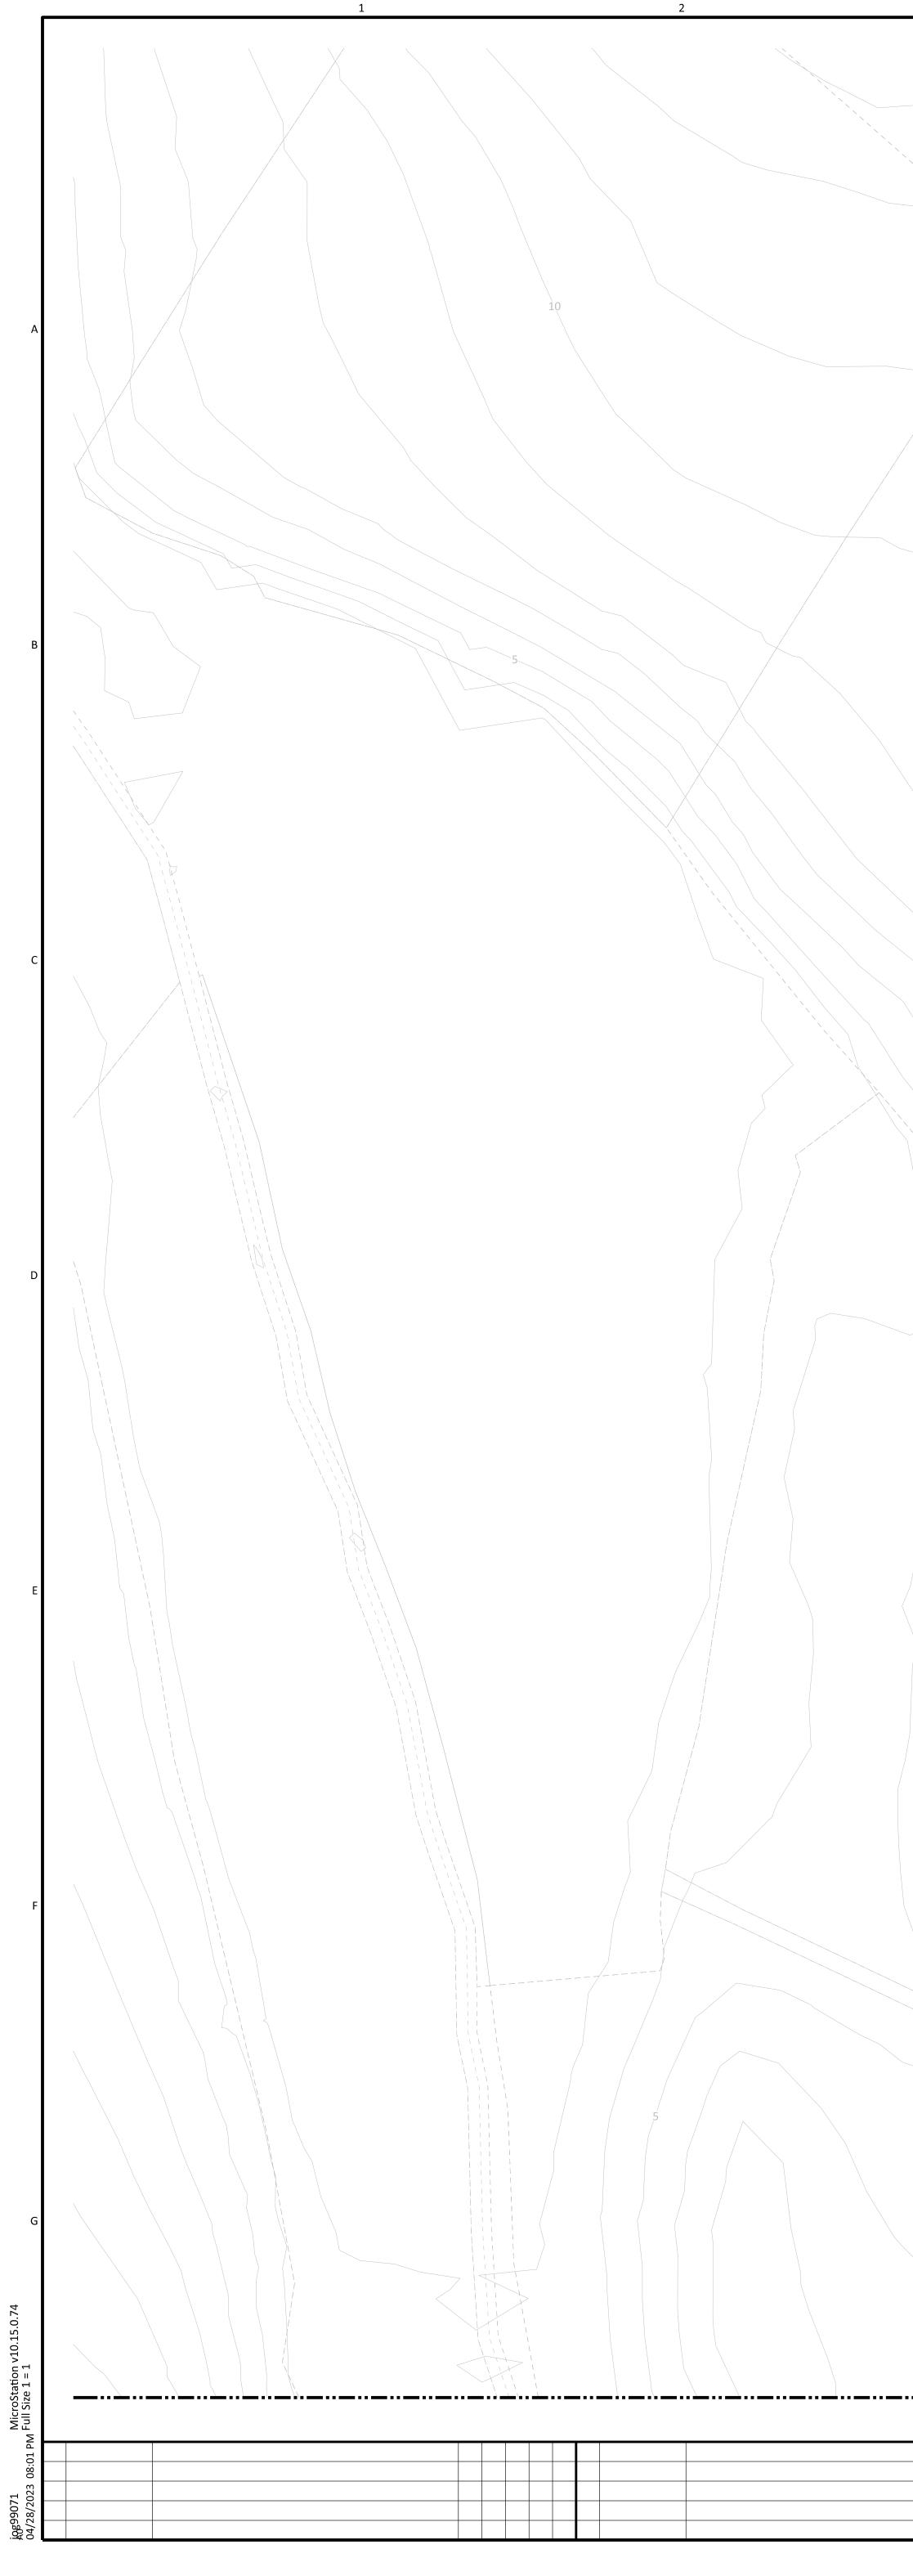
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SHANNON LNG LIMITED SHANNON TECHNOLOGY AND ENERGY PARK (STEP)	PROJECT 198291-15	DRAWING NUMBER	RE


SANITARY LAYOUT - SITE PLAN - AREA 5

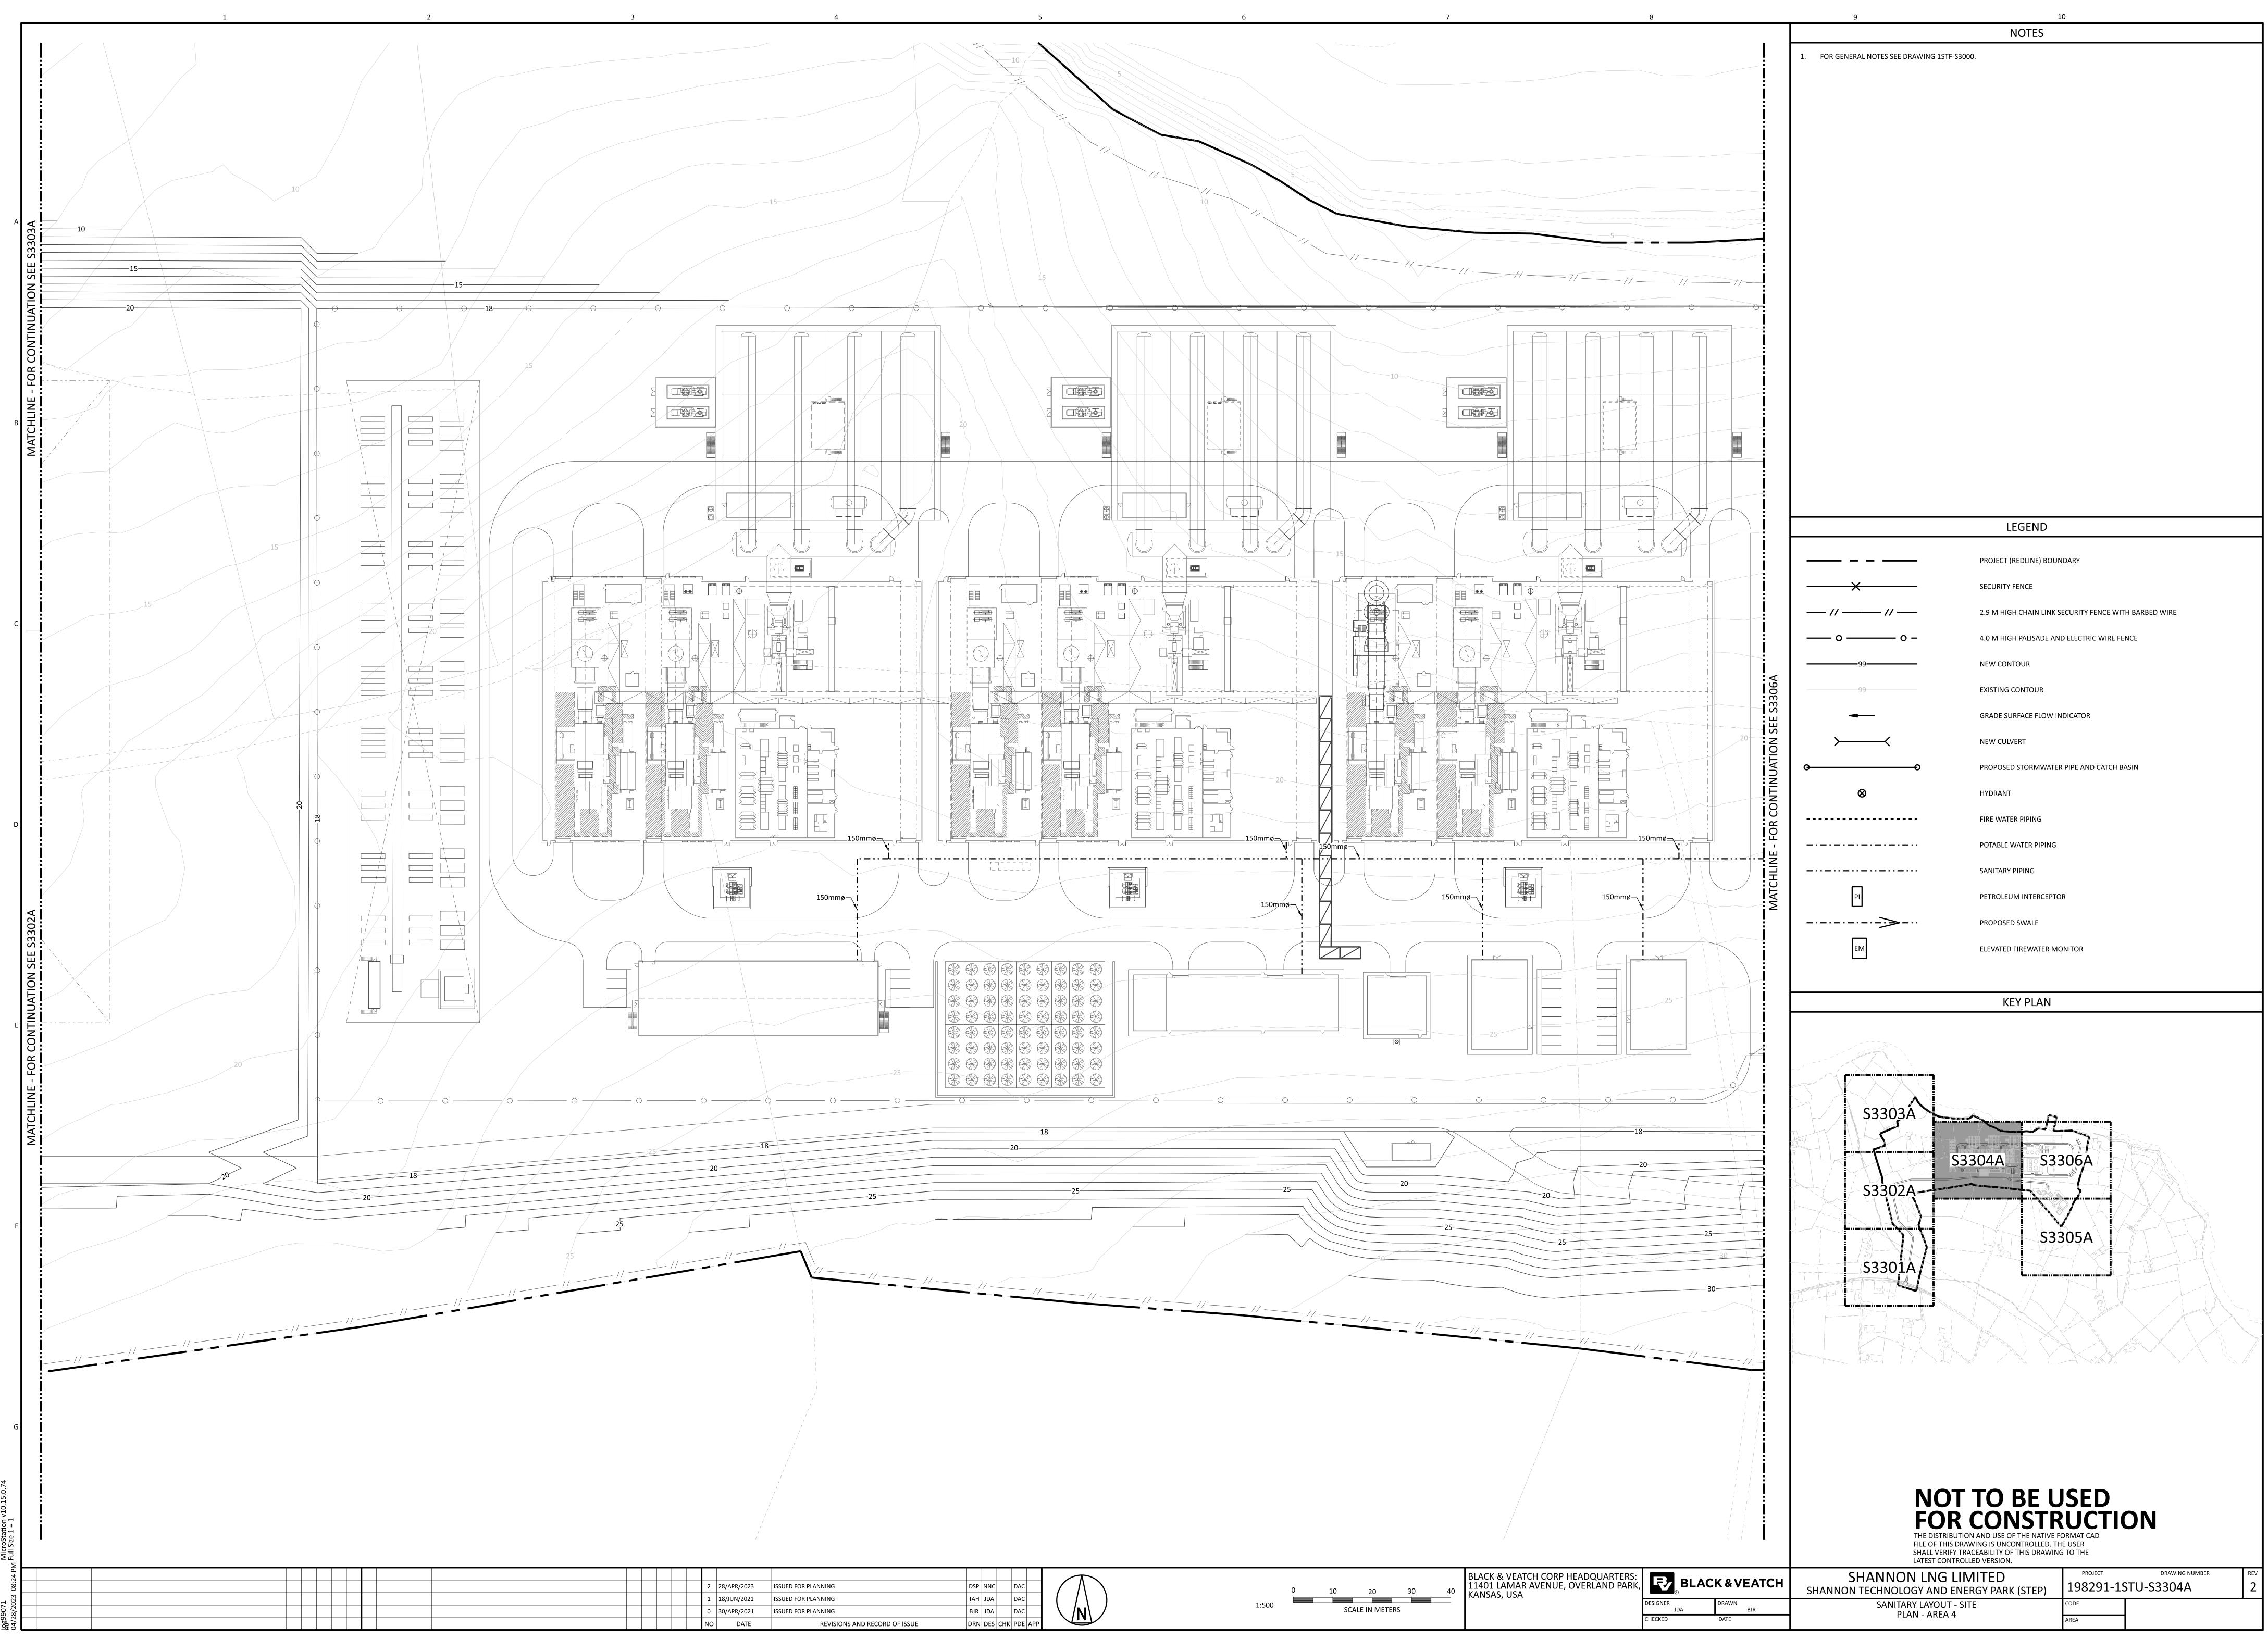

## KEY PLAN


	PROJECT (REDLINE) BOUNDARY
——————————————————————————————————————	SECURITY FENCE
// //	2.9 M HIGH CHAIN LINK SECURITY FENCE WITH BARBED WIRE
— o — _ o –	4.0 M HIGH PALISADE AND ELECTRIC WIRE FENCE
99	NEW CONTOUR
99	EXISTING CONTOUR
◄	GRADE SURFACE FLOW INDICATOR
$\rightarrow$	NEW CULVERT
θθ	PROPOSED STORMWATER PIPE AND CATCH BASIN
$\otimes$	HYDRANT
	FIRE WATER PIPING
	POTABLE WATER PIPING
	SANITARY PIPING
PI	PETROLEUM INTERCEPTOR
>	PROPOSED SWALE
EM	ELEVATED FIREWATER MONITOR

LEGEND

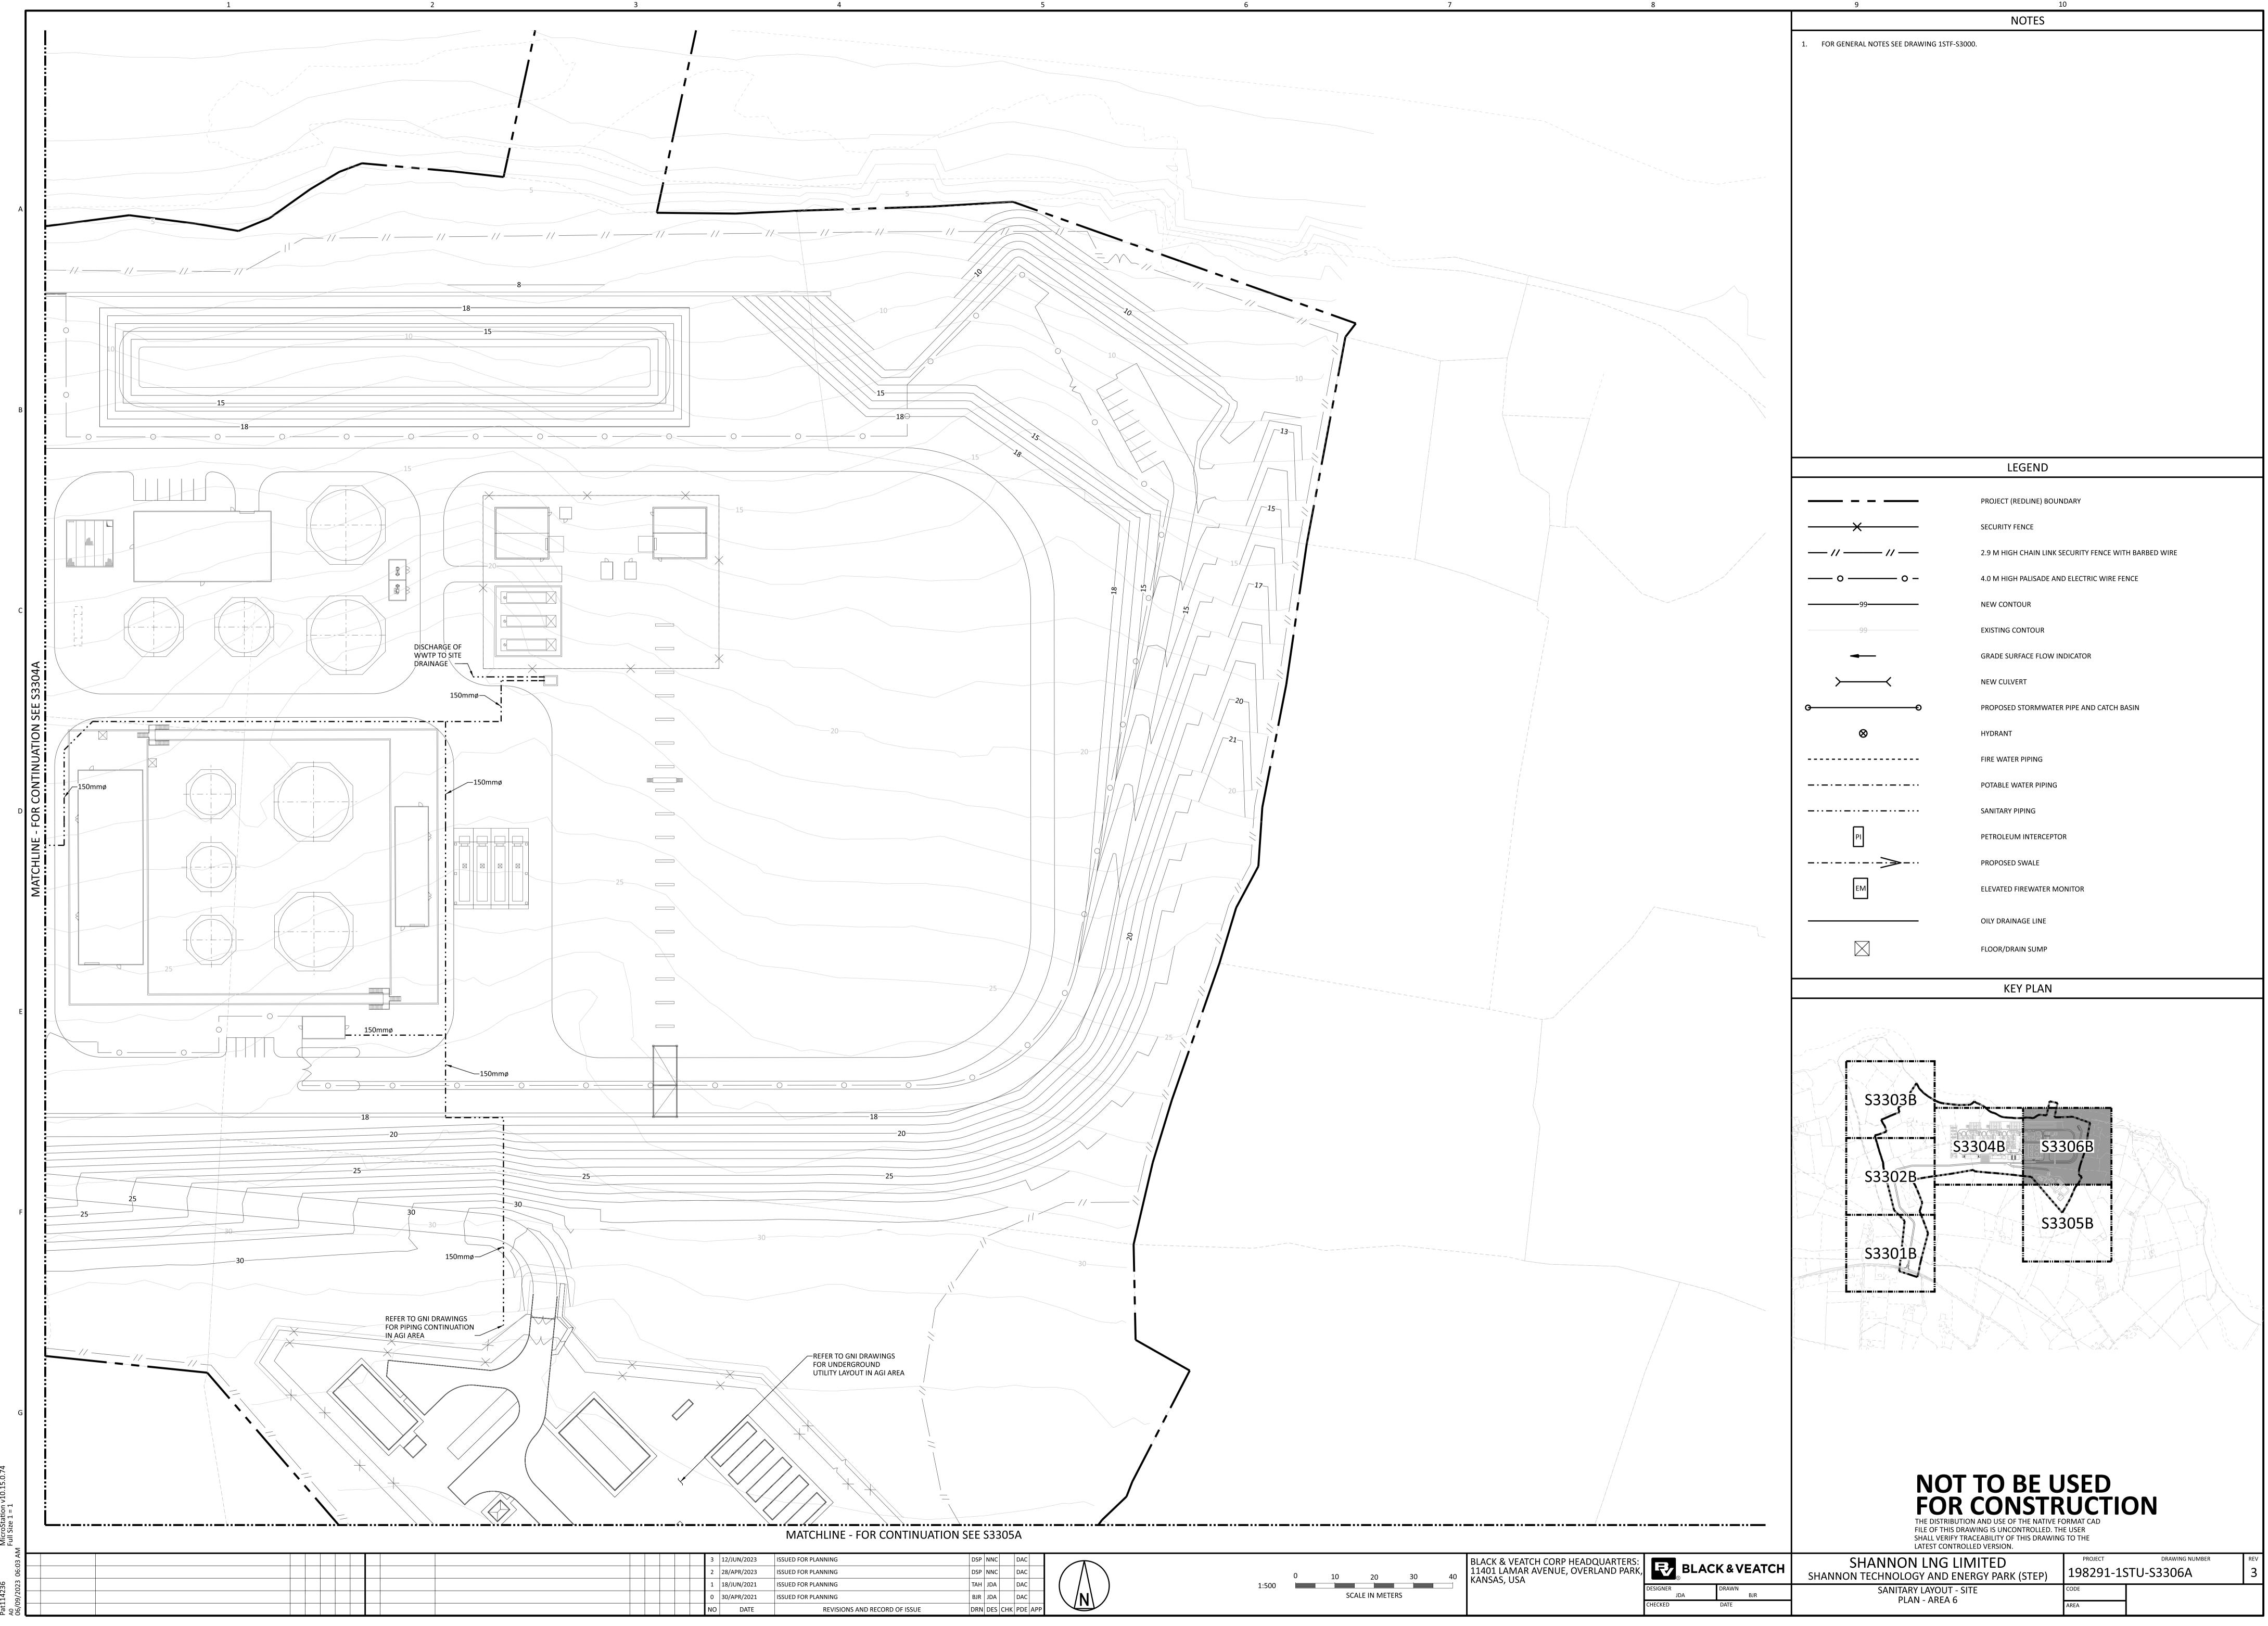


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SHANNON LNG LIMITED ANNON TECHNOLOGY AND ENERGY PARK (STEP)	PROJECT	drawing number STU-S3306A	<sup>REV</sup>
SANITARY LAYOUT - SITE PLAN - AREA 6	CODE		
	AREA		

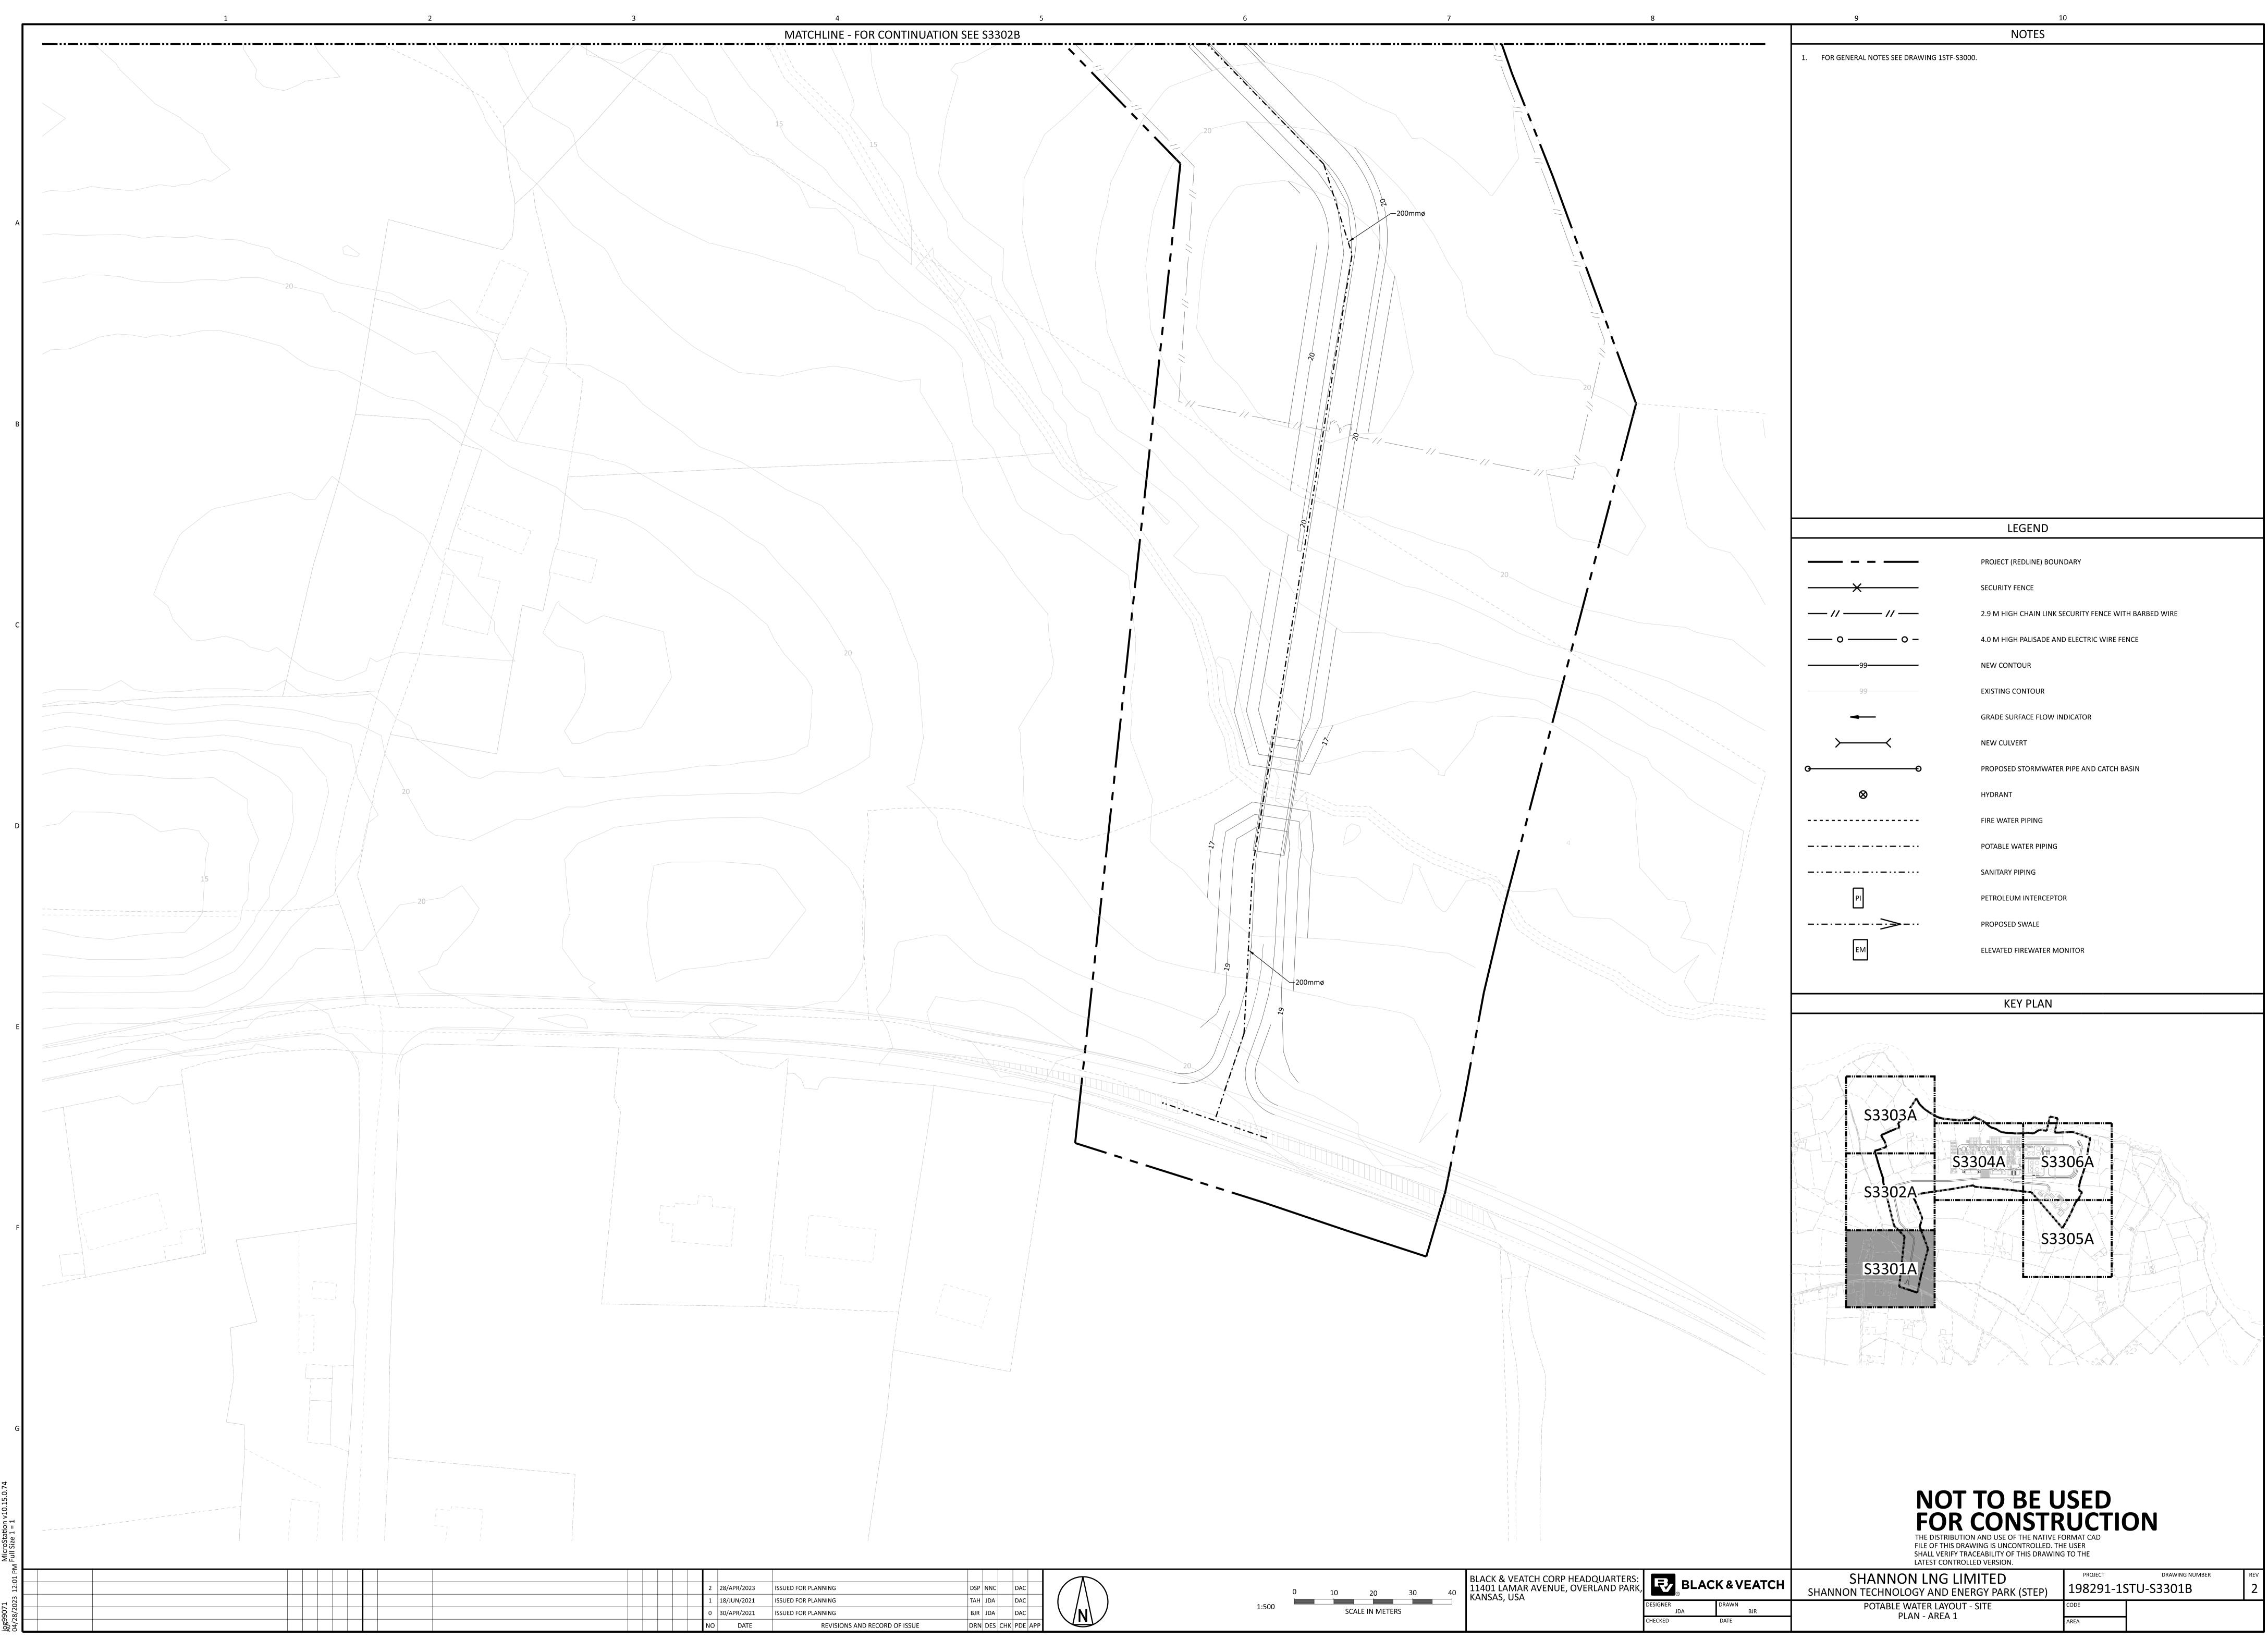


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ANNON LNG LIMITED	PROJECT	DRAWING NUMBER	Γ			
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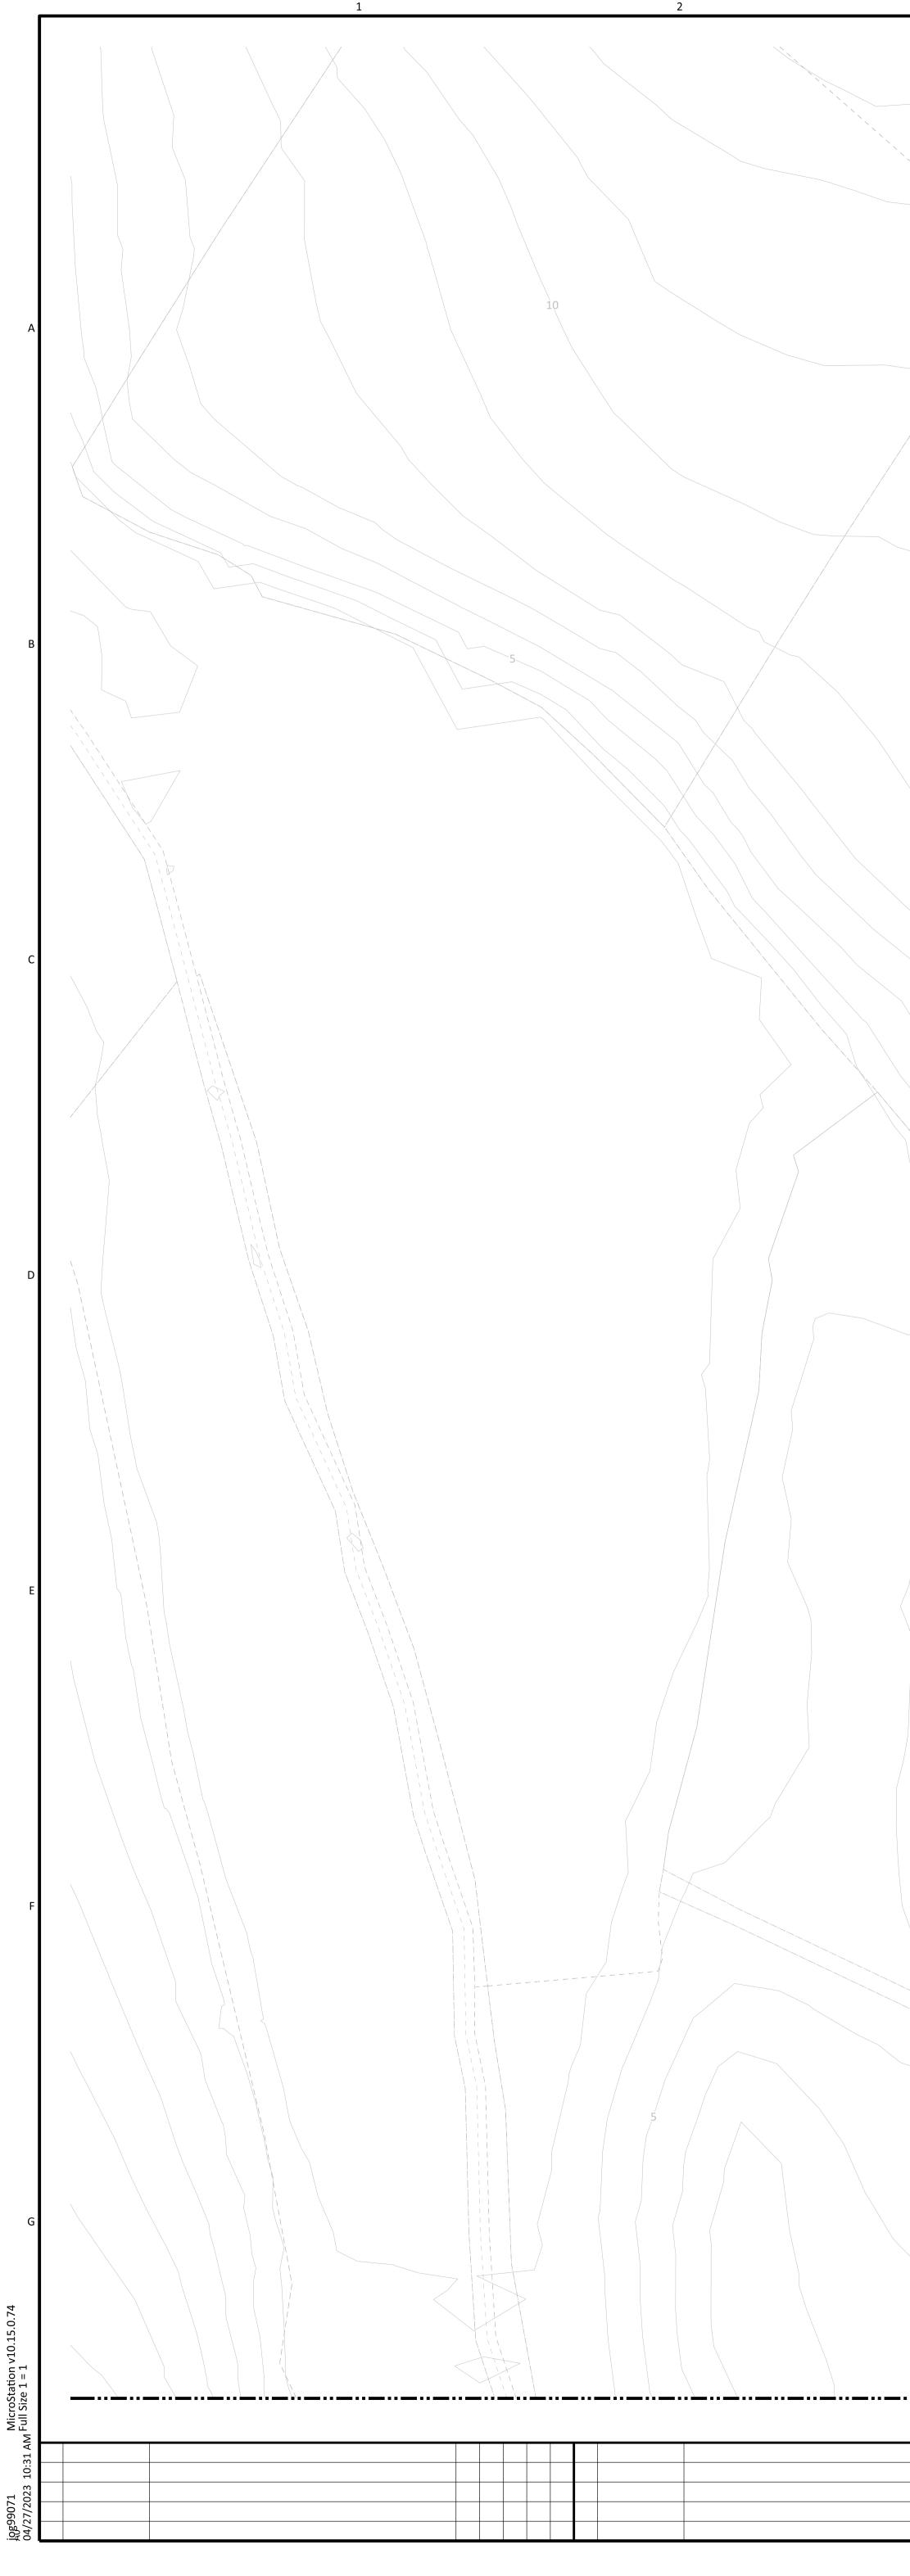


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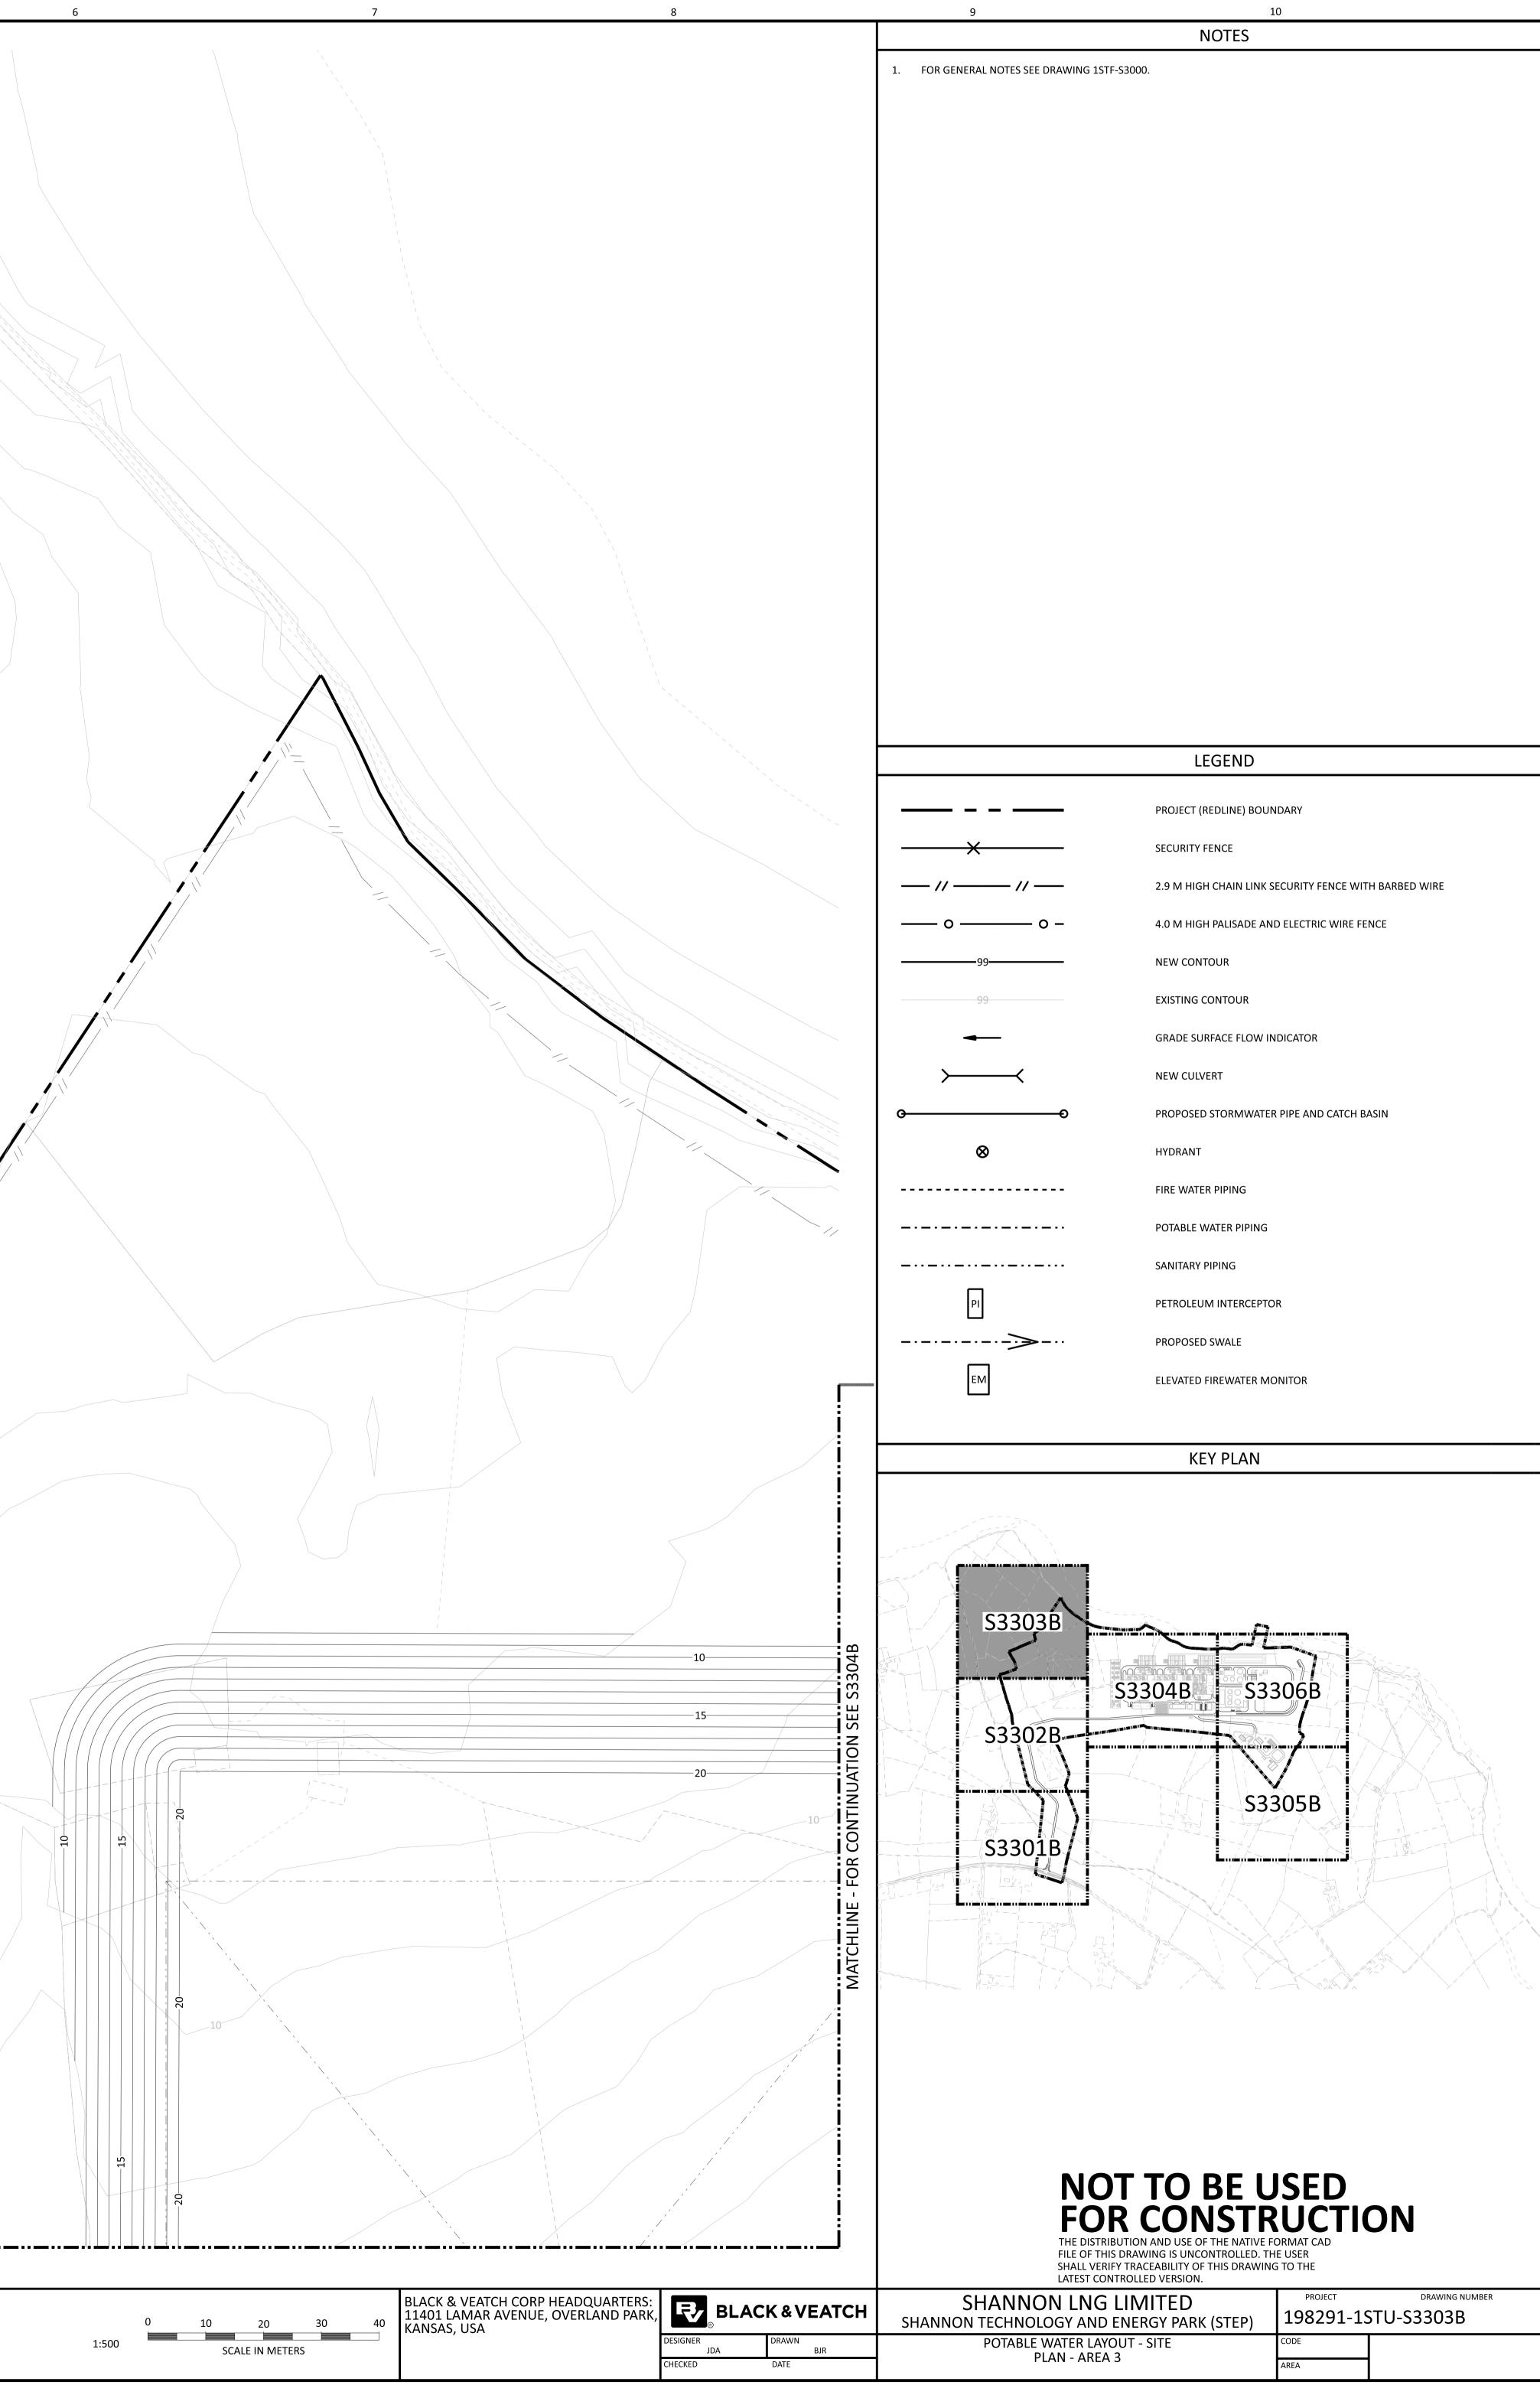


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SHANNON LNG LIMITED	PROJECT	DRAWING NUMBER	REV
ON TECHNOLOGY AND ENERGY PARK (STEP)	198291-19	STU-S3302B	2
POTABLE WATER LAYOUT - SITE	CODE		
PLAN - AREA 2			

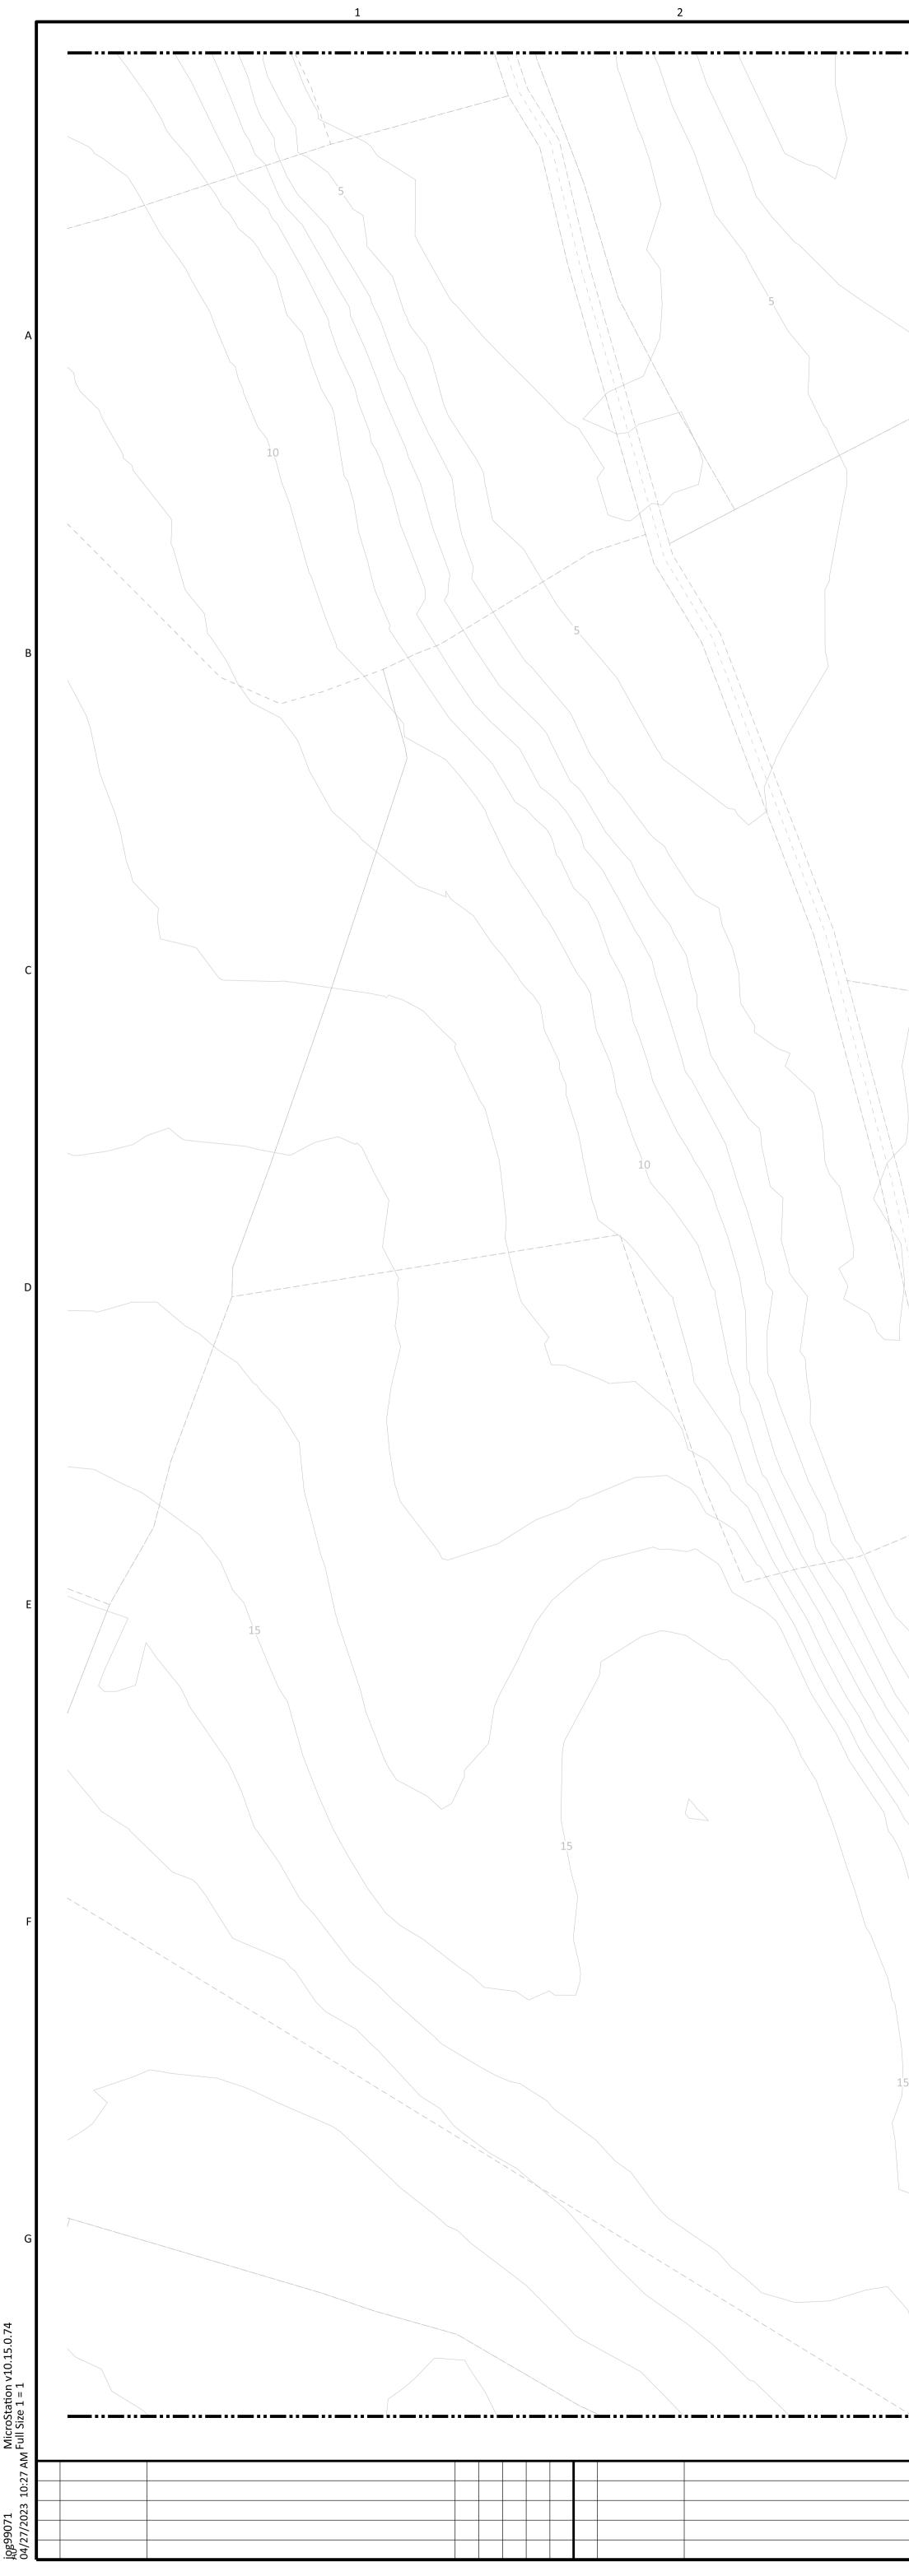


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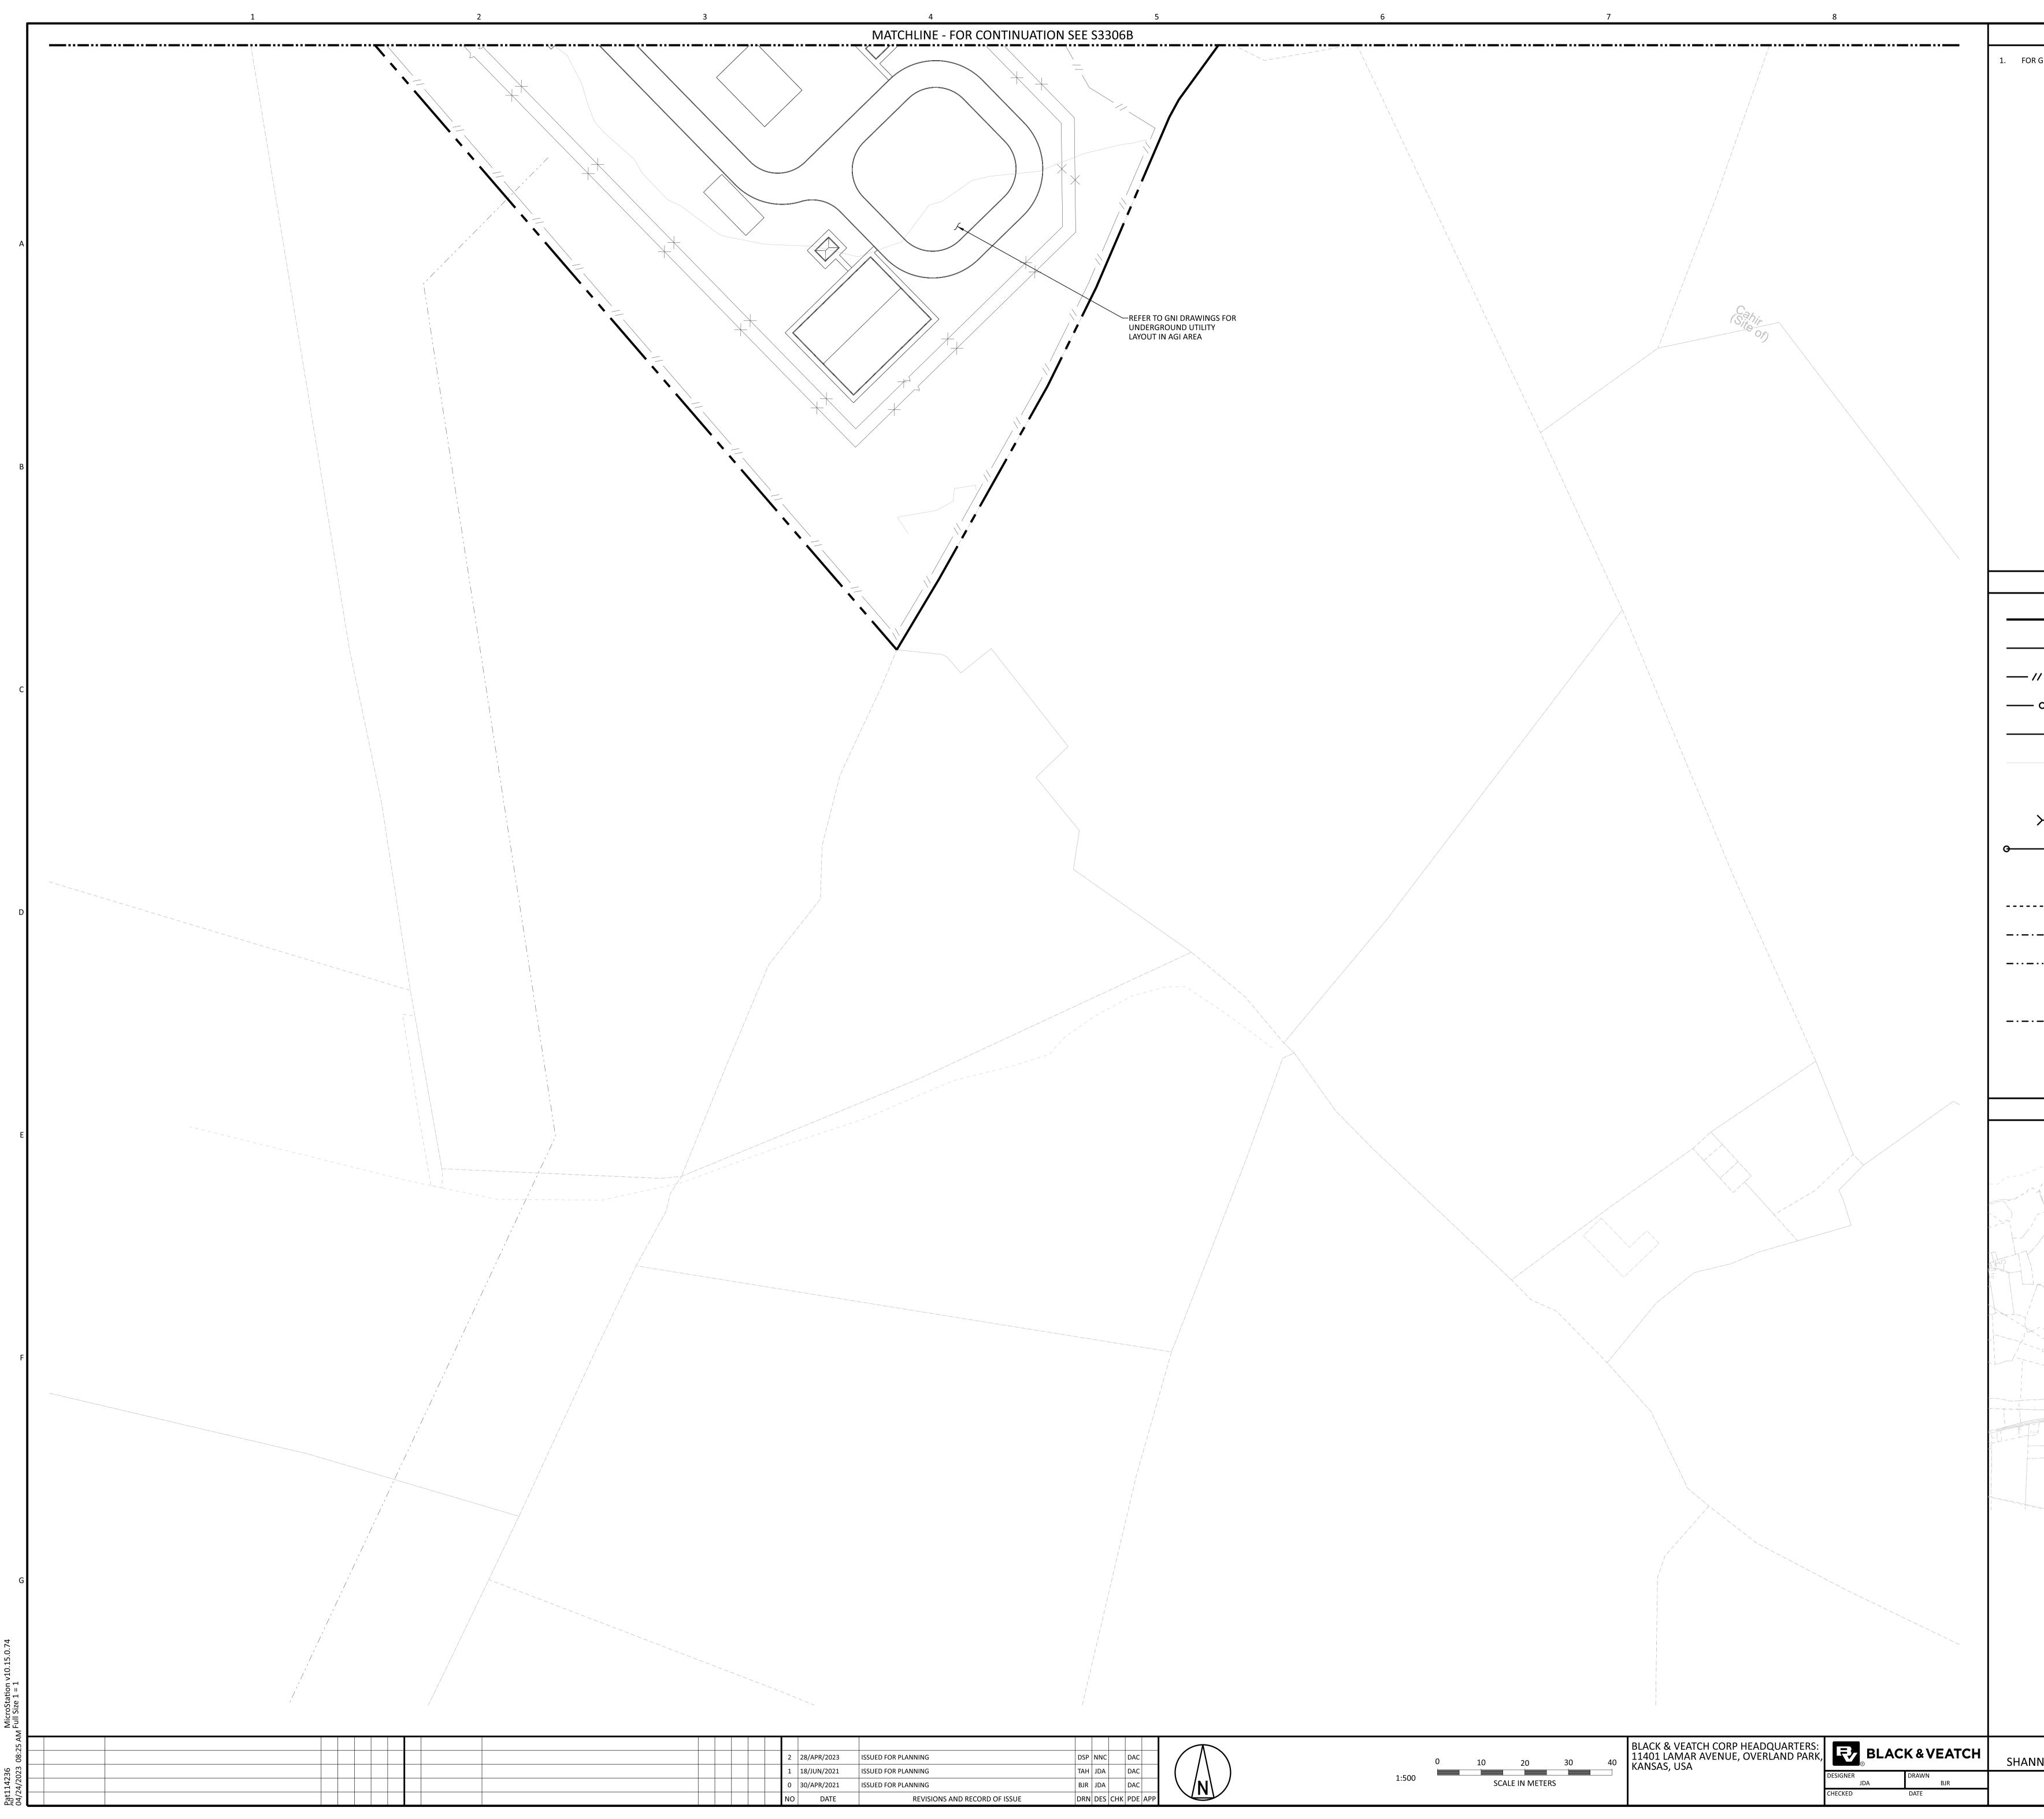
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SHANNON LNG LIMITED ON TECHNOLOGY AND ENERGY PARK (STEP)	PROJECT 198291-15	DRAWING NUMBER	REV
POTABLE WATER LAYOUT - SITE PLAN - ARFA 3	CODE		1

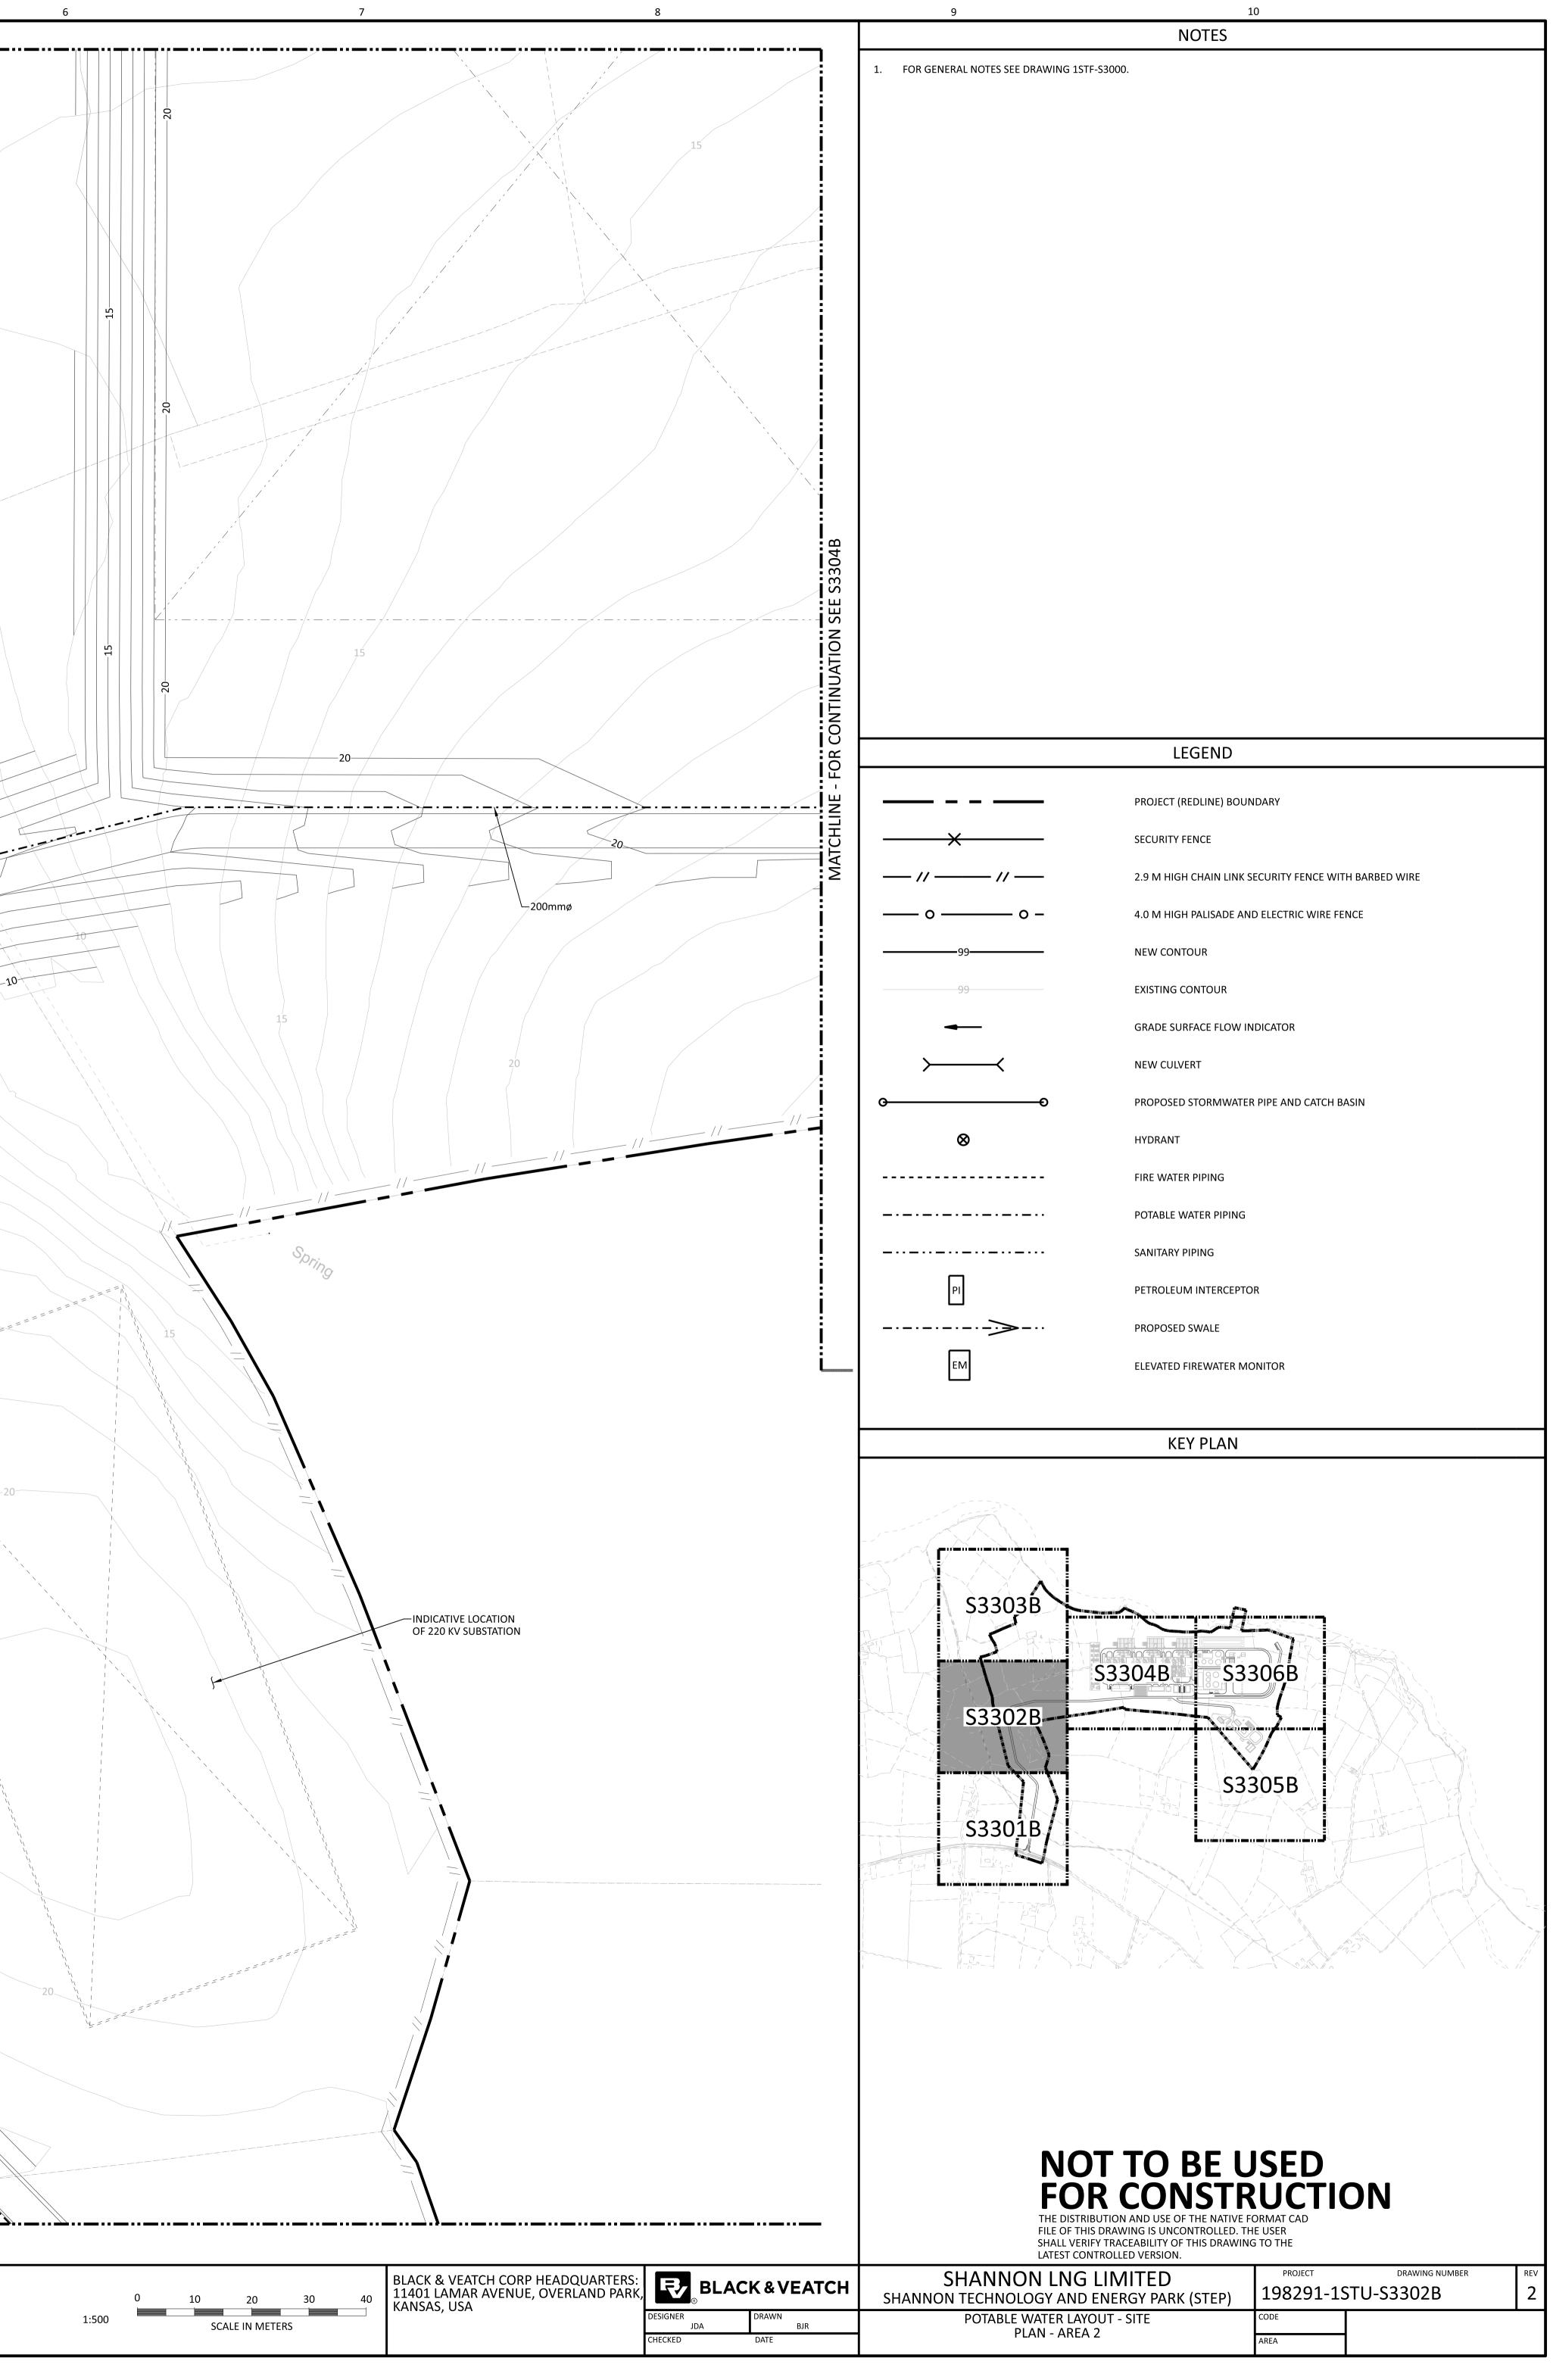	LEGEND	
	PROJECT (REDLINE) BOUNDARY	
——————————————————————————————————————	SECURITY FENCE	
// //	2.9 M HIGH CHAIN LINK SECURITY FENCE WITH BARBED WIRE	
— o — _ o –	4.0 M HIGH PALISADE AND ELECTRIC WIRE FENCE	
	NEW CONTOUR	
99	EXISTING CONTOUR	
-	GRADE SURFACE FLOW INDICATOR	
$\rightarrow$	NEW CULVERT	
•••••••••••••••••••••••••••••••••••••••	PROPOSED STORMWATER PIPE AND CATCH BASIN	
$\otimes$	HYDRANT	
	FIRE WATER PIPING	C
	POTABLE WATER PIPING	
	SANITARY PIPING	
Ы	PETROLEUM INTERCEPTOR	
·····>···>··	PROPOSED SWALE	
EM	ELEVATED FIREWATER MONITOR	



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SHANNON LNG LIMITED	PROJECT	DRAWING NUMBER	REV
NON TECHNOLOGY AND ENERGY PARK (STEP)	198291-19	STU-S3304B	2
POTABLE WATER LAYOUT - SITE	CODE		
PLAN - AREA 4	AREA		

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Т	FOR CONSTRUCTION THE DISTRIBUTION AND USE OF THE NATIVE FORMAT CAD FILE OF THIS DRAWING IS UNCONTROLLED. THE USER

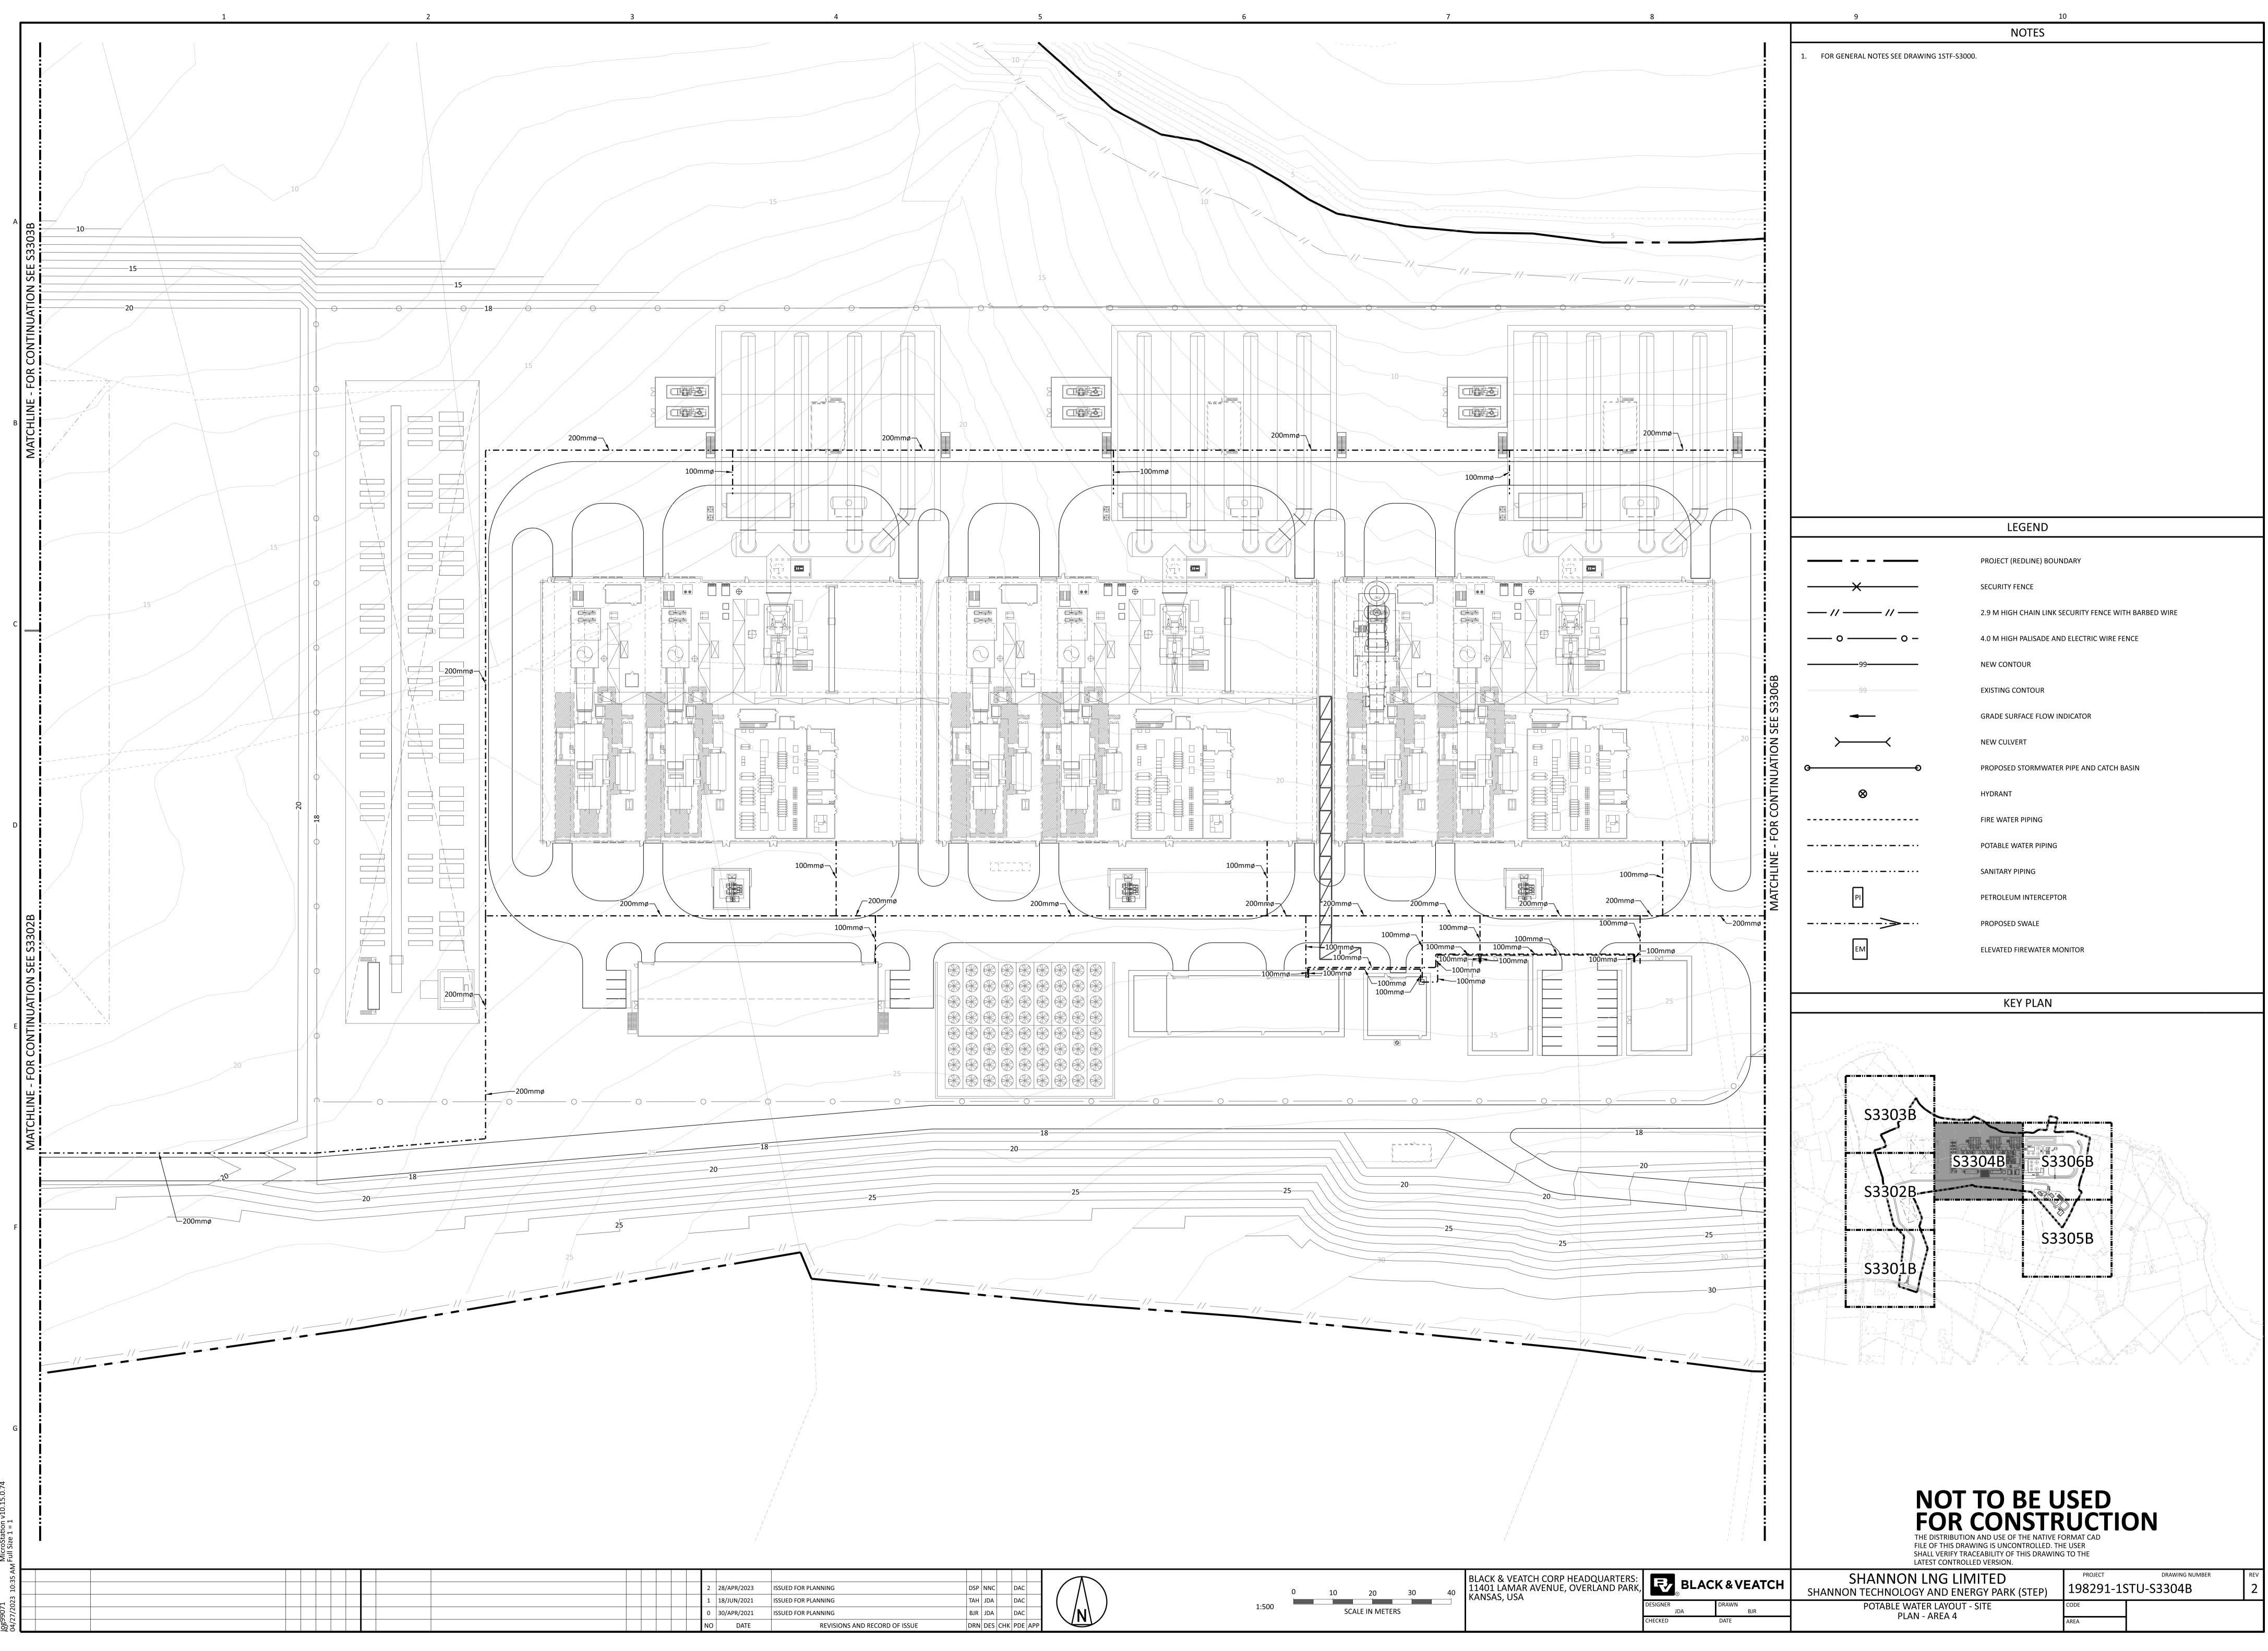

<b>NOT TO BE U</b> <b>FOR CONSTR</b> THE DISTRIBUTION AND USE OF THE NATIVE FO FILE OF THIS DRAWING IS UNCONTROLLED. TH SHALL VERIFY TRACEABILITY OF THIS DRAWING LATEST CONTROLLED VERSION.	UCTIO DRMAT CAD E USER	ON	
SHANNON LNG LIMITED	PROJECT	DRAWING NUMBER	REV
NON TECHNOLOGY AND ENERGY PARK (STEP)	198291-19	STU-S3305B	2
POTABLE WATER LAYOUT - SITE	CODE		
PLAN - AREA 5	AREA		

◄	GRADE SURFACE FLOW INDICATOR
$\rightarrow$	NEW CULVERT
Θ	PROPOSED STORMWATER PIPE AND CATCH BASIN
$\otimes$	HYDRANT
	FIRE WATER PIPING
	POTABLE WATER PIPING
	SANITARY PIPING
Ы	PETROLEUM INTERCEPTOR
·-···>···	PROPOSED SWALE
EM	ELEVATED FIREWATER MONITOR
	KEY PLAN

S3306

S3305A

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\$330<u>3</u>Å

- \$3302A-

S3301A


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S3304A

	PROJECT (REDLINE) BOUNDARY	
— × — —	SECURITY FENCE	
// //	2.9 M HIGH CHAIN LINK SECURITY FENCE WITH BARBED WIRE	
— o — _ o –	4.0 M HIGH PALISADE AND ELECTRIC WIRE FENCE	
99	NEW CONTOUR	
99	EXISTING CONTOUR	
◄	GRADE SURFACE FLOW INDICATOR	
$\succ$	NEW CULVERT	
Đ	PROPOSED STORMWATER PIPE AND CATCH BASIN	
$\otimes$	HYDRANT	
	FIRE WATER PIPING	[
	POTABLE WATER PIPING	
	SANITARY PIPING	
PI	PETROLEUM INTERCEPTOR	
>	PROPOSED SWALE	

LEGEND

1. FOR GENERAL NOTES SEE DRAWING 1STF-S3000.

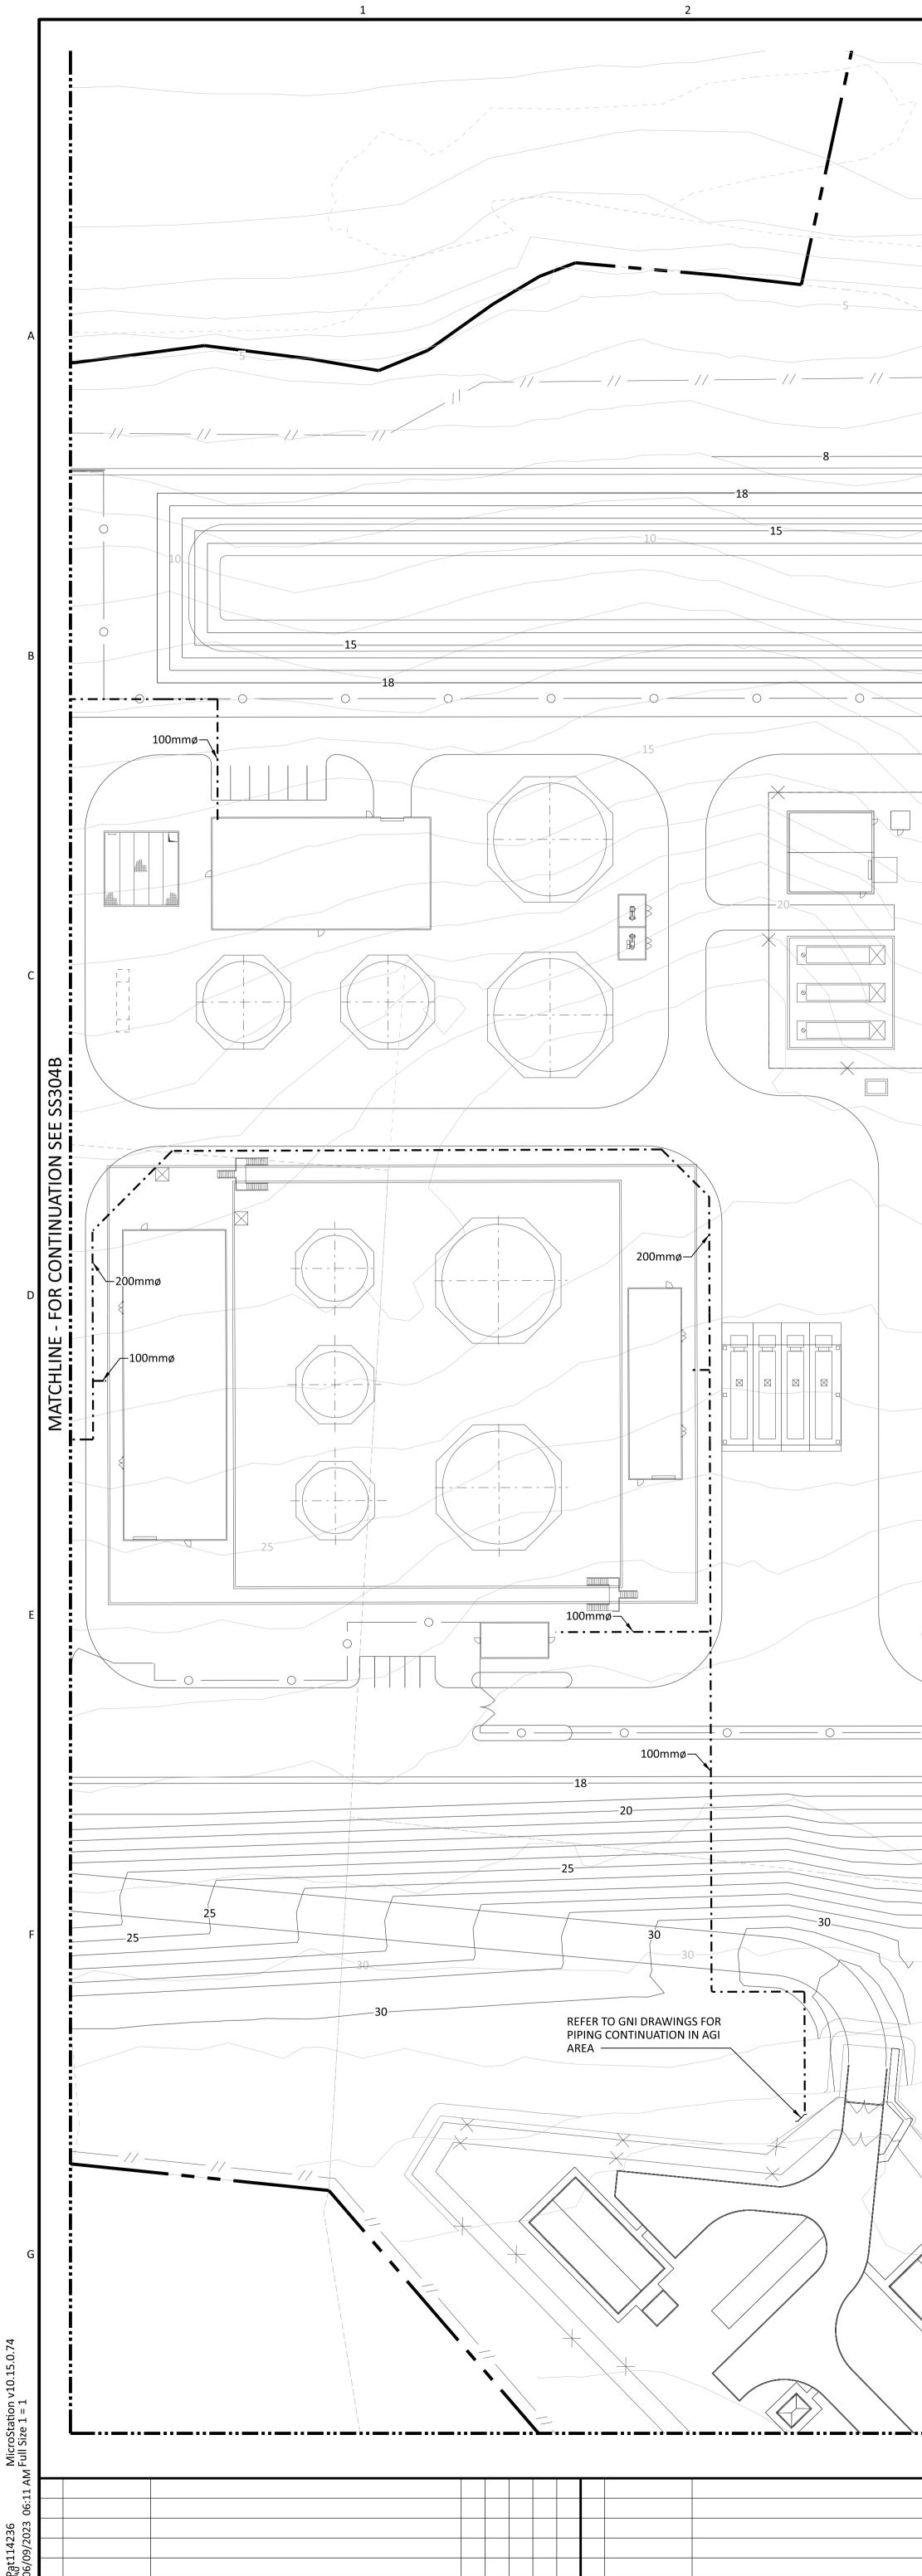


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		∕−REFER TO GNI DRAWINGS FOR			
		UNDERGROUND UTILITY LAYOUT IN AGI AREA			
					7
		MATCHLINE - FOR CO			
			DSP NNC		

			3	12/JUN/2023	ISSUED FOR PLANNING	DSP	NNC		DAC		
			2	28/APR/2023	ISSUED FOR PLANNING	DSP	NNC		DAC		$ \land \land \land $
			1	18/JUN/2021	ISSUED FOR PLANNING	TAH	JDA		DAC		
			0	30/APR/2021	ISSUED FOR PLANNING	BJR	JDA		DAC		$\langle N \rangle$
			NO	DATE	REVISIONS AND RECORD OF ISSUE	DRN	DES	СНК	PDE	APP	




<b>NOT TO BE U</b> <b>FOR CONSTR</b> THE DISTRIBUTION AND USE OF THE NATIVE FOR FILE OF THIS DRAWING IS UNCONTROLLED. TH SHALL VERIFY TRACEABILITY OF THIS DRAWING LATEST CONTROLLED VERSION.	UCTIO DRMAT CAD E USER	ON	
SHANNON LNG LIMITED	PROJECT	DRAWING NUMBER	REV
INON TECHNOLOGY AND ENERGY PARK (STEP)	198291-19	STU-S3306B	3
POTABLE WATER LAYOUT - SITE	CODE		

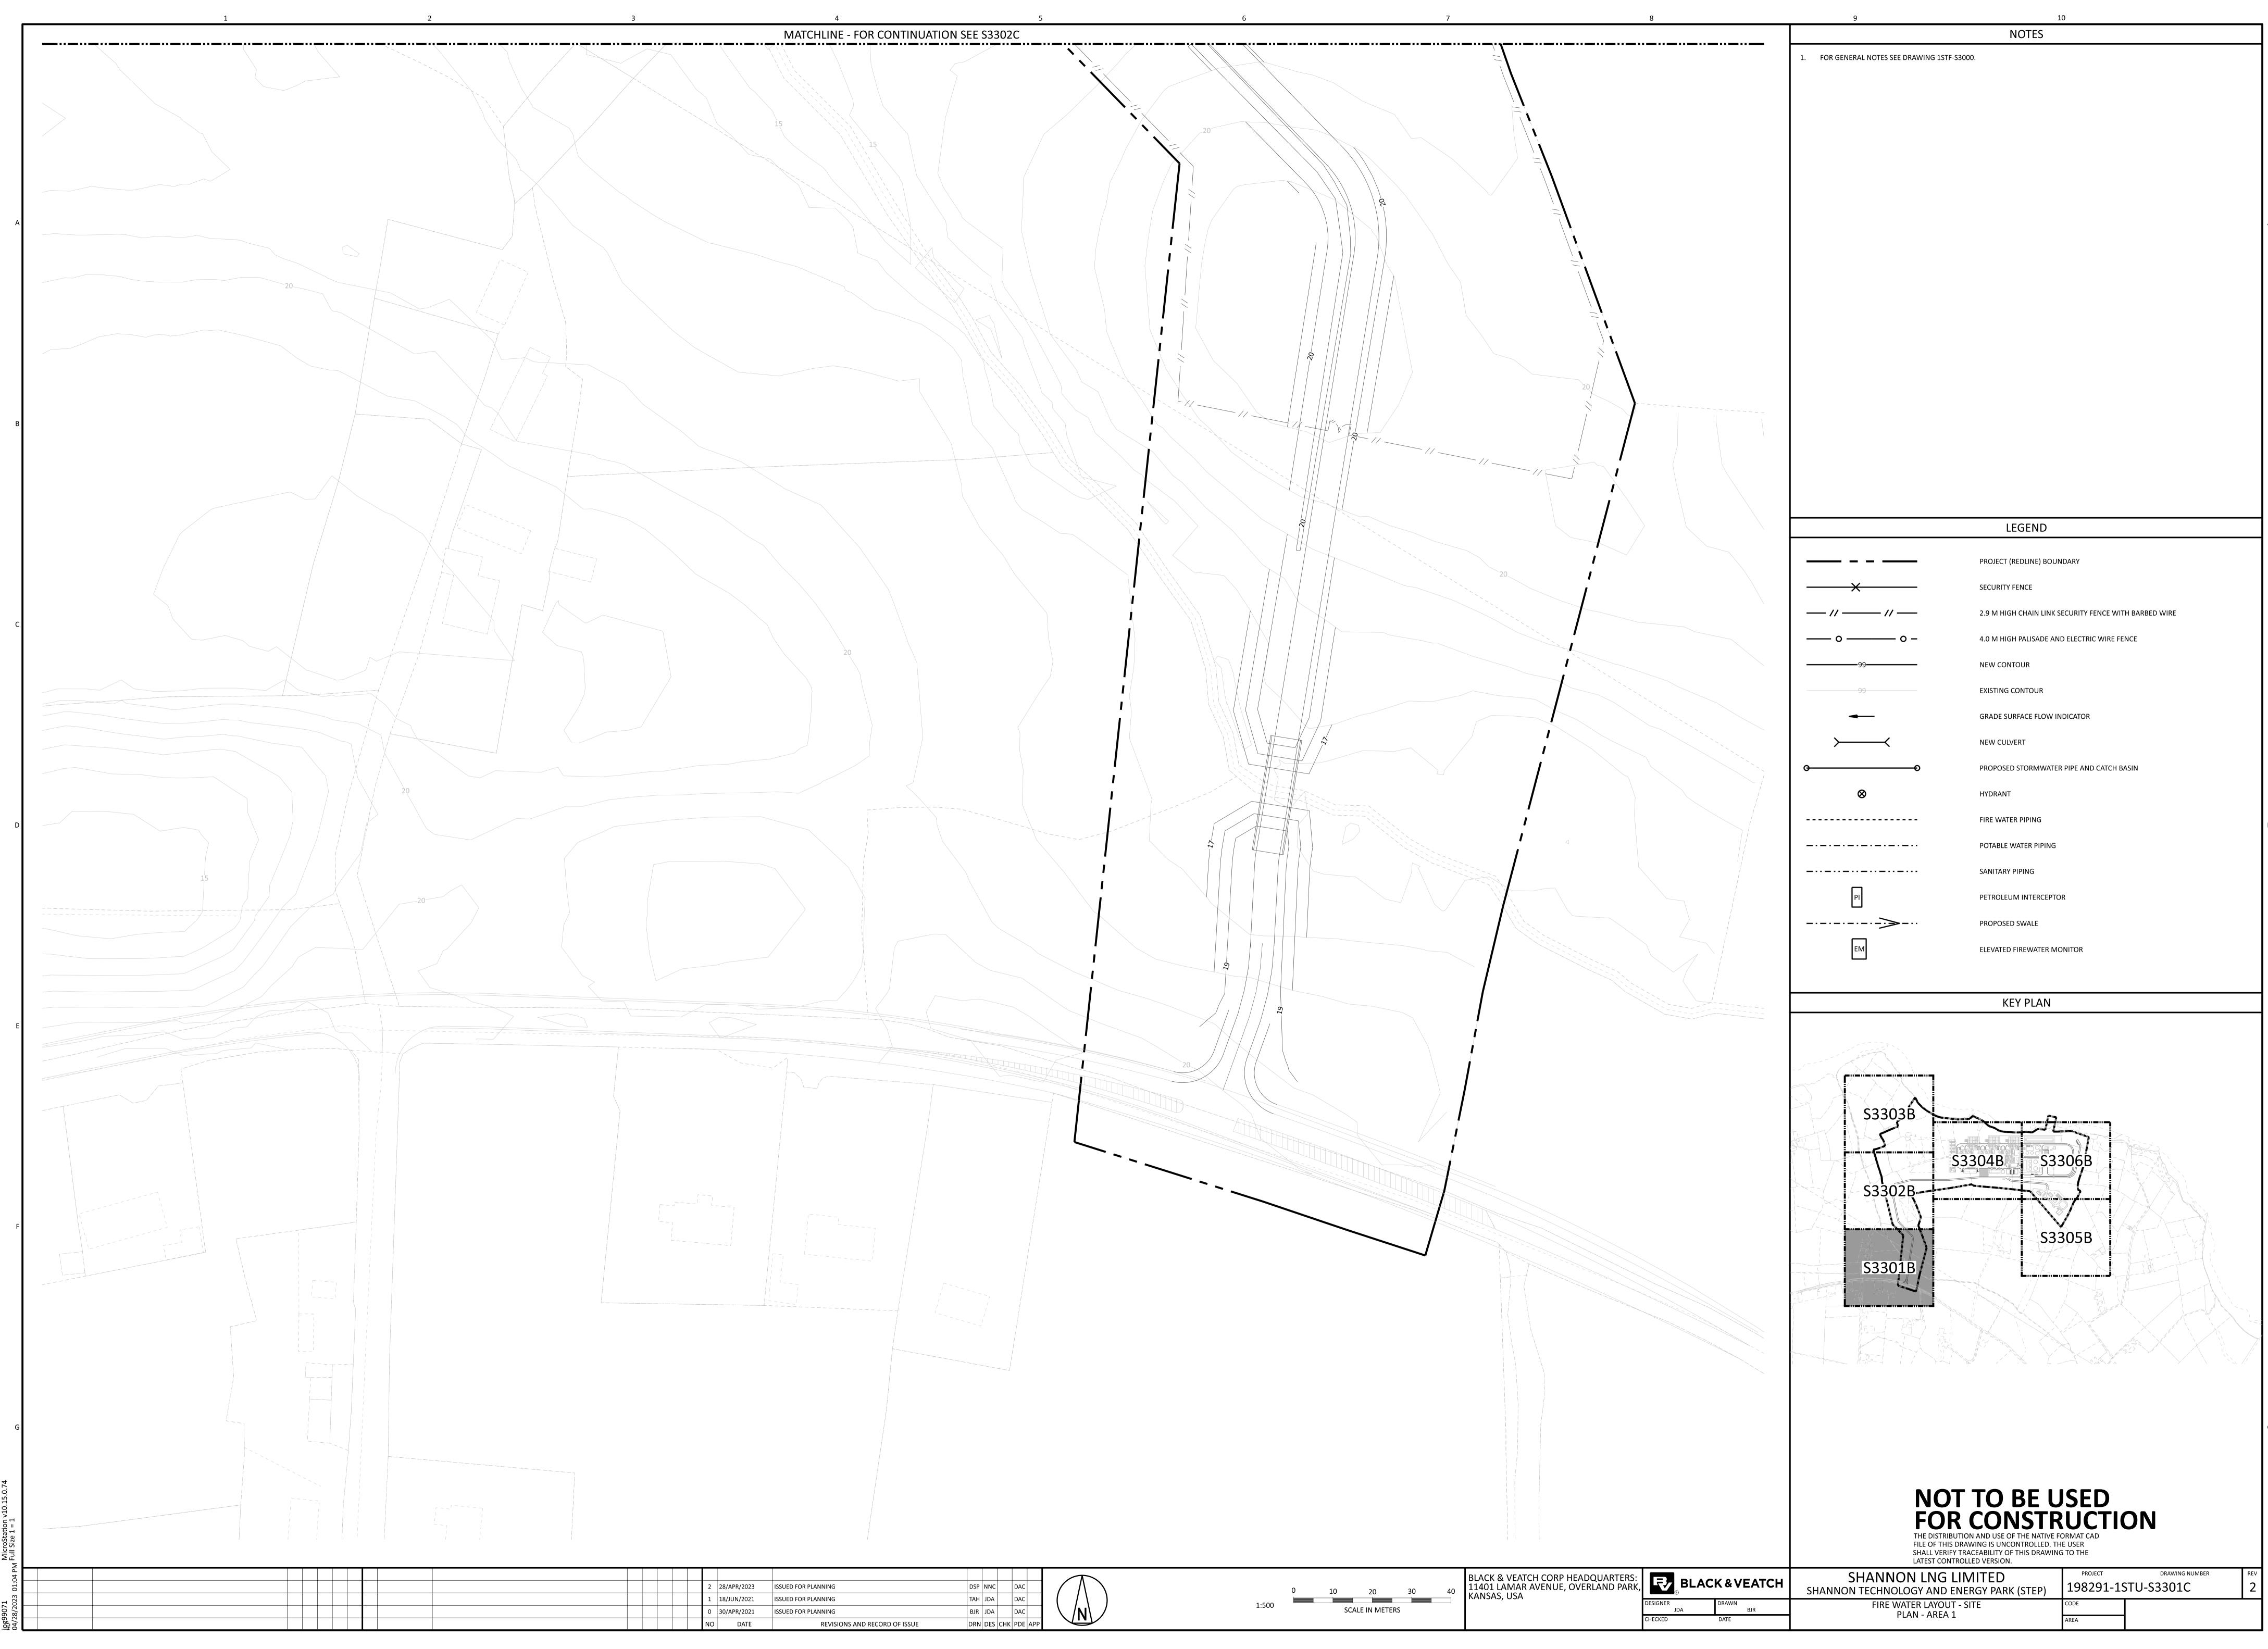

	2 28/APR/2023	ISSUED FOR PLANNING	DSP	NNC		DAC	$ \land \land \land $
	1 18/JUN/2021	ISSUED FOR PLANNING	ТАН	JDA		DAC	
	0 30/APR/2021	ISSUED FOR PLANNING	BJR	JDA		DAC	\ /N\ /
	IO DATE	REVISIONS AND RECORD OF ISSUE	DRN	DES	СНК	PDE APP	


THE DISTRIBUTION AND USE OF THE NATIVE FOR FILE OF THIS DRAWING IS UNCONTROLLED. TH SHALL VERIFY TRACEABILITY OF THIS DRAWING LATEST CONTROLLED VERSION.	ORMAT CAD E USER		
HANNON LNG LIMITED TECHNOLOGY AND ENERGY PARK (STEP)	PROJECT	DRAWING NUMBER	<sup>rev</sup>
FIRE WATER LAYOUT - SITE PLAN - AREA 1	CODE AREA		

S3303B	S3304B S3306B
S3302B S3301B	

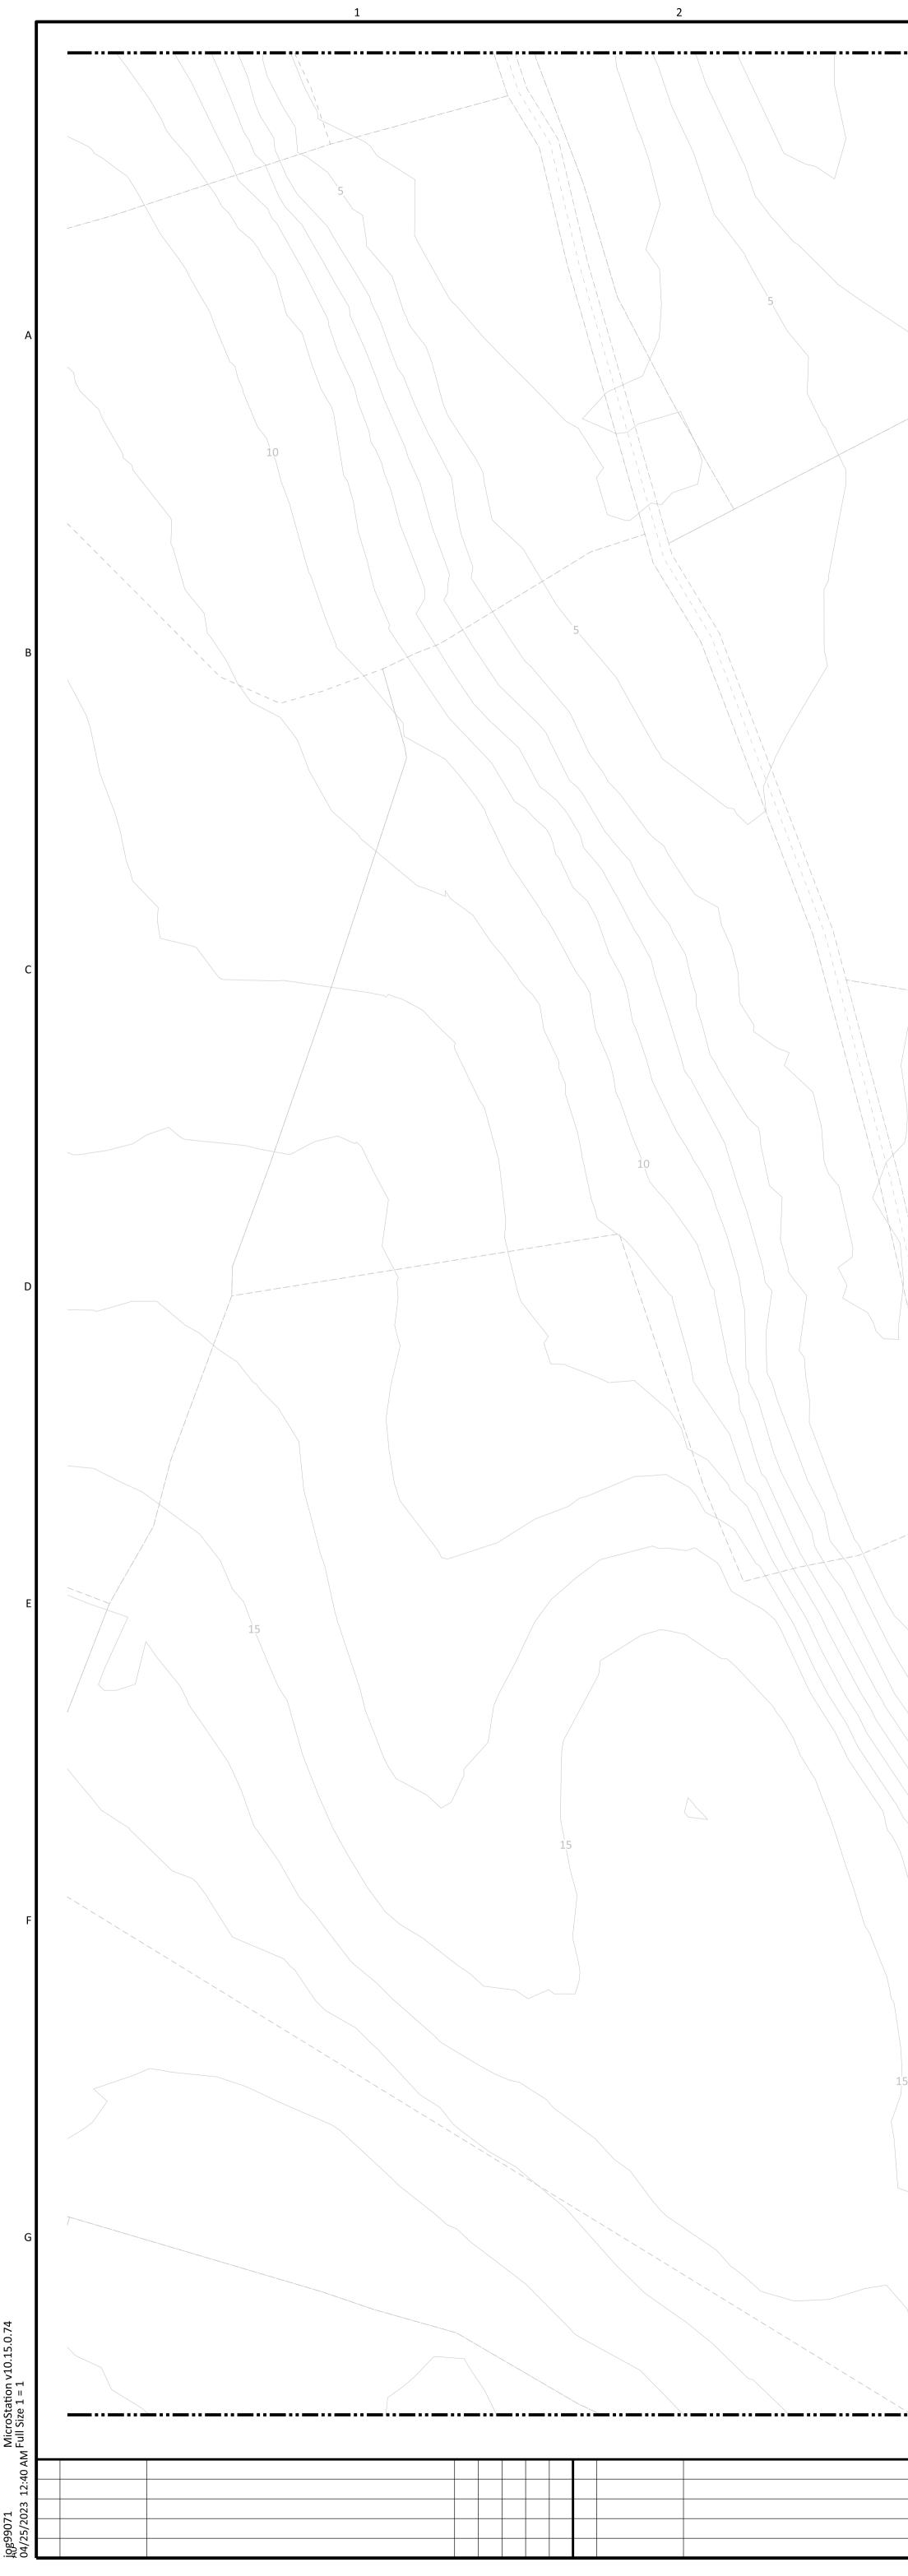


3	4 MATCHLINE - FOR CONTINU	5 ATION SEE S3303C	
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	MATCHLINE - FOR CONTINU		

			2	28/APR/2023	ISSUED FOR PLANNING	DSP	NNC		DAC		$ \land \land \land$
			1	18/JUN/2021	ISSUED FOR PLANNING	ТАН	JDA		DAC		
			0	30/APR/2021	ISSUED FOR PLANNING	BJR	JDA		DAC		\ /N\ /
			NO	DATE	REVISIONS AND RECORD OF ISSUE	DRN	DES	СНК	PDE	APP	

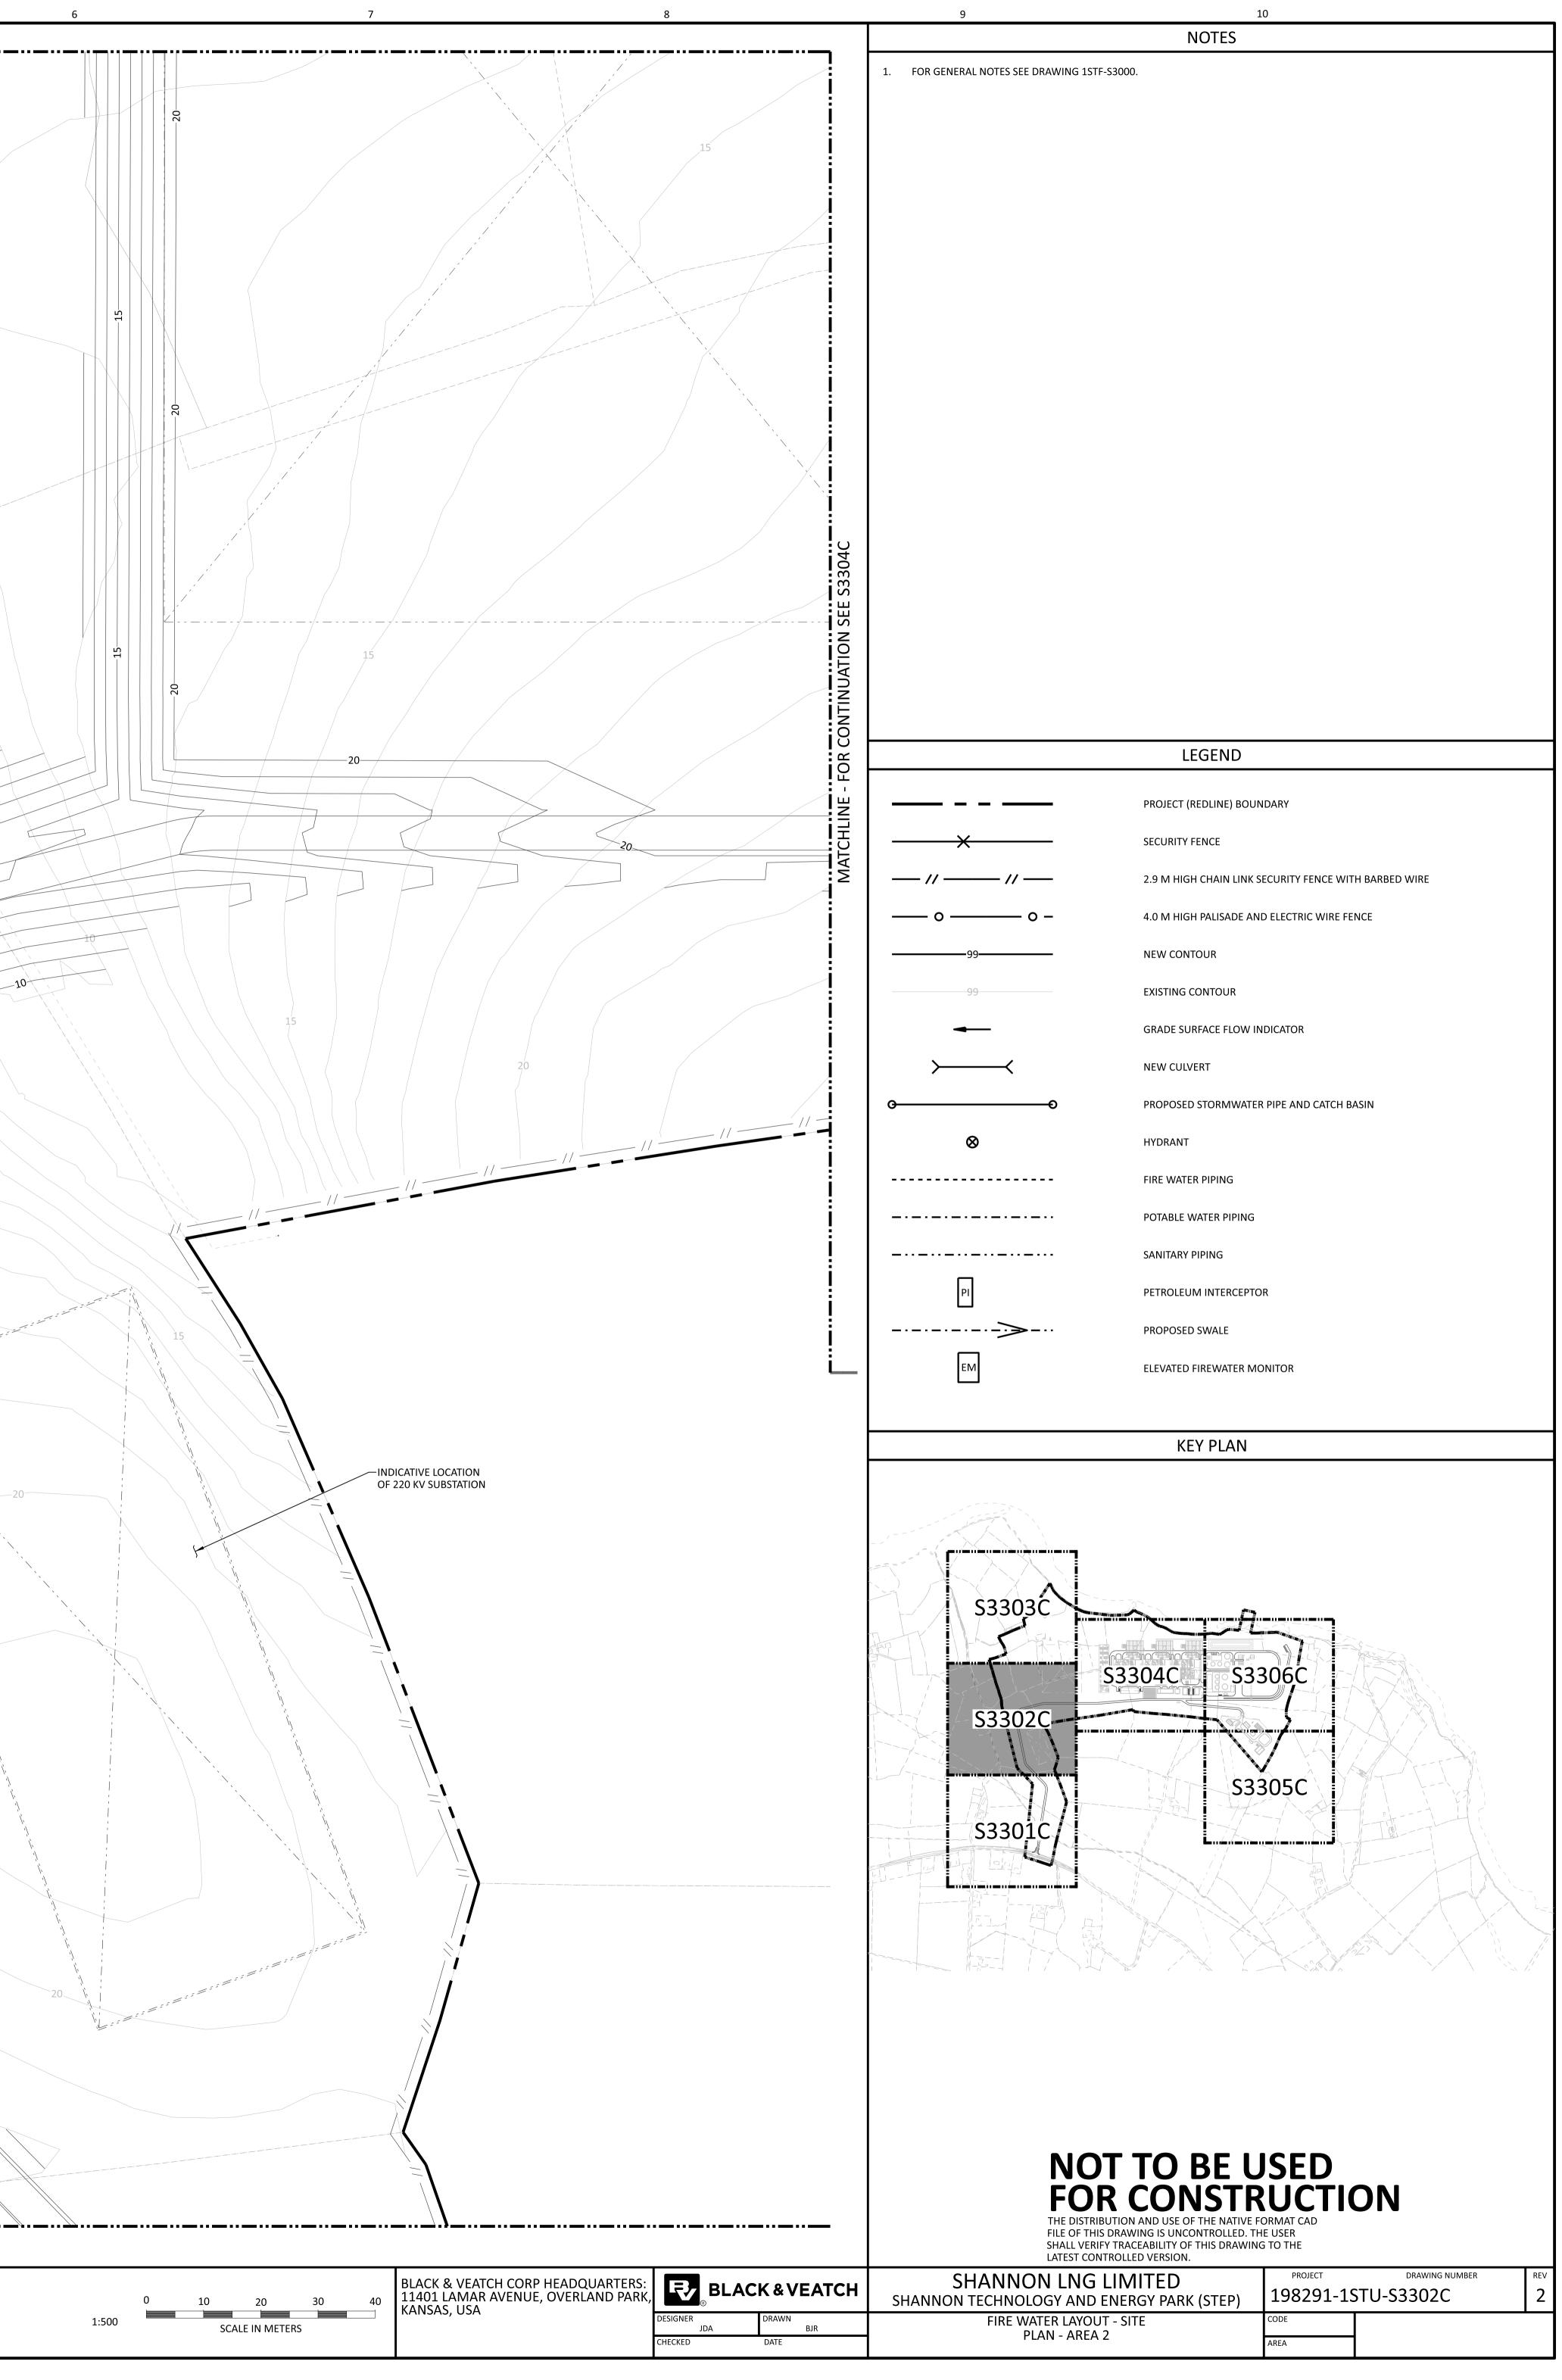


<b>NOT TO BE U</b> <b>FOR CONSTRUCTION</b> THE DISTRIBUTION AND USE OF THE NATIVE FOR FILE OF THIS DRAWING IS UNCONTROLLED. TH SHALL VERIFY TRACEABILITY OF THIS DRAWING LATEST CONTROLLED VERSION.	UCTIO DRMAT CAD E USER	ON	
SHANNON LNG LIMITED		DRAWING NUMBER	REV
NON TECHNOLOGY AND ENERGY PARK (STEP)	198291-13	STU-53302C	
FIRE WATER LAYOUT - SITE	CODE		
PLAN - AREA 2	AREA		

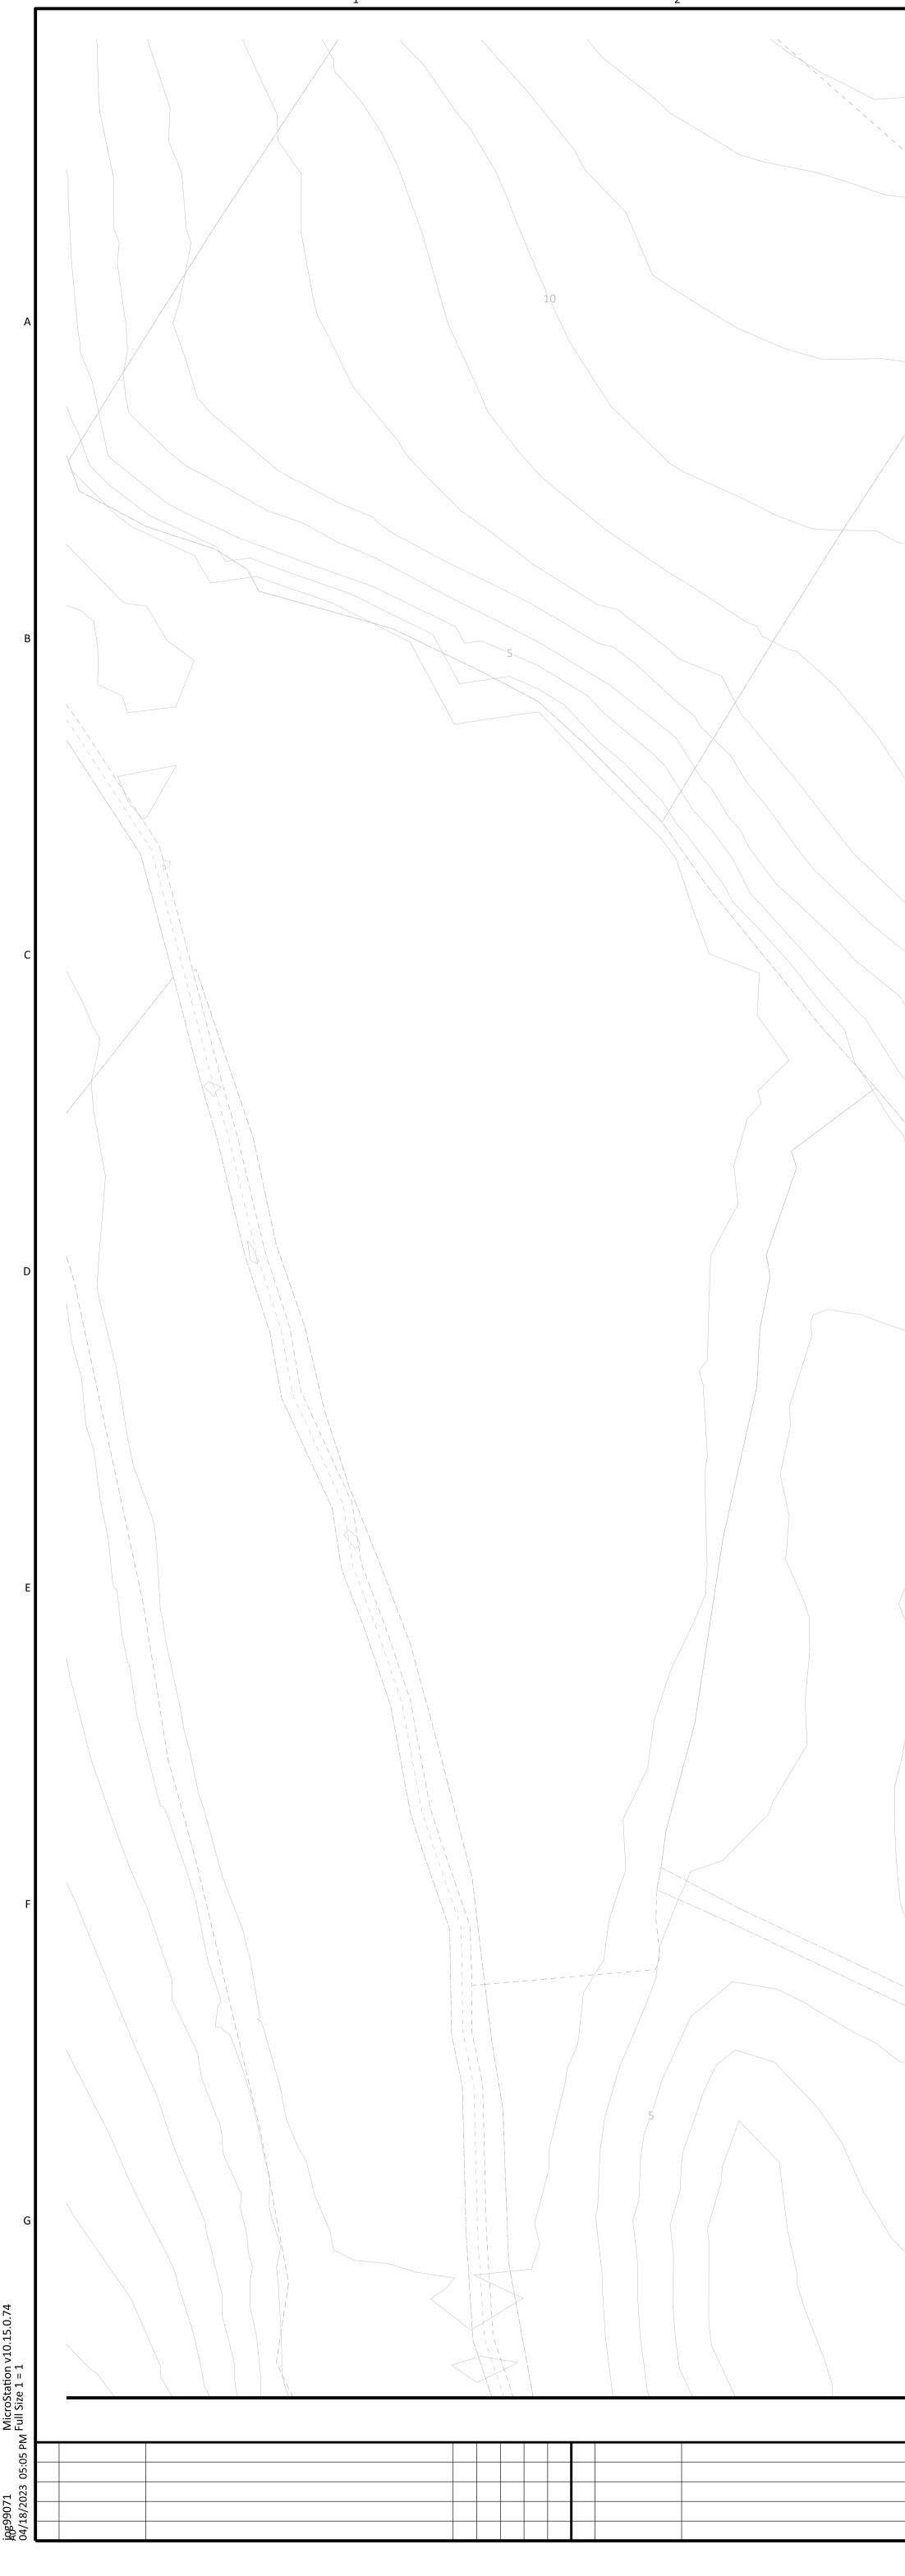


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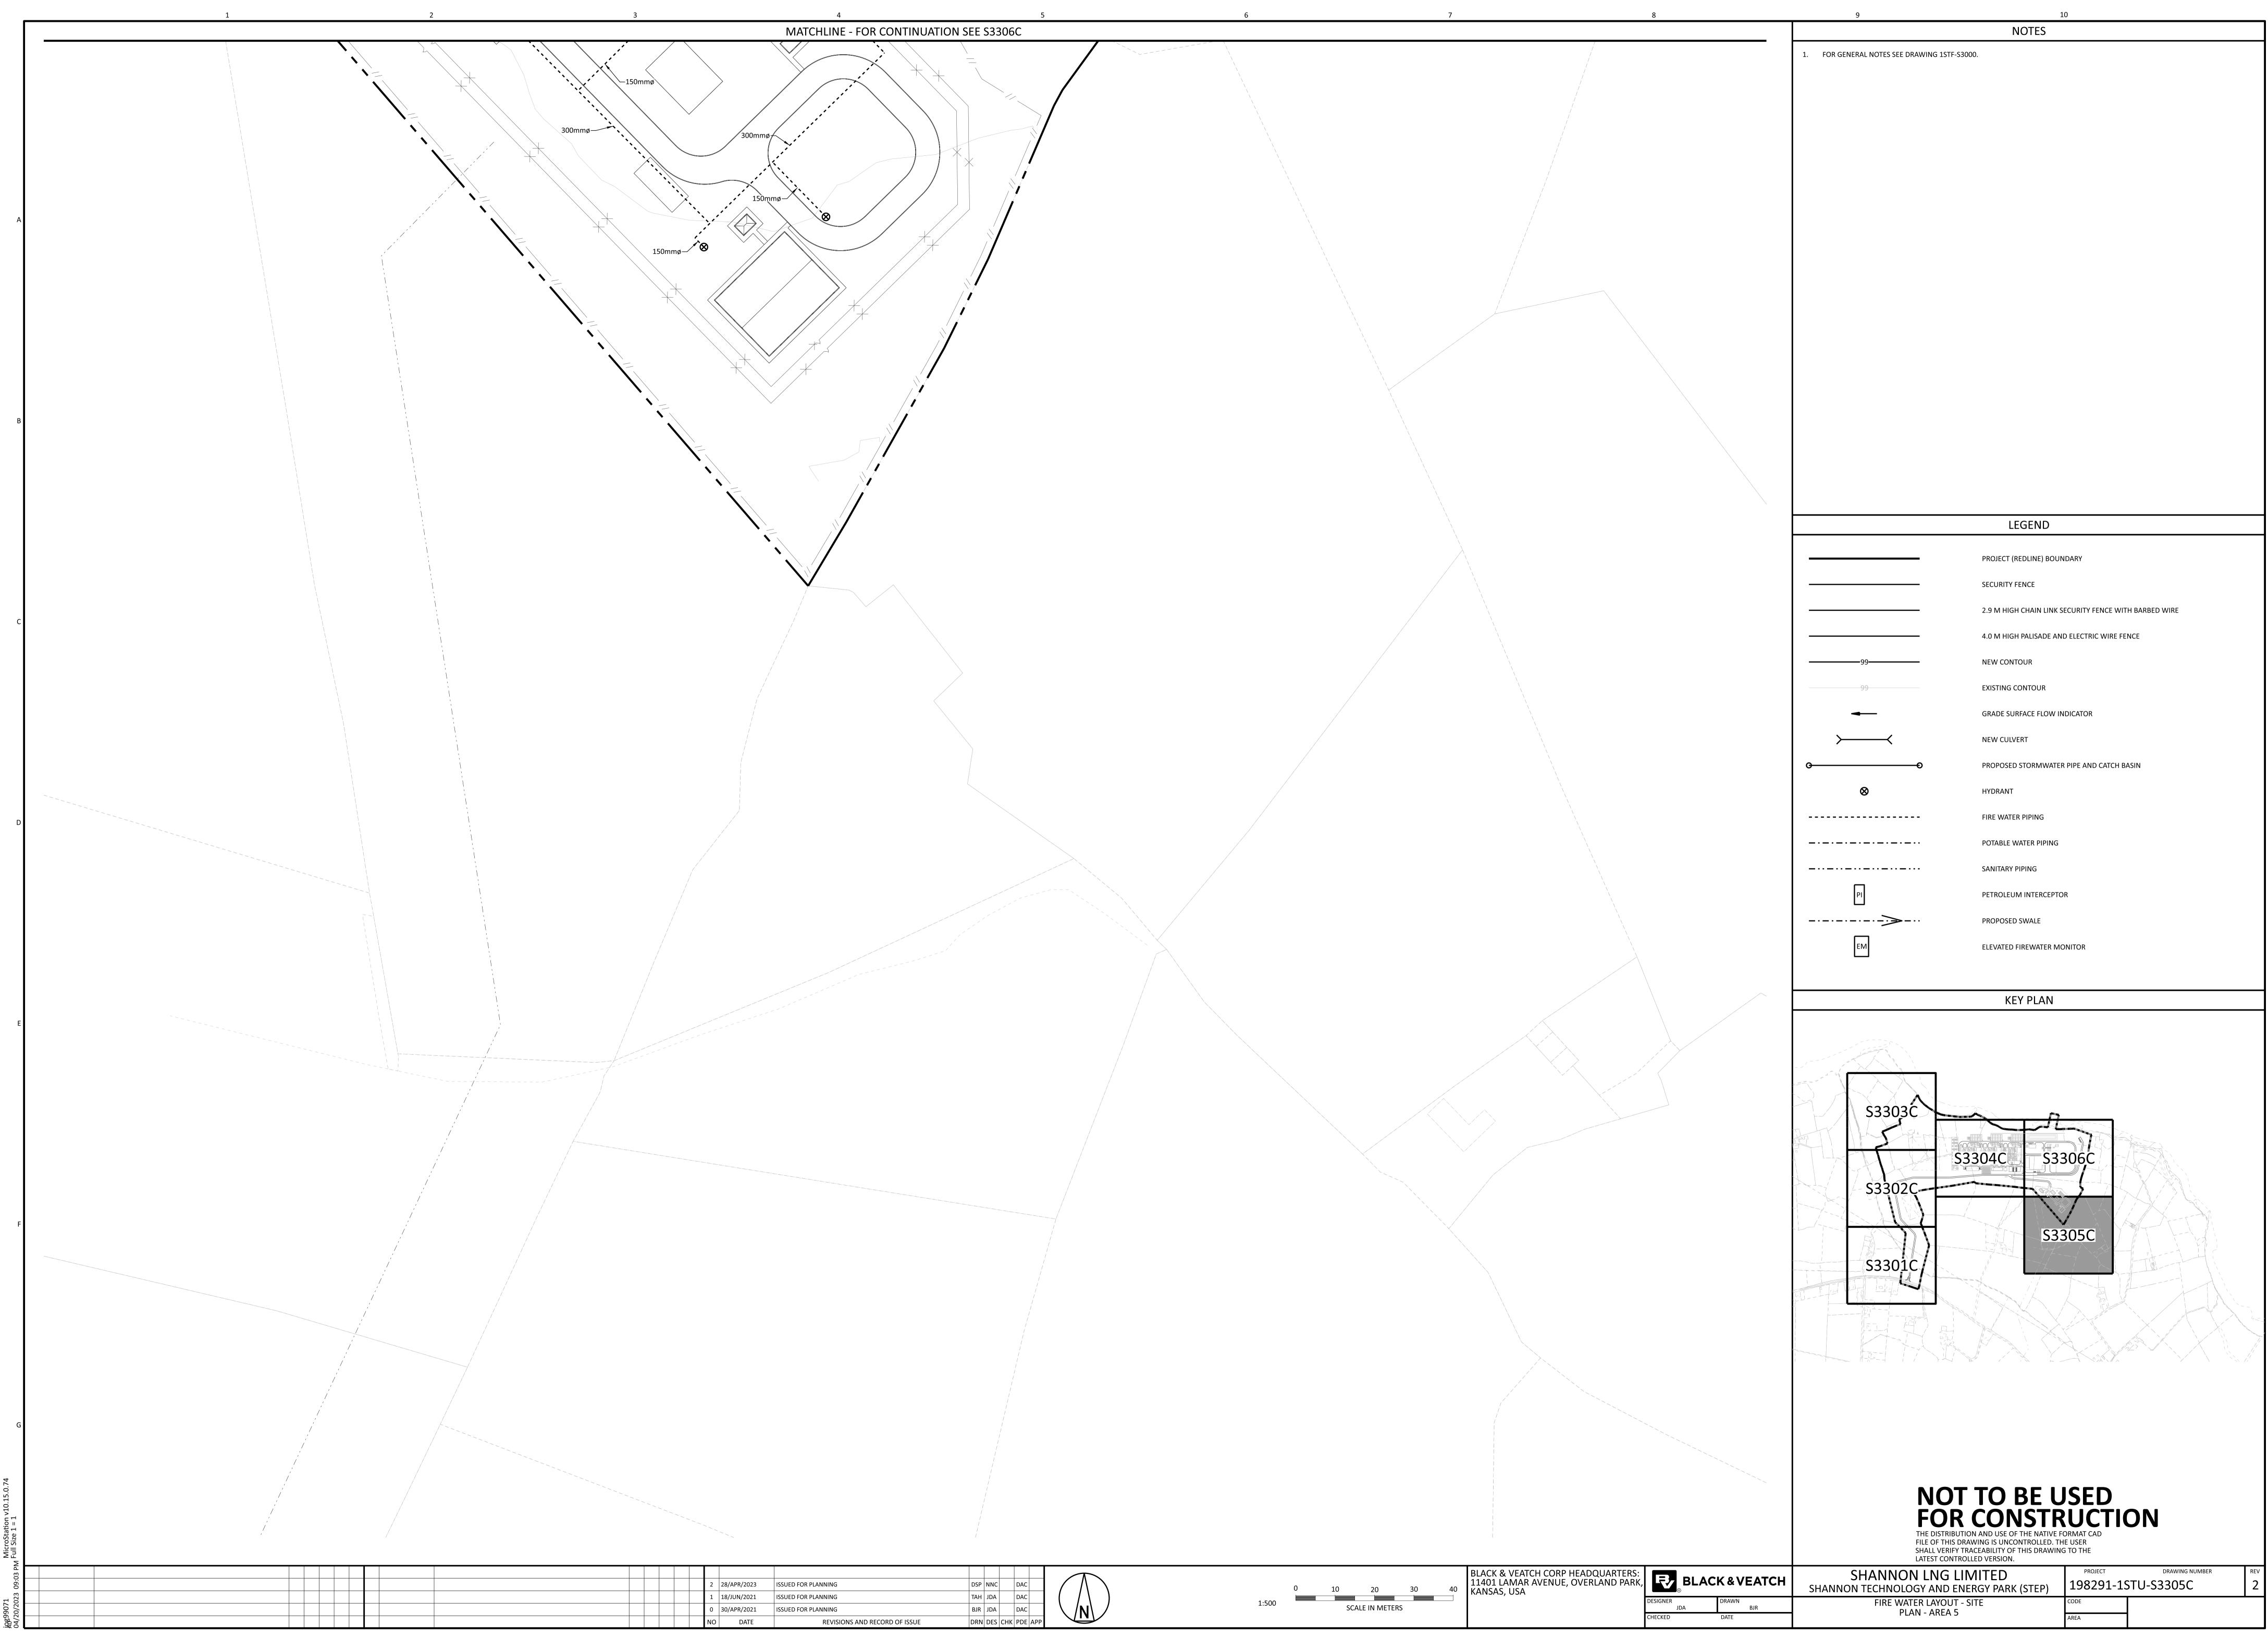
<b>NOT TO BE U</b> <b>FOR CONSTRUCTION</b> THE DISTRIBUTION AND USE OF THE NATIVE FOR FILE OF THIS DRAWING IS UNCONTROLLED. TH SHALL VERIFY TRACEABILITY OF THIS DRAWING LATEST CONTROLLED VERSION.	UCTIO DRMAT CAD E USER	ON	
SHANNON LNG LIMITED NON TECHNOLOGY AND ENERGY PARK (STEP)	PROJECT	DRAWING NUMBER	<sup>REV</sup>
FIRE WATER LAYOUT - SITE PLAN - AREA 3	CODE		

E	ELEVATED	FIREWATER	MONIT

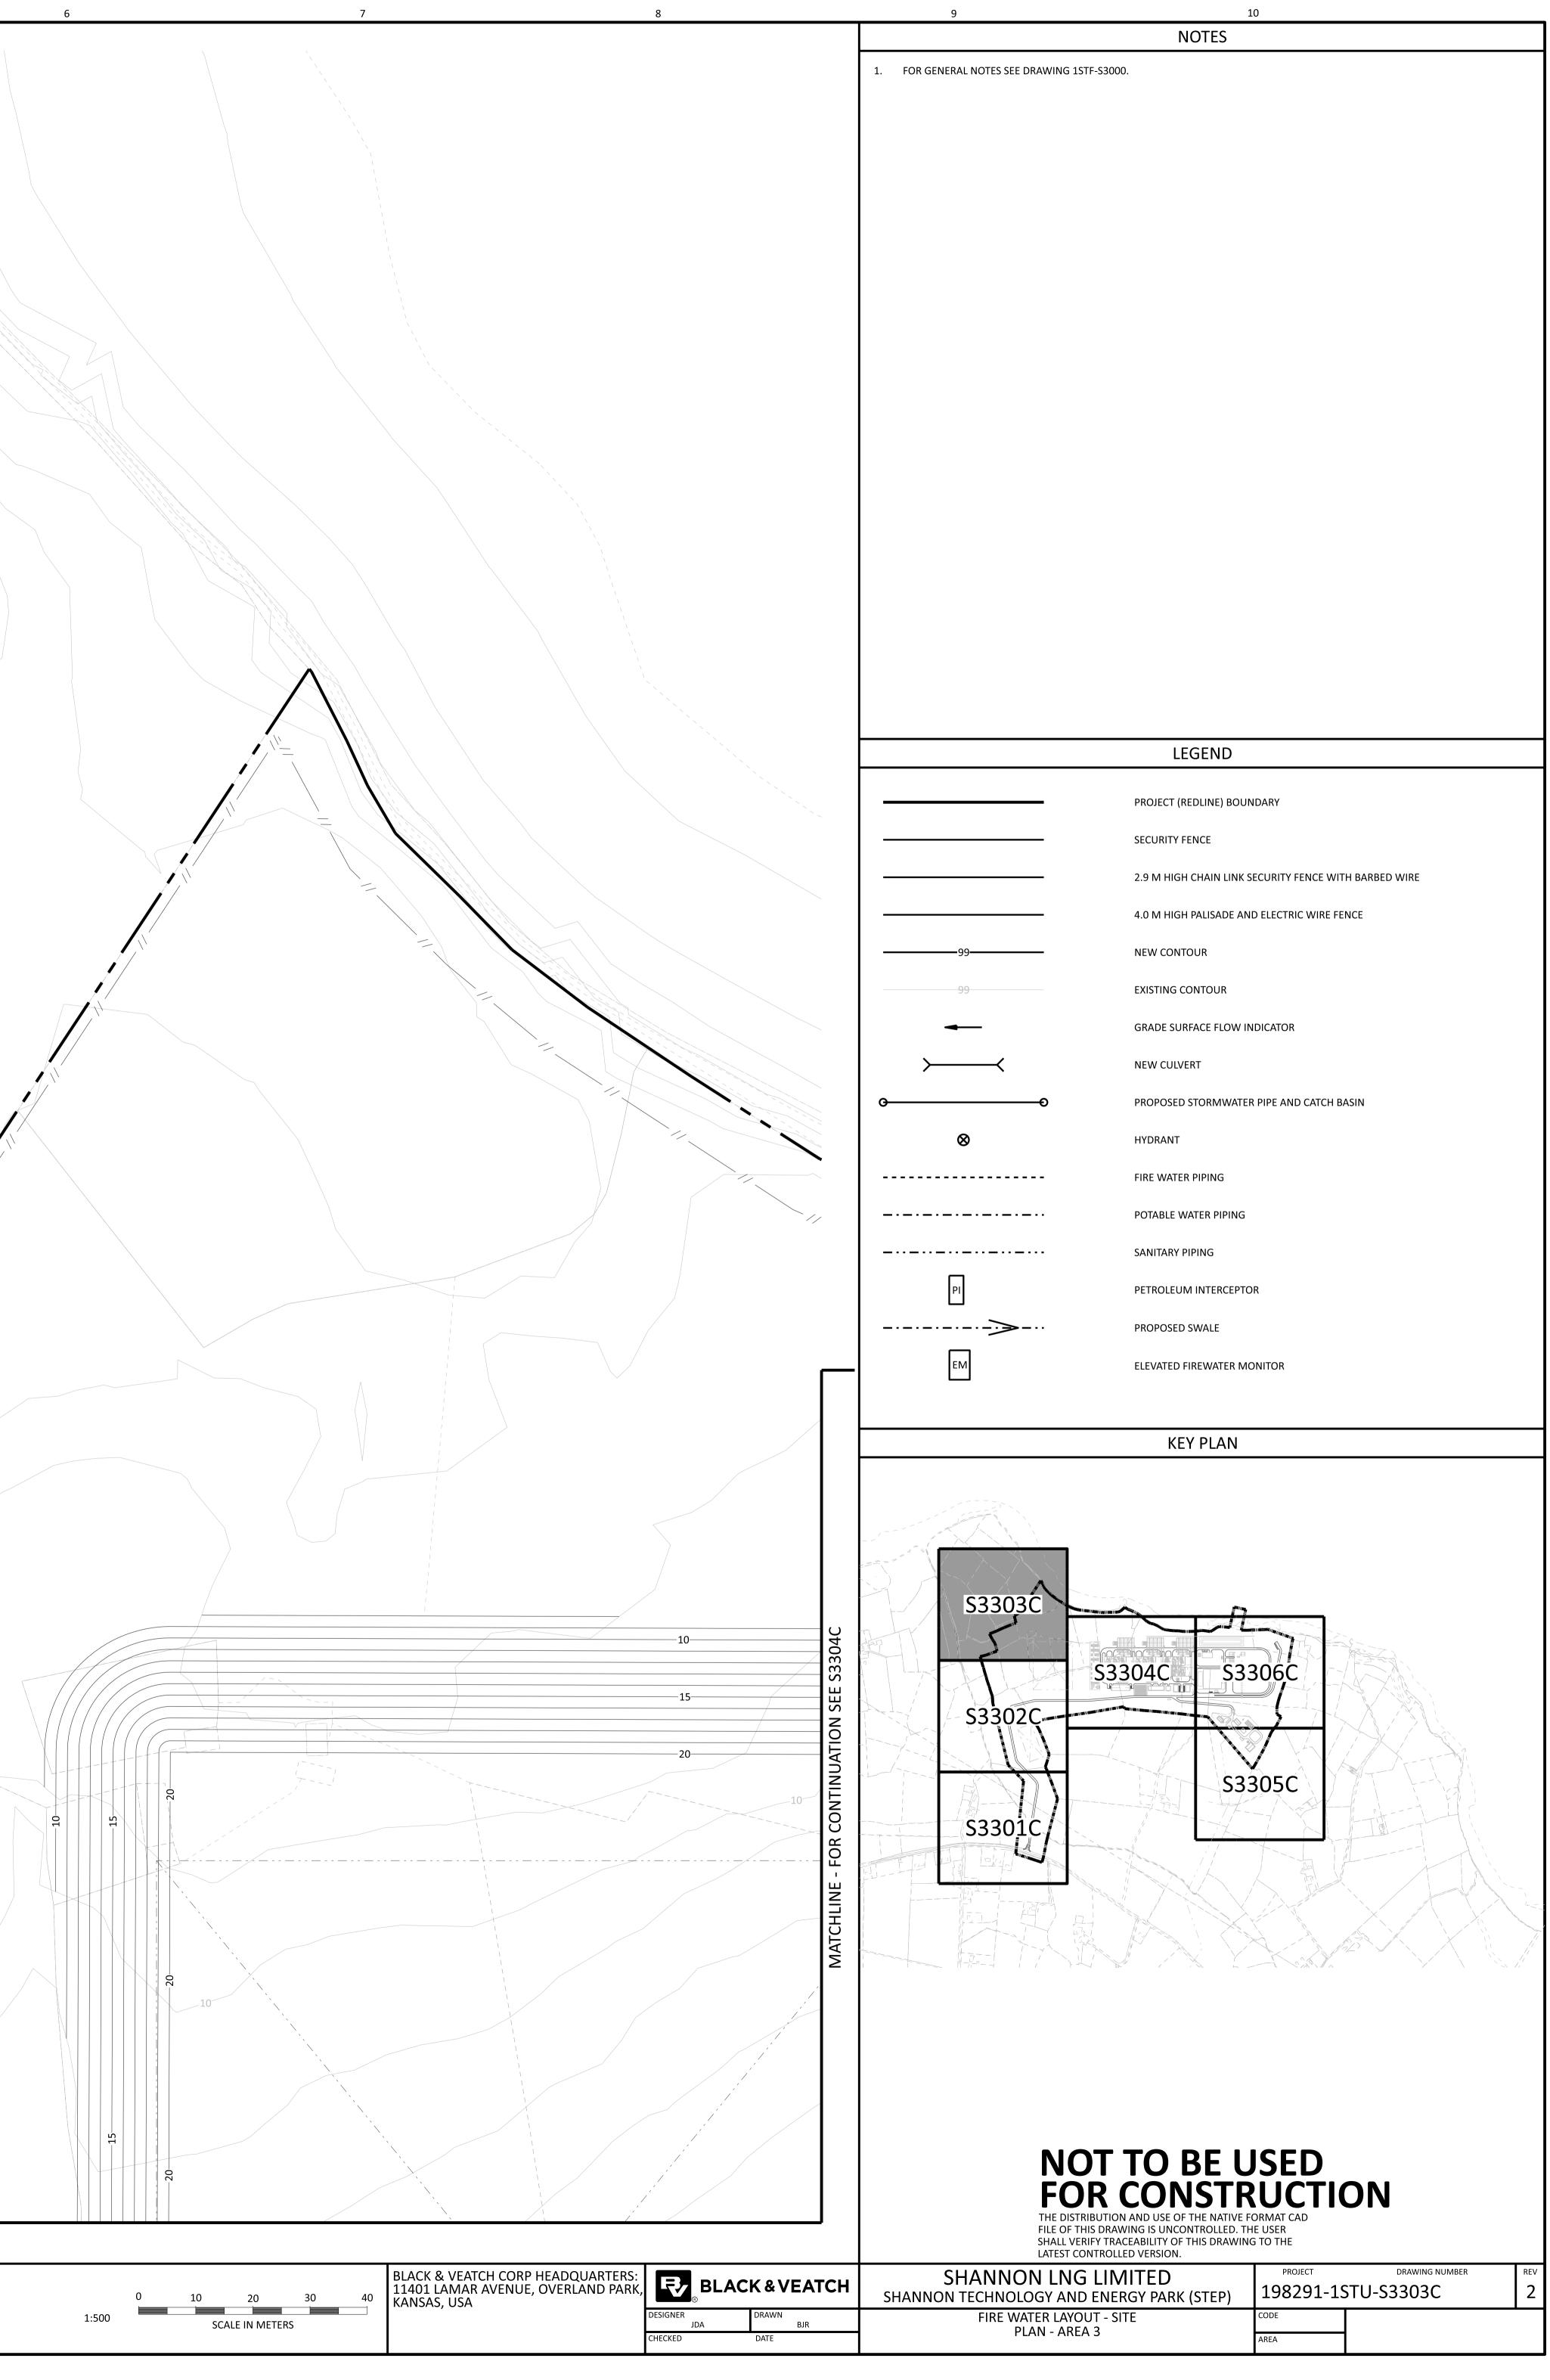


<b>NOT TO BE U</b> <b>FOR CONSTR</b> THE DISTRIBUTION AND USE OF THE NATIVE FOR FILE OF THIS DRAWING IS UNCONTROLLED. TH SHALL VERIFY TRACEABILITY OF THIS DRAWING LATEST CONTROLLED VERSION.	DRMAT CAD E USER	ON	
SHANNON LNG LIMITED INON TECHNOLOGY AND ENERGY PARK (STEP)	PROJECT 198291-15	drawing number STU-S3304C	<sup>REV</sup>
FIRE WATER LAYOUT - SITE PLAN - AREA 4	CODE		-

KE	Y PLAN

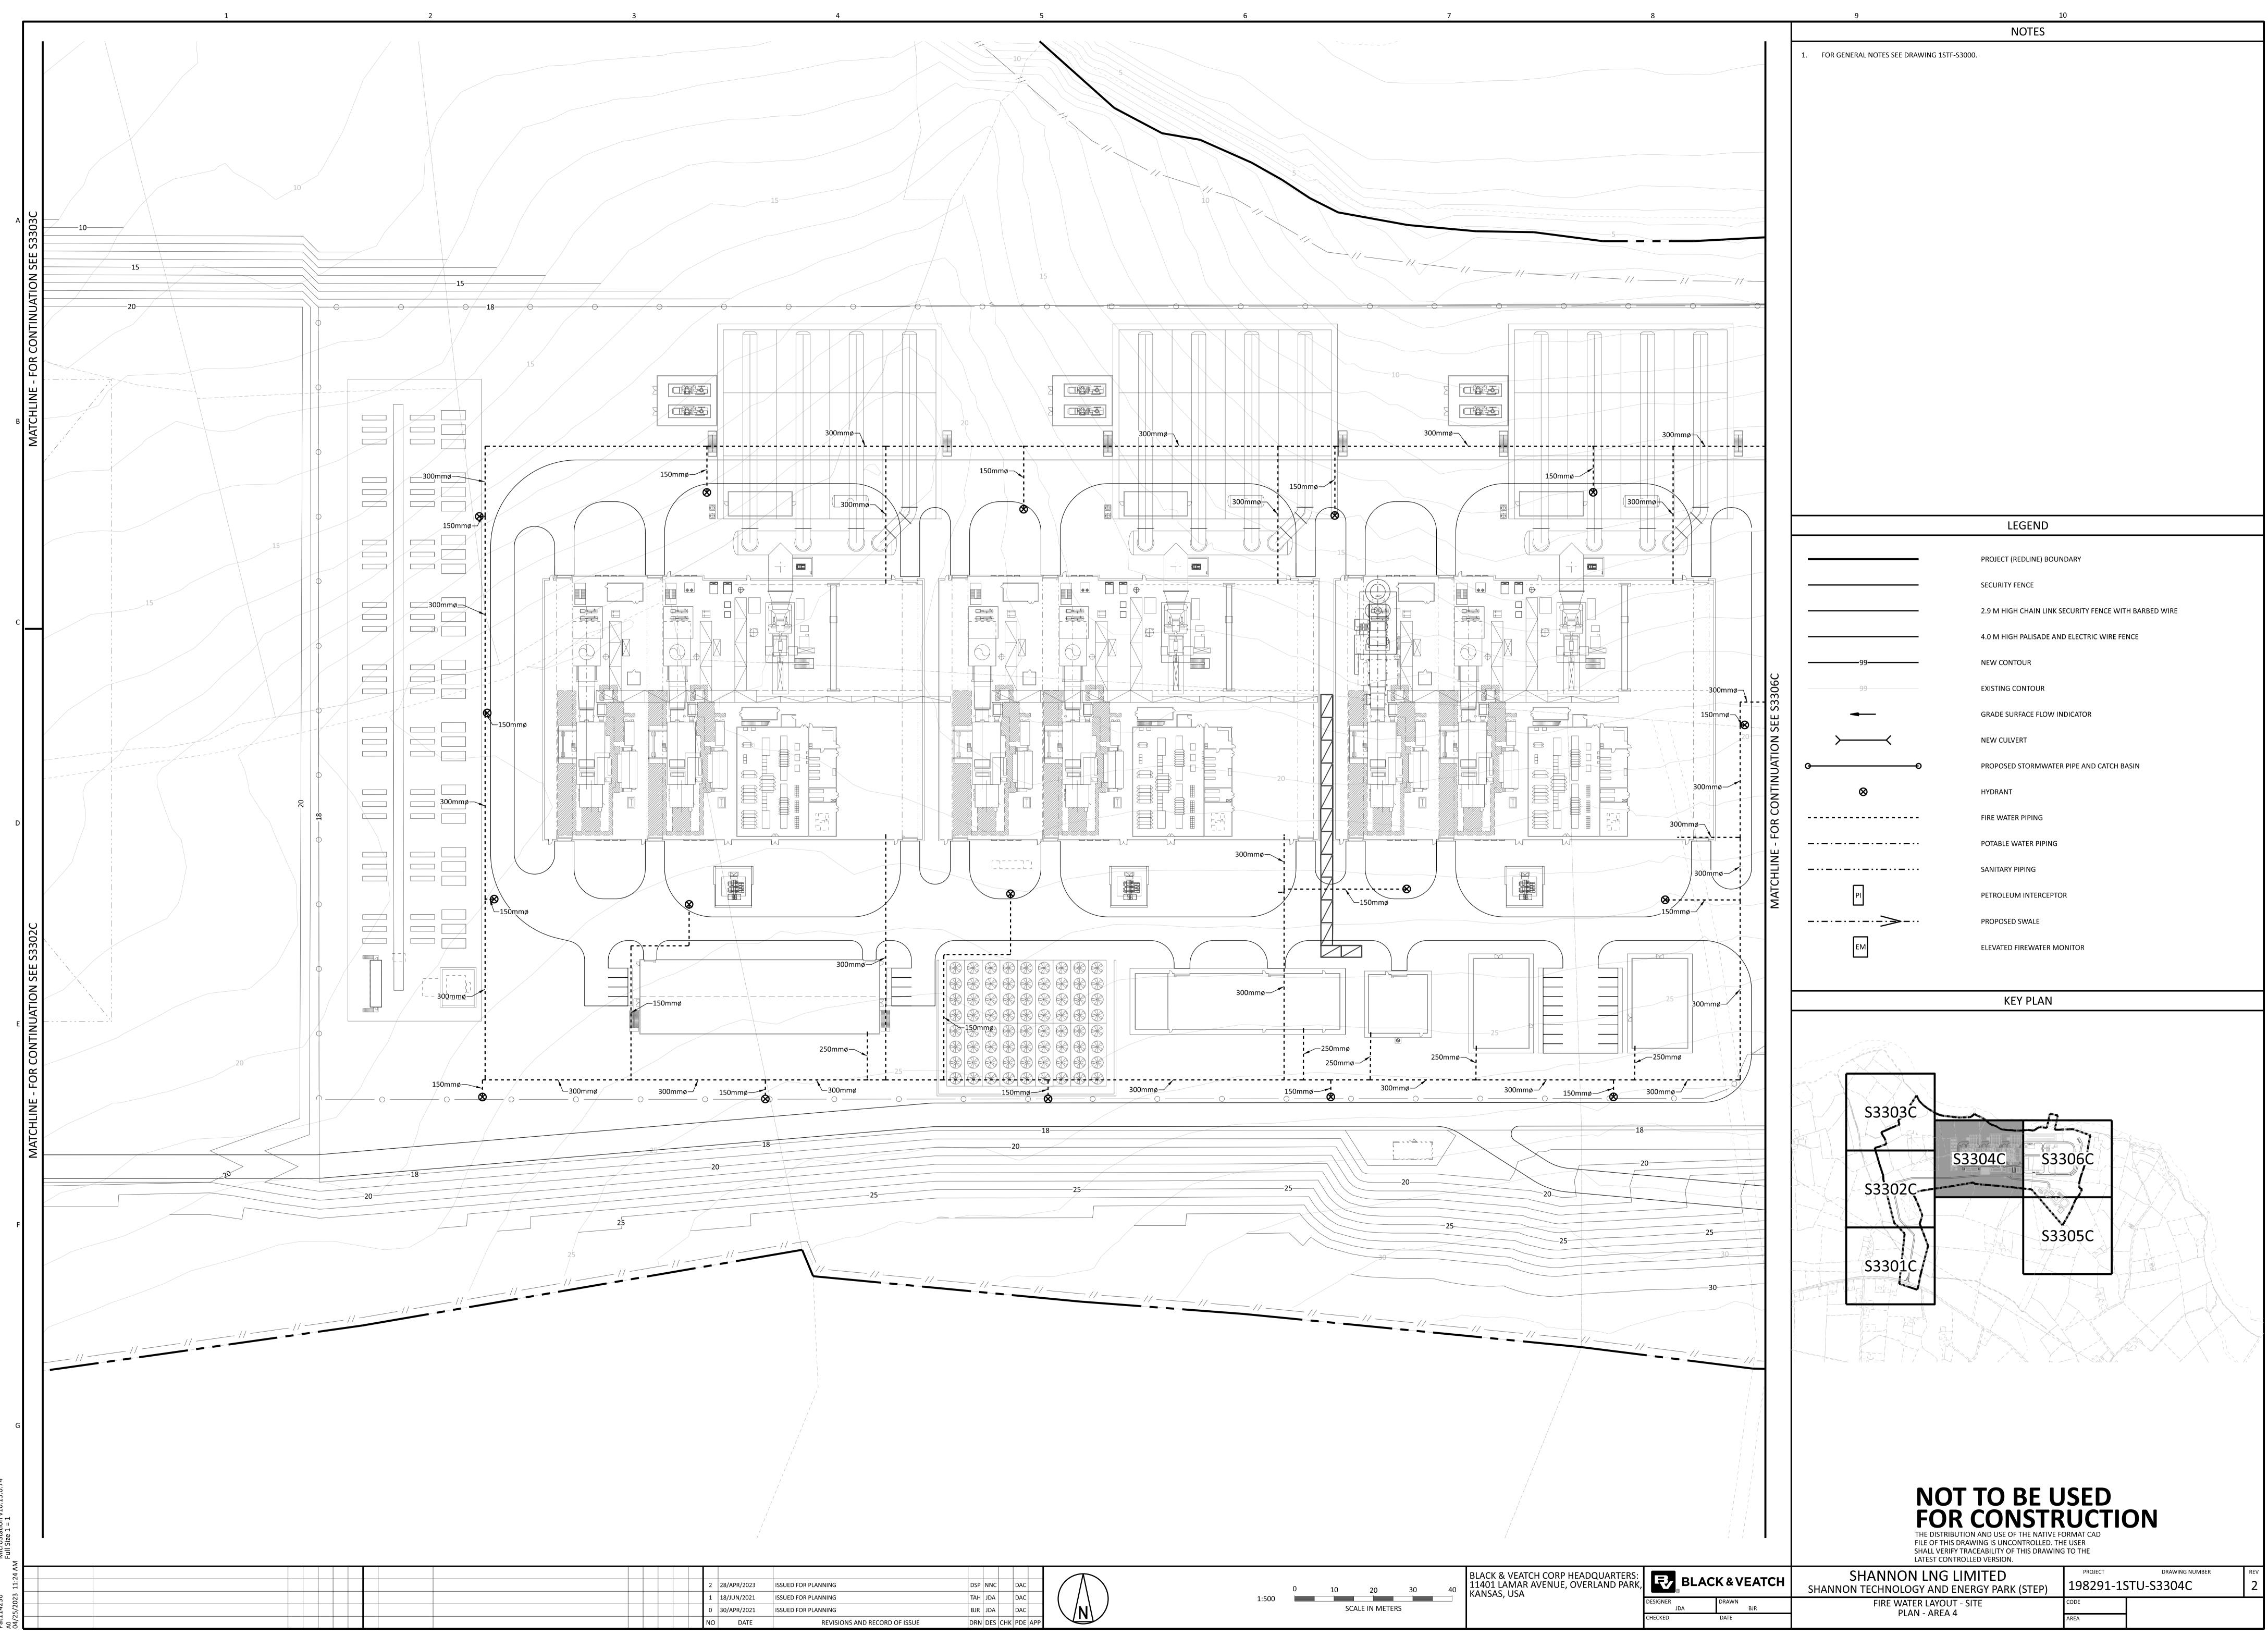

<b>NOT TO BE U</b> <b>FOR CONSTRUCTION</b> THE DISTRIBUTION AND USE OF THE NATIVE FOR FILE OF THIS DRAWING IS UNCONTROLLED. TH SHALL VERIFY TRACEABILITY OF THIS DRAWING LATEST CONTROLLED VERSION.	UCTIO DRMAT CAD E USER	ON	
SHANNON LNG LIMITED	PROJECT		REV
NNON TECHNOLOGY AND ENERGY PARK (STEP)	198291-19	STU-S3305C	2
FIRE WATER LAYOUT - SITE PLAN - AREA 5	CODE		

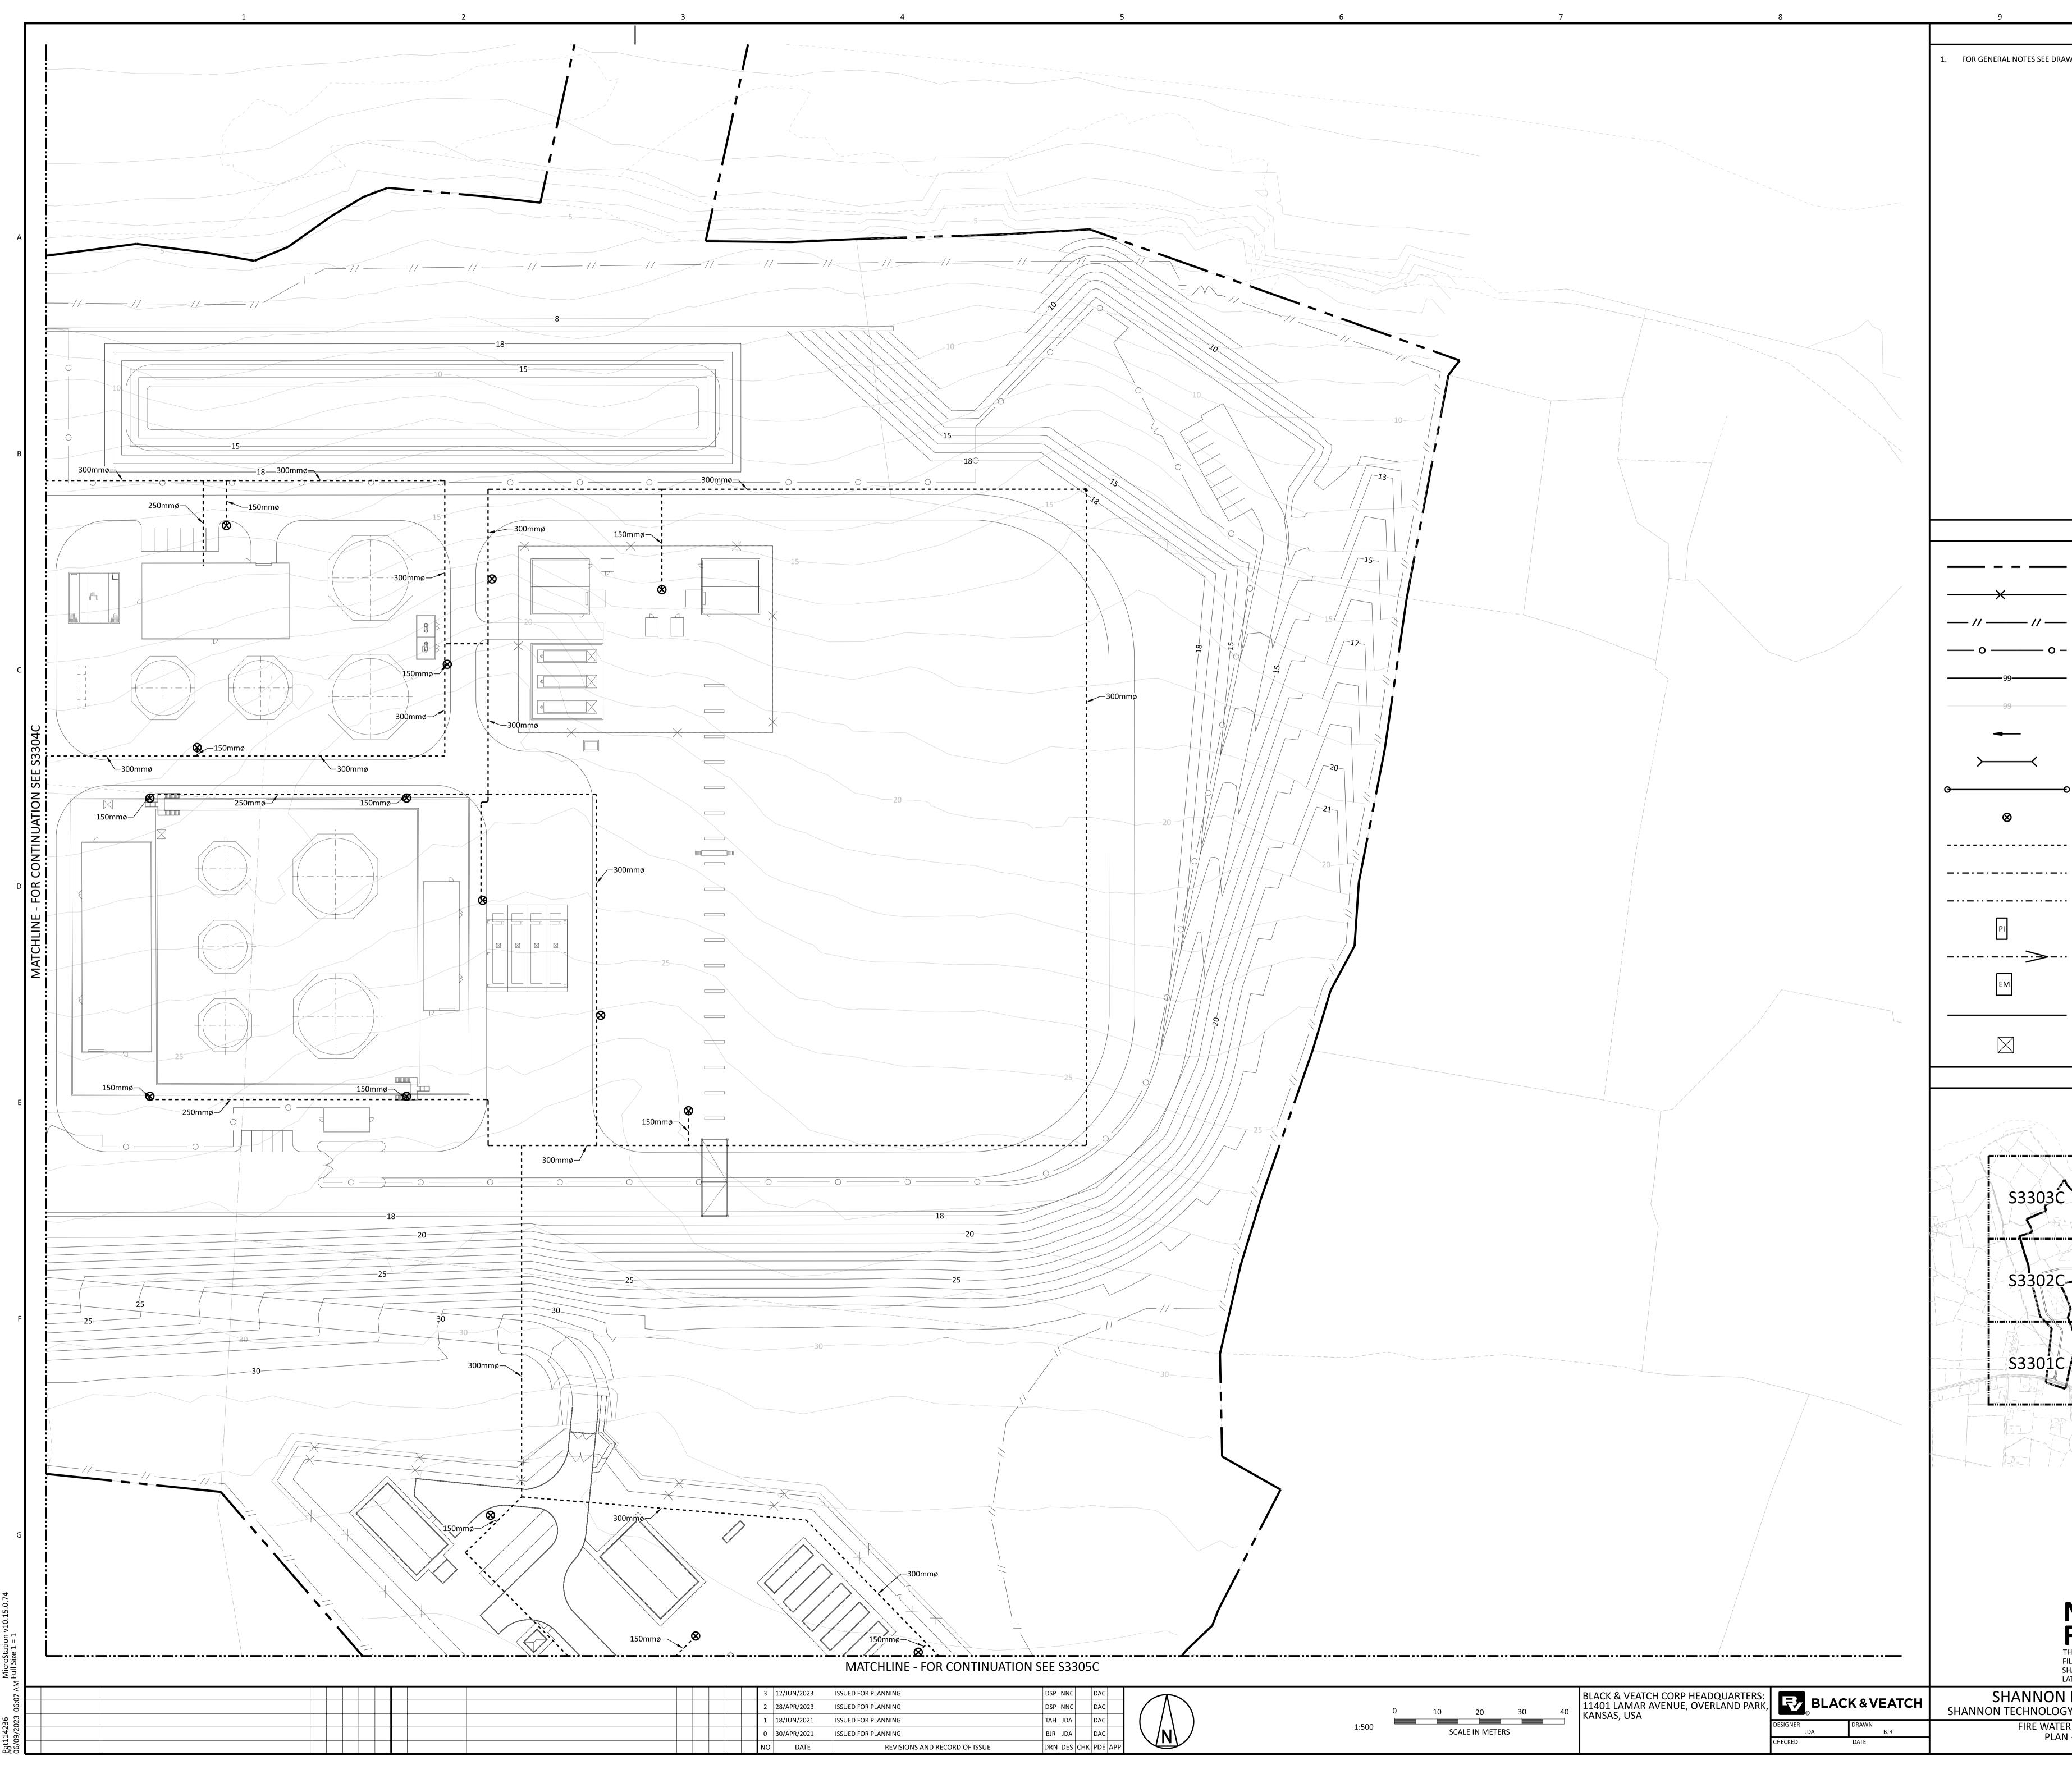

		3	12/JUN/2023	ISSUED FOR PLANNING	DSP	NNC		DAC		
		2	28/APR/2023	ISSUED FOR PLANNING	DSP	NNC		DAC		
		1	18/JUN/2021	ISSUED FOR PLANNING	TAH	JDA		DAC		
		0	30/APR/2021	ISSUED FOR PLANNING	BJR	JDA		DAC		\ /N\ /
		NO	DATE	REVISIONS AND RECORD OF ISSUE	DRN	DES	СНК	PDE	APP	

THE DISTRIBUTION AND USE OF THE NATIVE FOR FILE OF THIS DRAWING IS UNCONTROLLED. TH SHALL VERIFY TRACEABILITY OF THIS DRAWING LATEST CONTROLLED VERSION.	ORMAT CAD E USER	ON	
SHANNON LNG LIMITED ANNON TECHNOLOGY AND ENERGY PARK (STEP)	PROJECT	drawing number STU-S3306C	<sup>REV</sup>
FIRE WATER LAYOUT - SITE PLAN - AREA 6	CODE AREA		

# NOT TO BE USED

S3305C

99	EXISTING CONTOUR
◄	GRADE SURFACE FLOW INDICATOR
$\rightarrow$	NEW CULVERT
•	PROPOSED STORMWATER PIPE AND CATCH BASIN
$\otimes$	HYDRANT
	FIRE WATER PIPING
	POTABLE WATER PIPING
	SANITARY PIPING
PI	PETROLEUM INTERCEPTOR
>	PROPOSED SWALE
EM	ELEVATED FIREWATER MONITOR
	OILY DRAINAGE LINE
$\square$	FLOOR/DRAIN SUMP

KEY PLAN

S3304C

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\$330<u>3</u>C

- \$3302C...-

S3301C

LEGEND

PROJECT (REDLINE) BOUNDARY


2.9 M HIGH CHAIN LINK SECURITY FENCE WITH BARBED WIRE

4.0 M HIGH PALISADE AND ELECTRIC WIRE FENCE

SECURITY FENCE

NEW CONTOUR

1. FOR GENERAL NOTES SEE DRAWING 1STF-S3000.

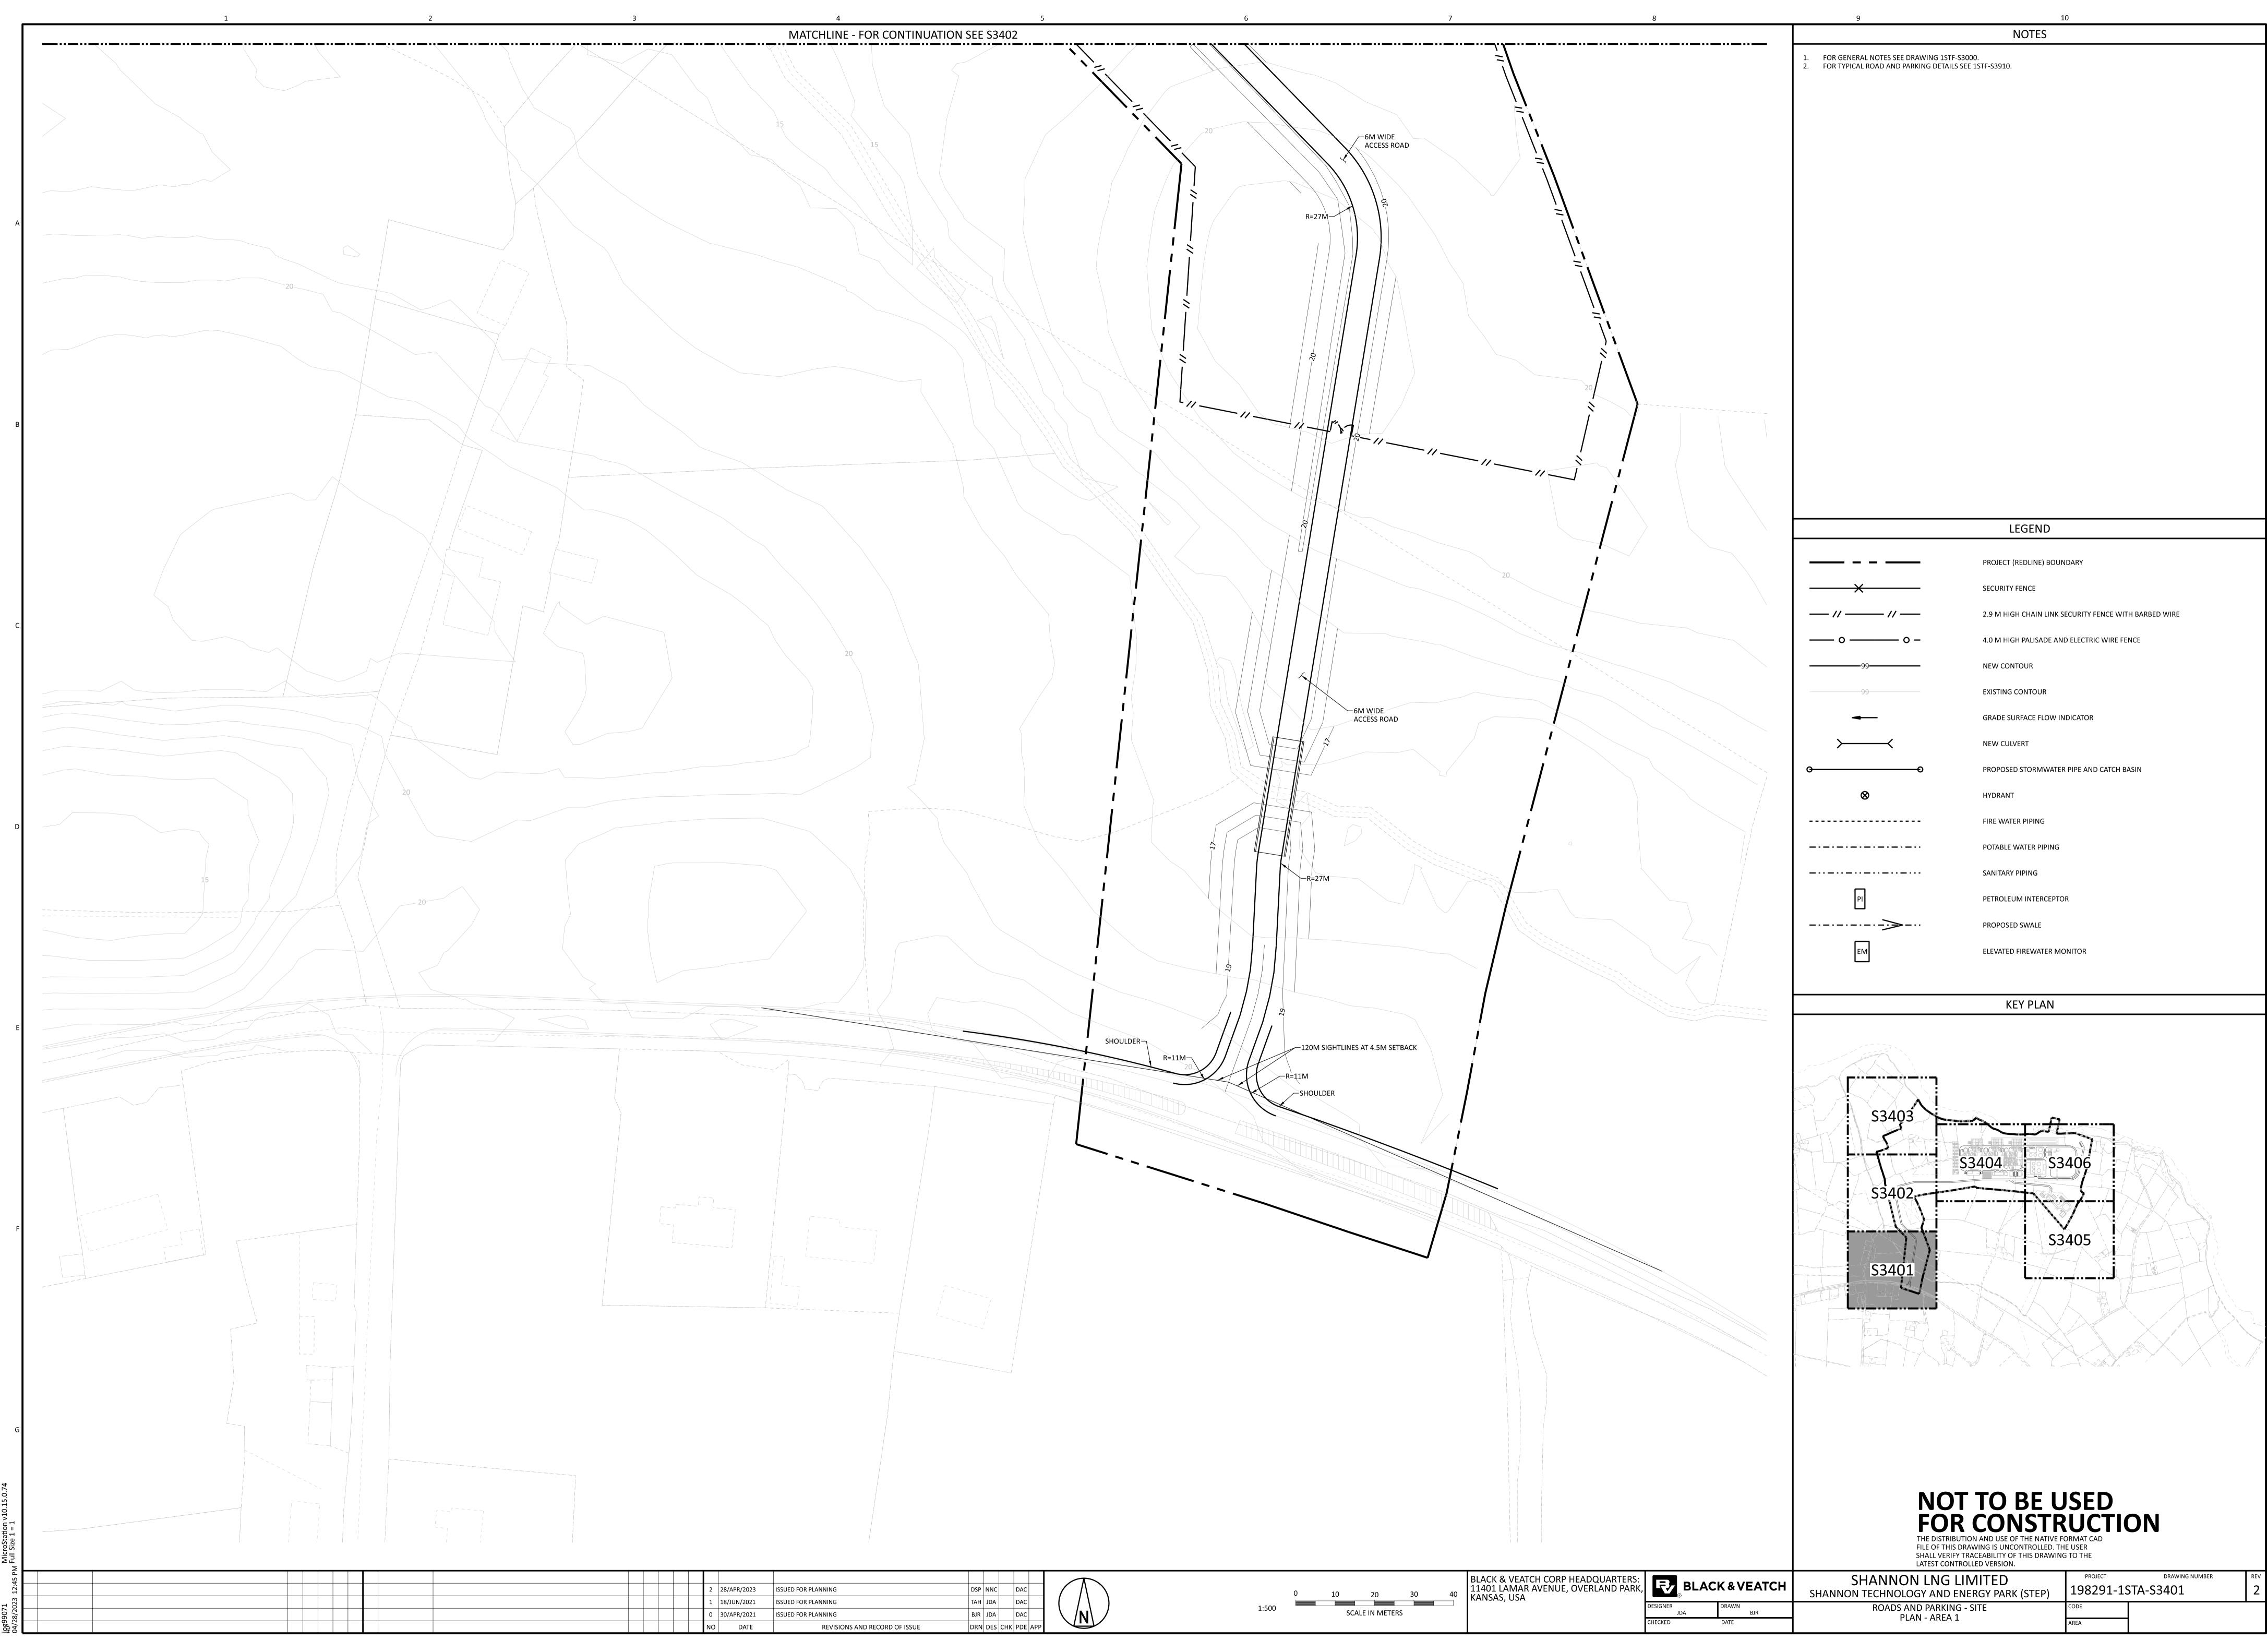


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			2	28/APR/2023	ISSUED FOR PLANNING	DSP	NNC		DAC			
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<b>NOT TO BE U</b> <b>FOR CONSTRUCTION</b> THE DISTRIBUTION AND USE OF THE NATIVE FOR FILE OF THIS DRAWING IS UNCONTROLLED. TH SHALL VERIFY TRACEABILITY OF THIS DRAWING LATEST CONTROLLED VERSION.	UCTION DRMAT CAD E USER
SHANNON LNG LIMITED	PROJECT DRAWING NUMBER REV
NNON TECHNOLOGY AND ENERGY PARK (STEP)	198291-1STA-S3401 2
ROADS AND PARKING - SITE	CODE
PLAN - AREA 1	AREA




			2	28/APR/2023	ISSUED FOR PLANNING	DSP	NNC		DAC	$ \land \land \land$
			1	18/JUN/2021	ISSUED FOR PLANNING	TAH	JDA		DAC	
			0	30/APR/2021	ISSUED FOR PLANNING	BJR	JDA		DAC	\ /N\ /
			NO	DATE	REVISIONS AND RECORD OF ISSUE	DRN	DES	СНК	PDE APP	


<b>NOT TO BE U</b> <b>FOR CONSTR</b> THE DISTRIBUTION AND USE OF THE NATIVE FO FILE OF THIS DRAWING IS UNCONTROLLED. TH SHALL VERIFY TRACEABILITY OF THIS DRAWING LATEST CONTROLLED VERSION.	UCTIO DRMAT CAD E USER	ON	
SHANNON LNG LIMITED	PROJECT		REV
NNON TECHNOLOGY AND ENERGY PARK (STEP)	198291-19	51A-534UZ	2
ROADS AND PARKING - SITE PLAN - AREA 2	CODE AREA		

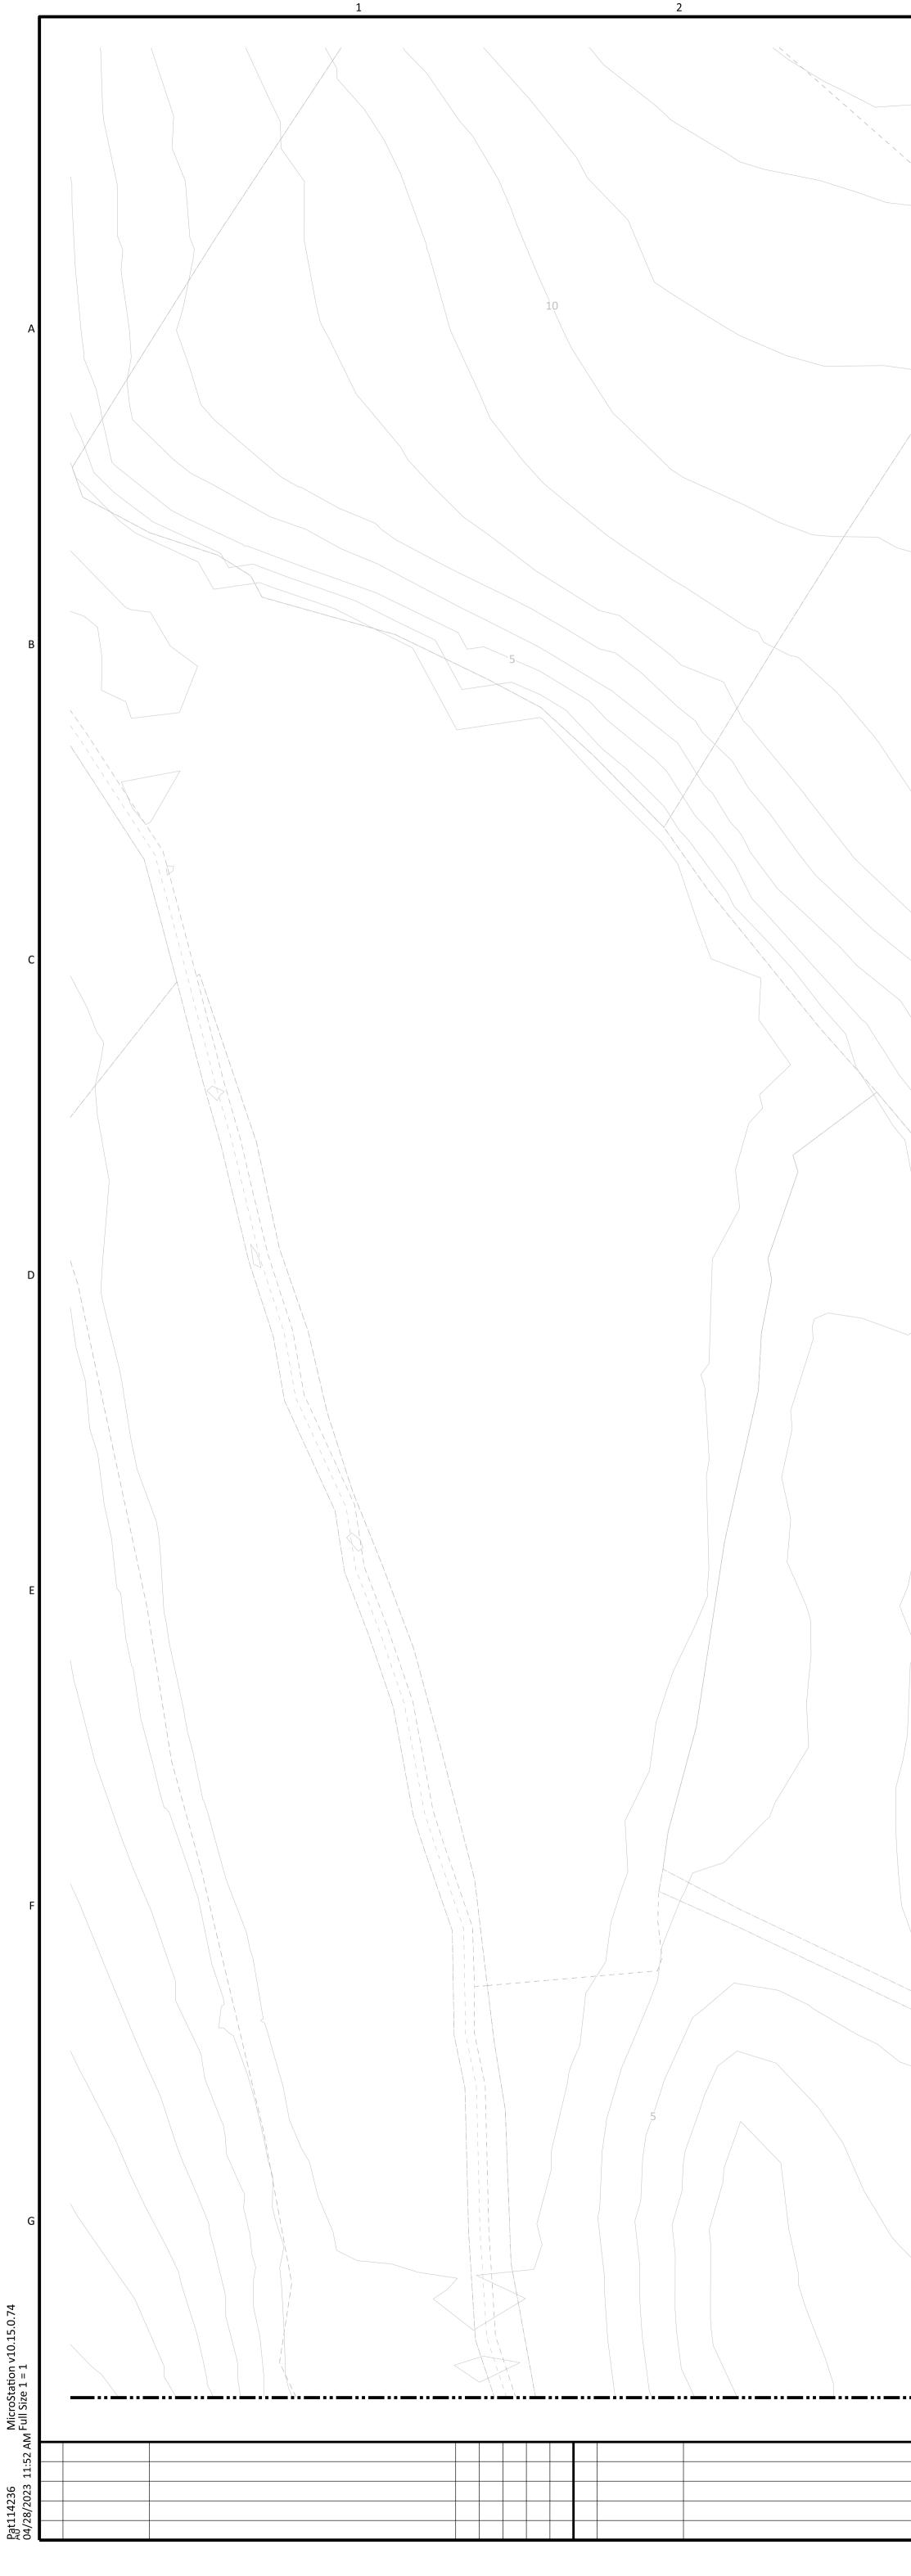


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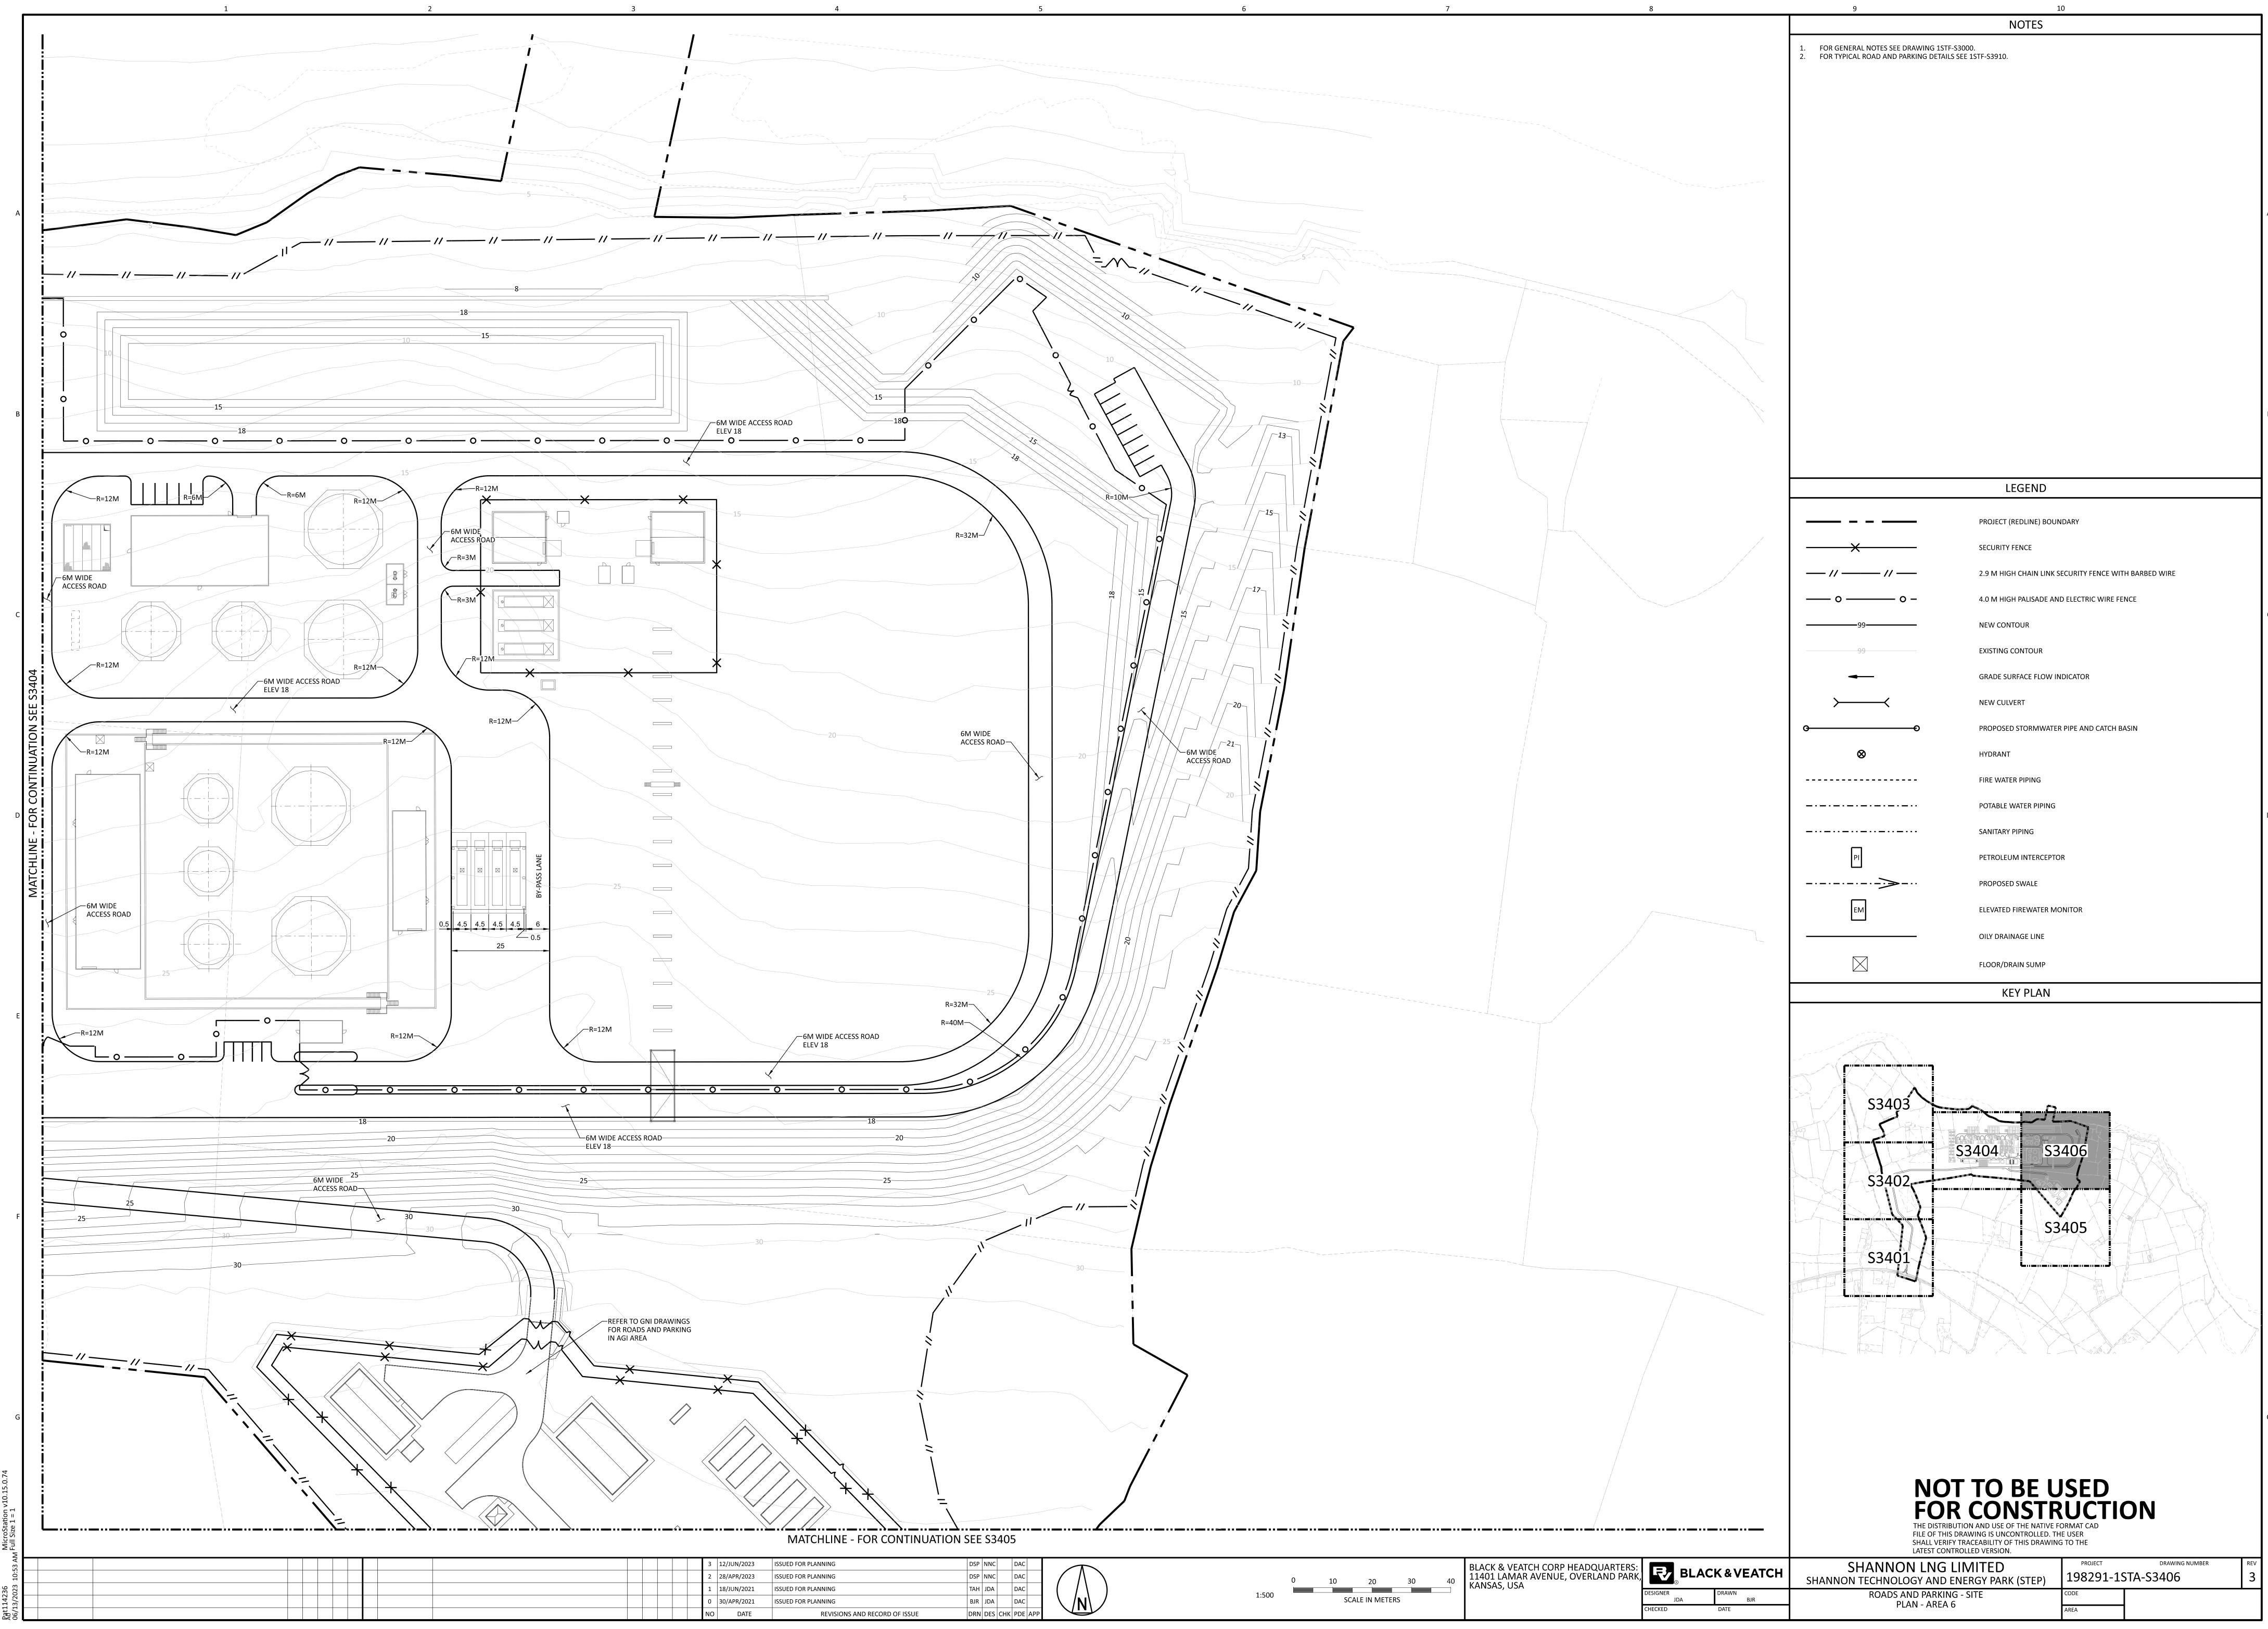
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SHANNON LNG LIMITED ANNON TECHNOLOGY AND ENERGY PARK (STEP)	PROJECT 198291-19	DRAWING NUMBER	<sup>REV</sup>
ROADS AND PARKING - SITE PLAN - AREA 3	CODE		

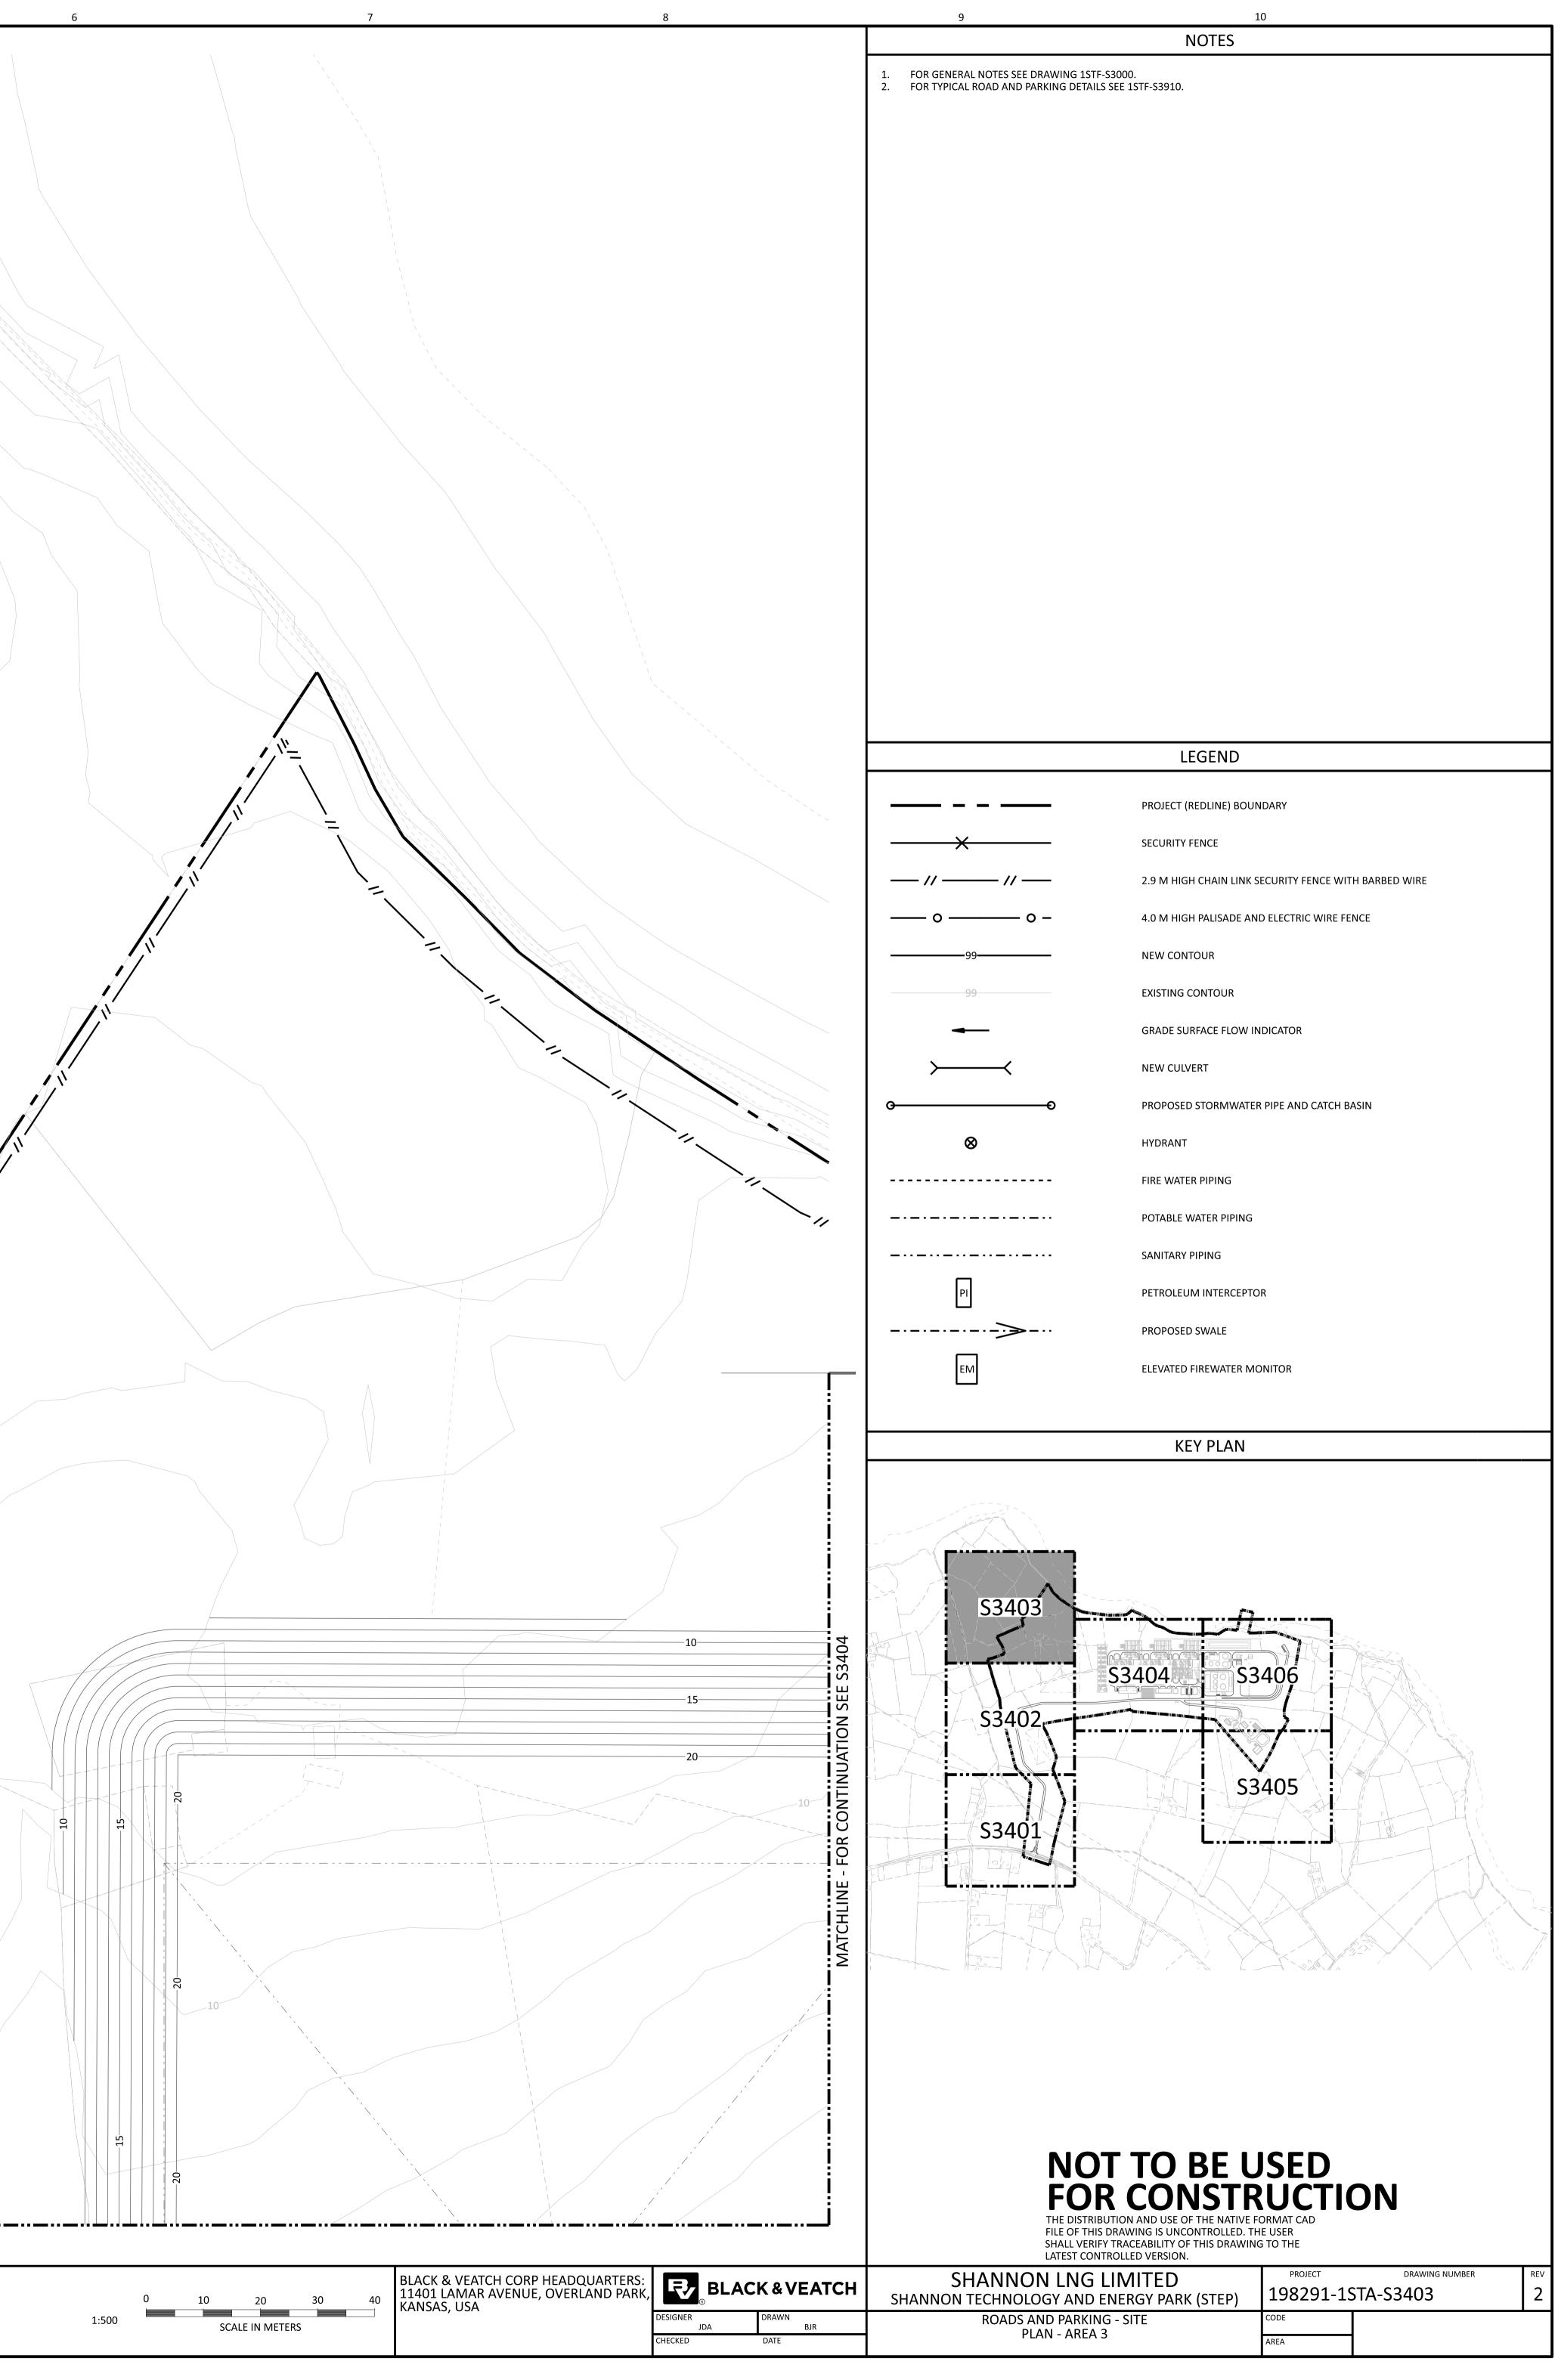

<b>NOT TO BE U</b> <b>FOR CONSTRUCTION</b> THE DISTRIBUTION AND USE OF THE NATIVE FOR FILE OF THIS DRAWING IS UNCONTROLLED. TH SHALL VERIFY TRACEABILITY OF THIS DRAWING LATEST CONTROLLED VERSION.	DRMAT CAD E USER	ON	
SHANNON LNG LIMITED ANNON TECHNOLOGY AND ENERGY PARK (STEP)	PROJECT 198291-15	drawing number STA-S3404	<sup>REV</sup>
ROADS AND PARKING - SITE PLAN - AREA 4	CODE		

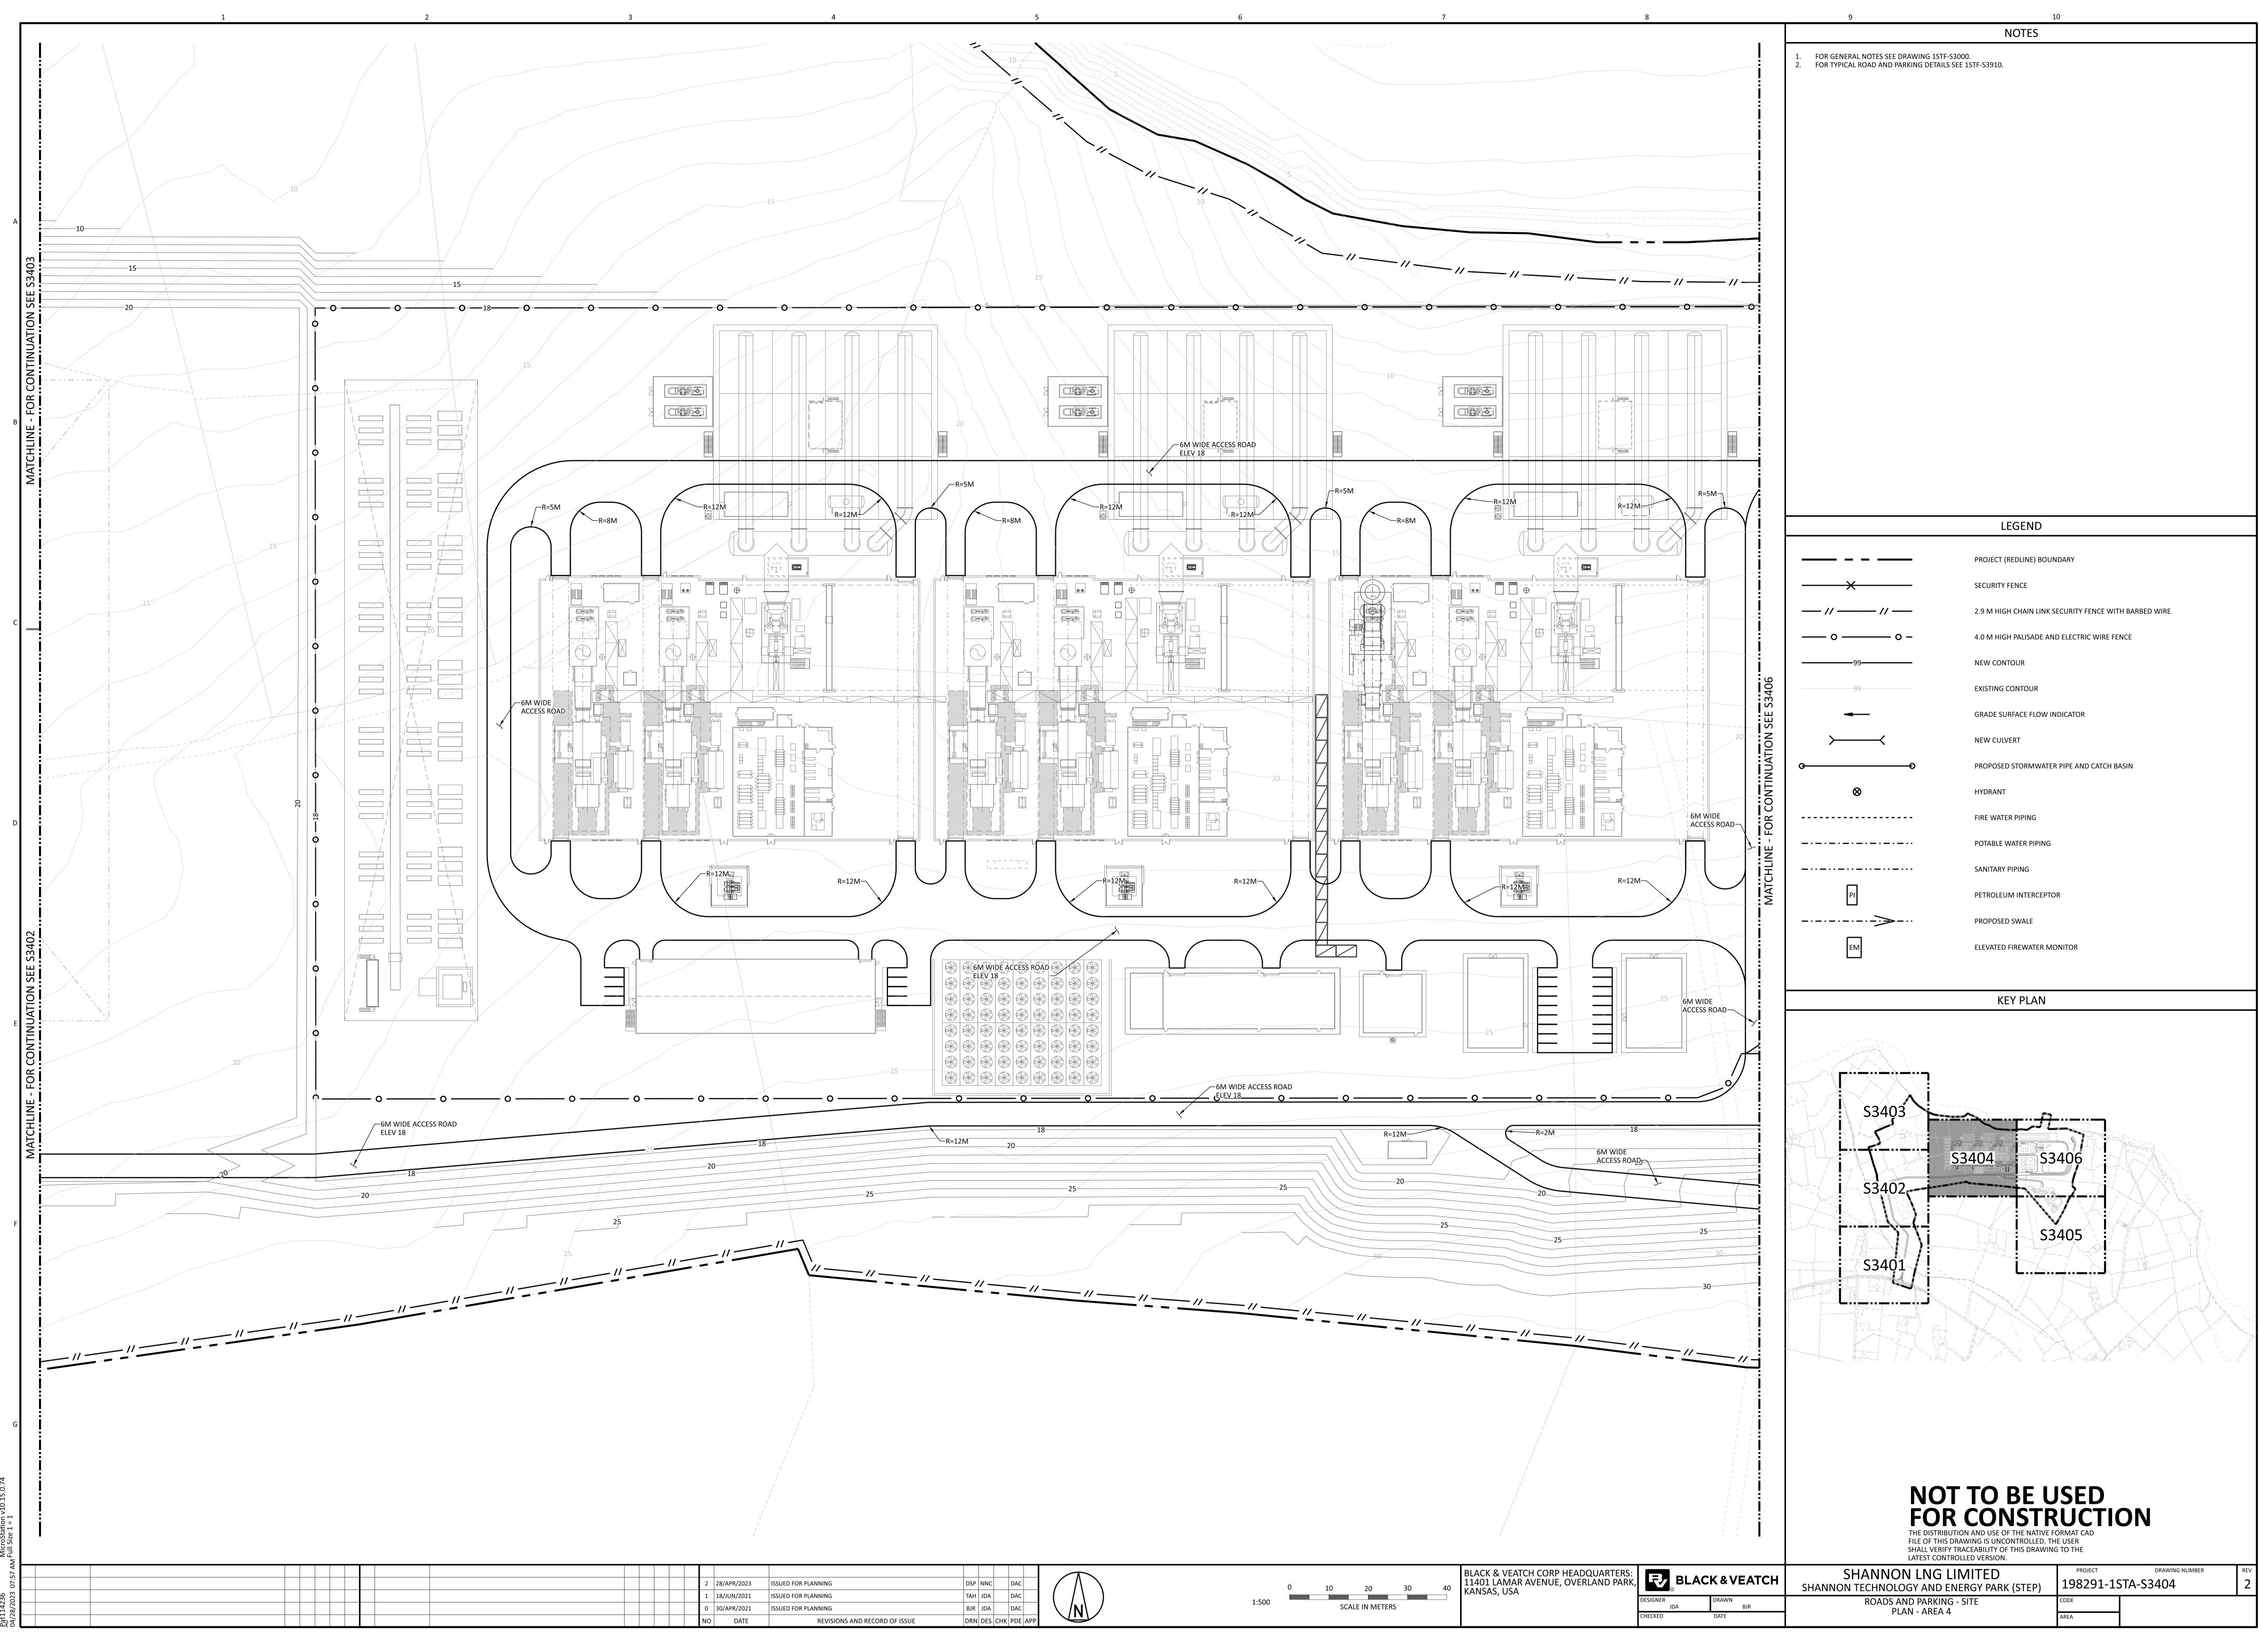

<b>NOT TO BE U</b> <b>FOR CONSTRUE</b> THE DISTRIBUTION AND USE OF THE NATIVE FOR FILE OF THIS DRAWING IS UNCONTROLLED. TH SHALL VERIFY TRACEABILITY OF THIS DRAWING LATEST CONTROLLED VERSION.	UCTIO DRMAT CAD E USER	ON	
SHANNON LNG LIMITED ANNON TECHNOLOGY AND ENERGY PARK (STEP)	PROJECT	drawing number STA-S3405	<sup>REV</sup>
ROADS AND PARKING - SITE PLAN - AREA 5	CODE		

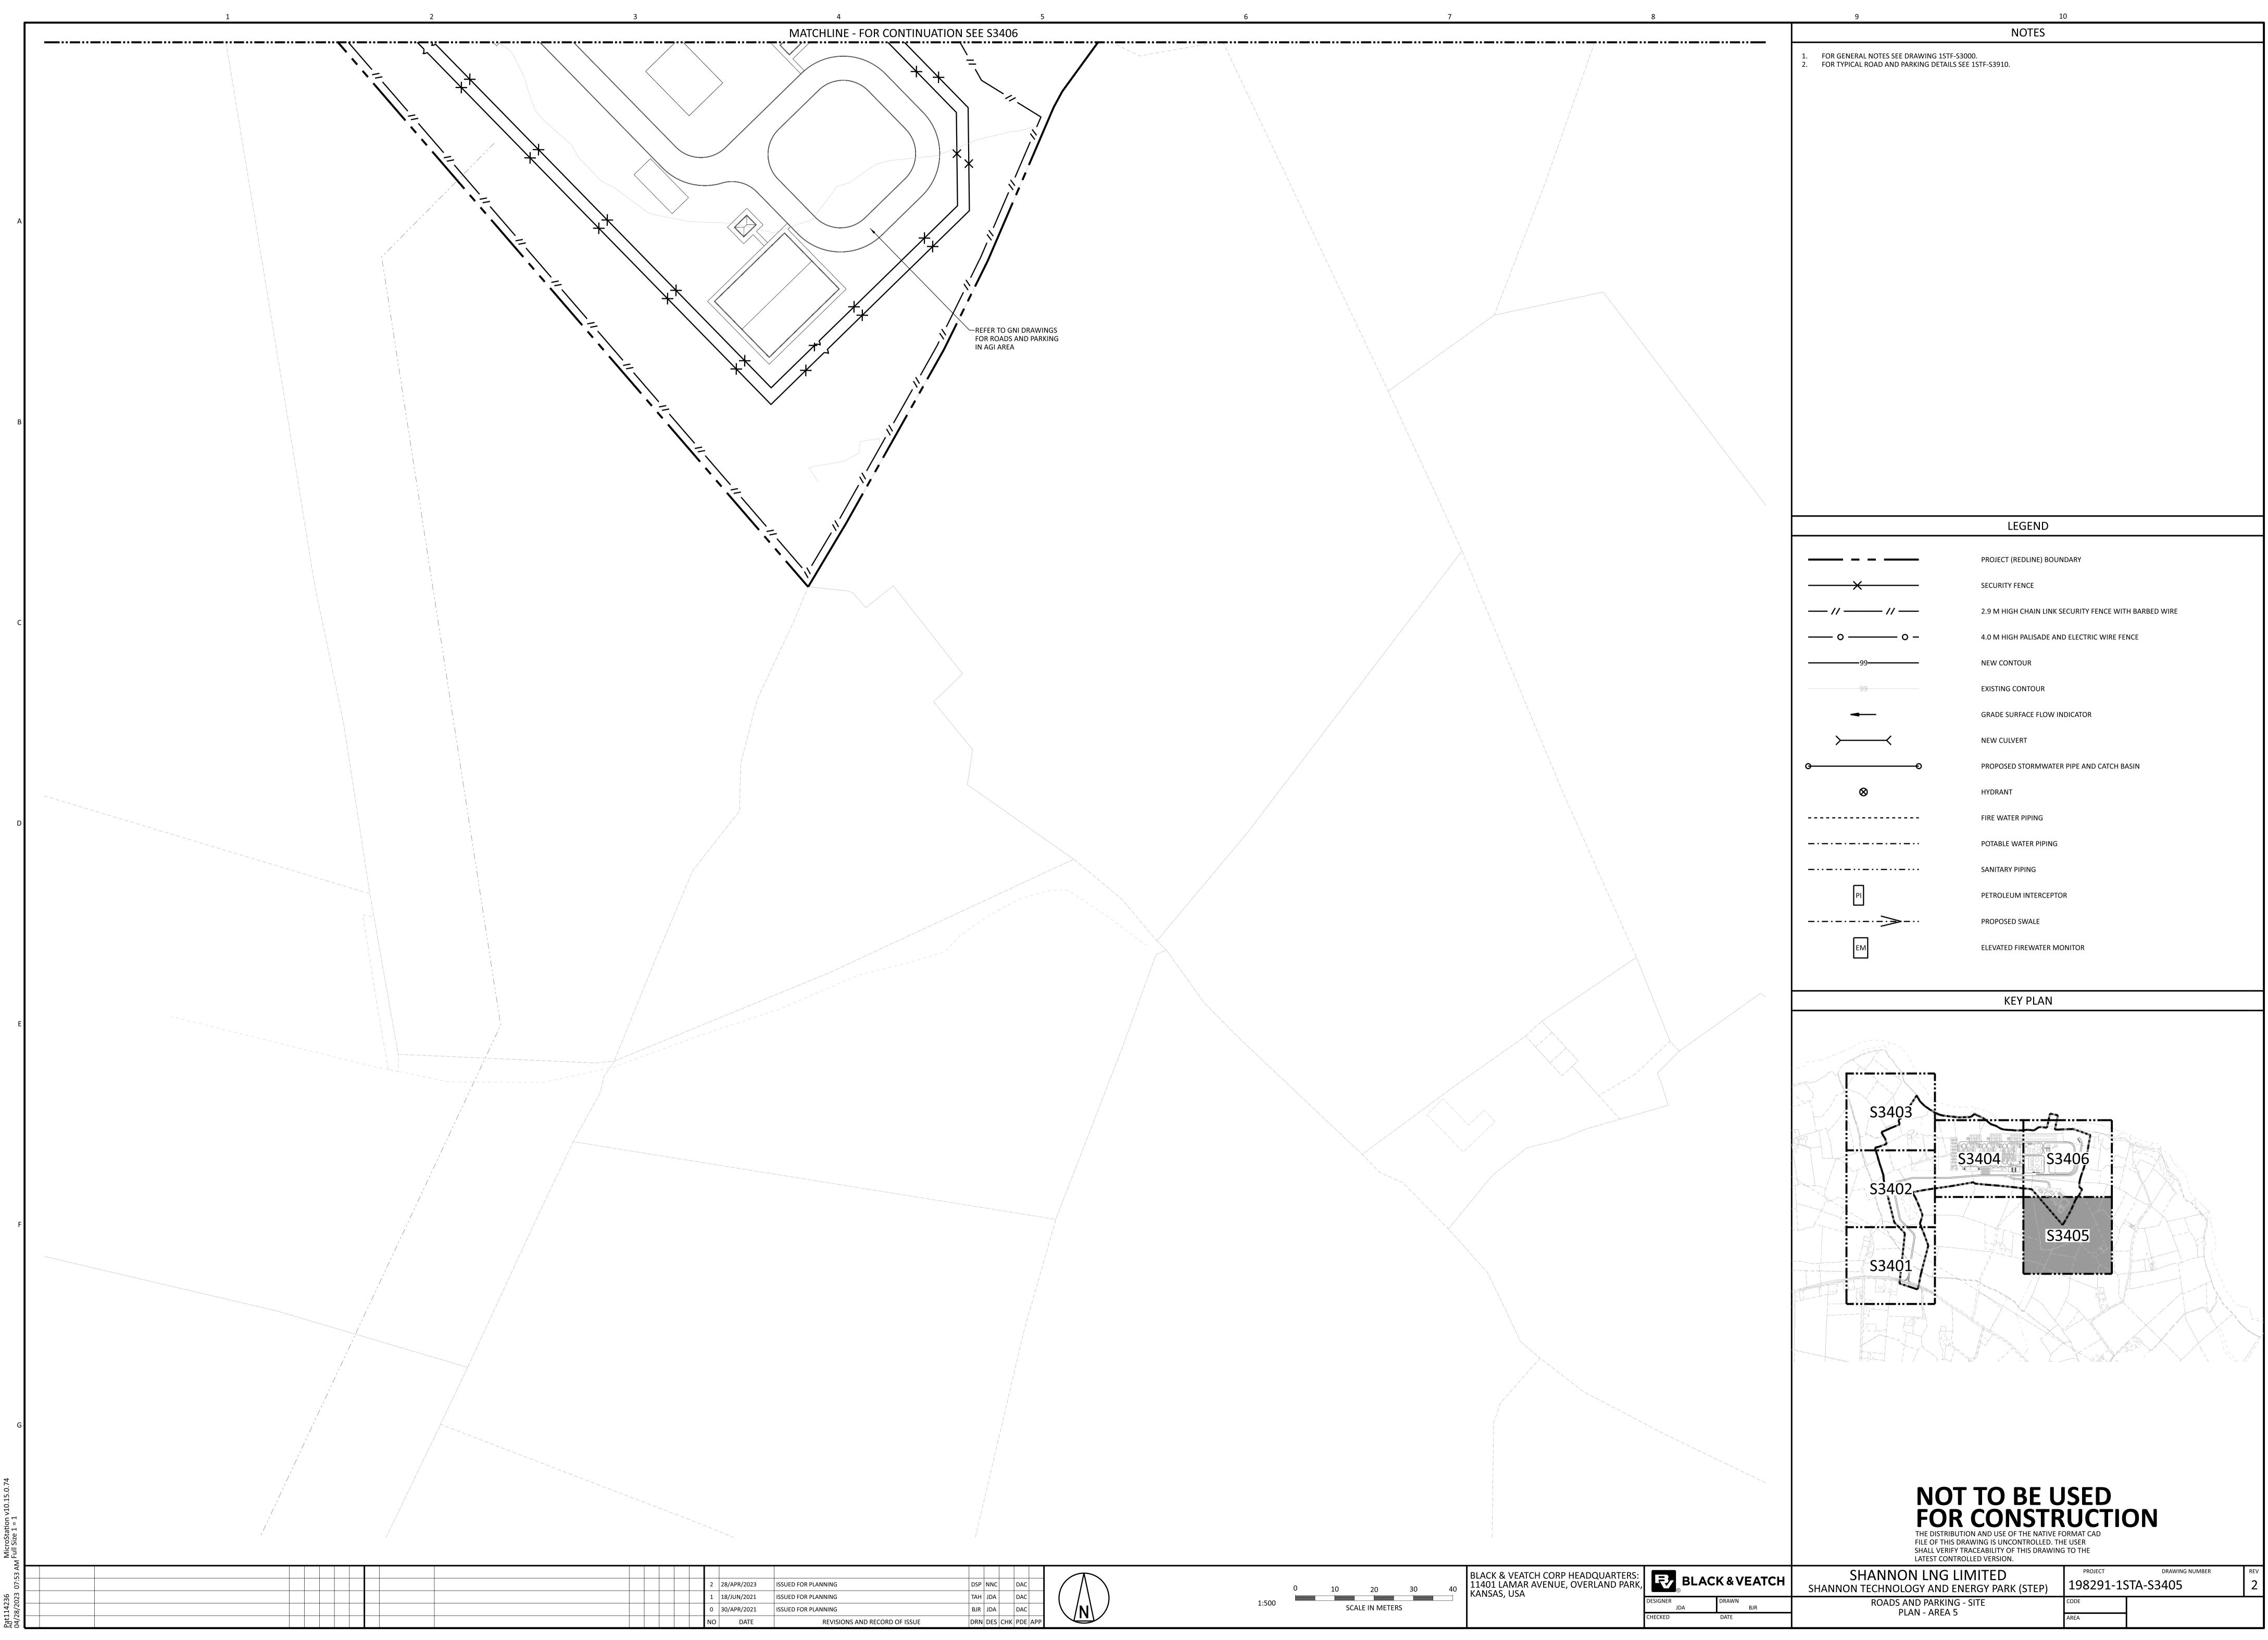


			3	12/JUN/2023	ISSUED FOR PLANNING	DSP	NNC		DAC	
			2	28/APR/2023	ISSUED FOR PLANNING	DSP	NNC		DAC	$( \land \land$
			1	18/JUN/2021	ISSUED FOR PLANNING	TAH	JDA		DAC	
			0	30/APR/2021	ISSUED FOR PLANNING	BJR	JDA		DAC	\ /N\ /
			NO	DATE	REVISIONS AND RECORD OF ISSUE	DRN	DES	снк	PDE APP	

THE DISTRIBUTION AND USE OF THE NATIVE FOR FILE OF THIS DRAWING IS UNCONTROLLED. TH SHALL VERIFY TRACEABILITY OF THIS DRAWING LATEST CONTROLLED VERSION.	DRMAT CAD E USER	JN	
NNON LNG LIMITED CHNOLOGY AND ENERGY PARK (STEP)	PROJECT 198291-19	DRAWING NUMBER	<sup>REV</sup>
OADS AND PARKING - SITE PLAN - AREA 6	CODE		

NOT TO BE USED
FOR CONSTRUCTION
THE DISTRIBUTION AND USE OF THE NATIVE FORMAT CAD

FLOOR/DRAIN SUMP	
KEY PLAN	

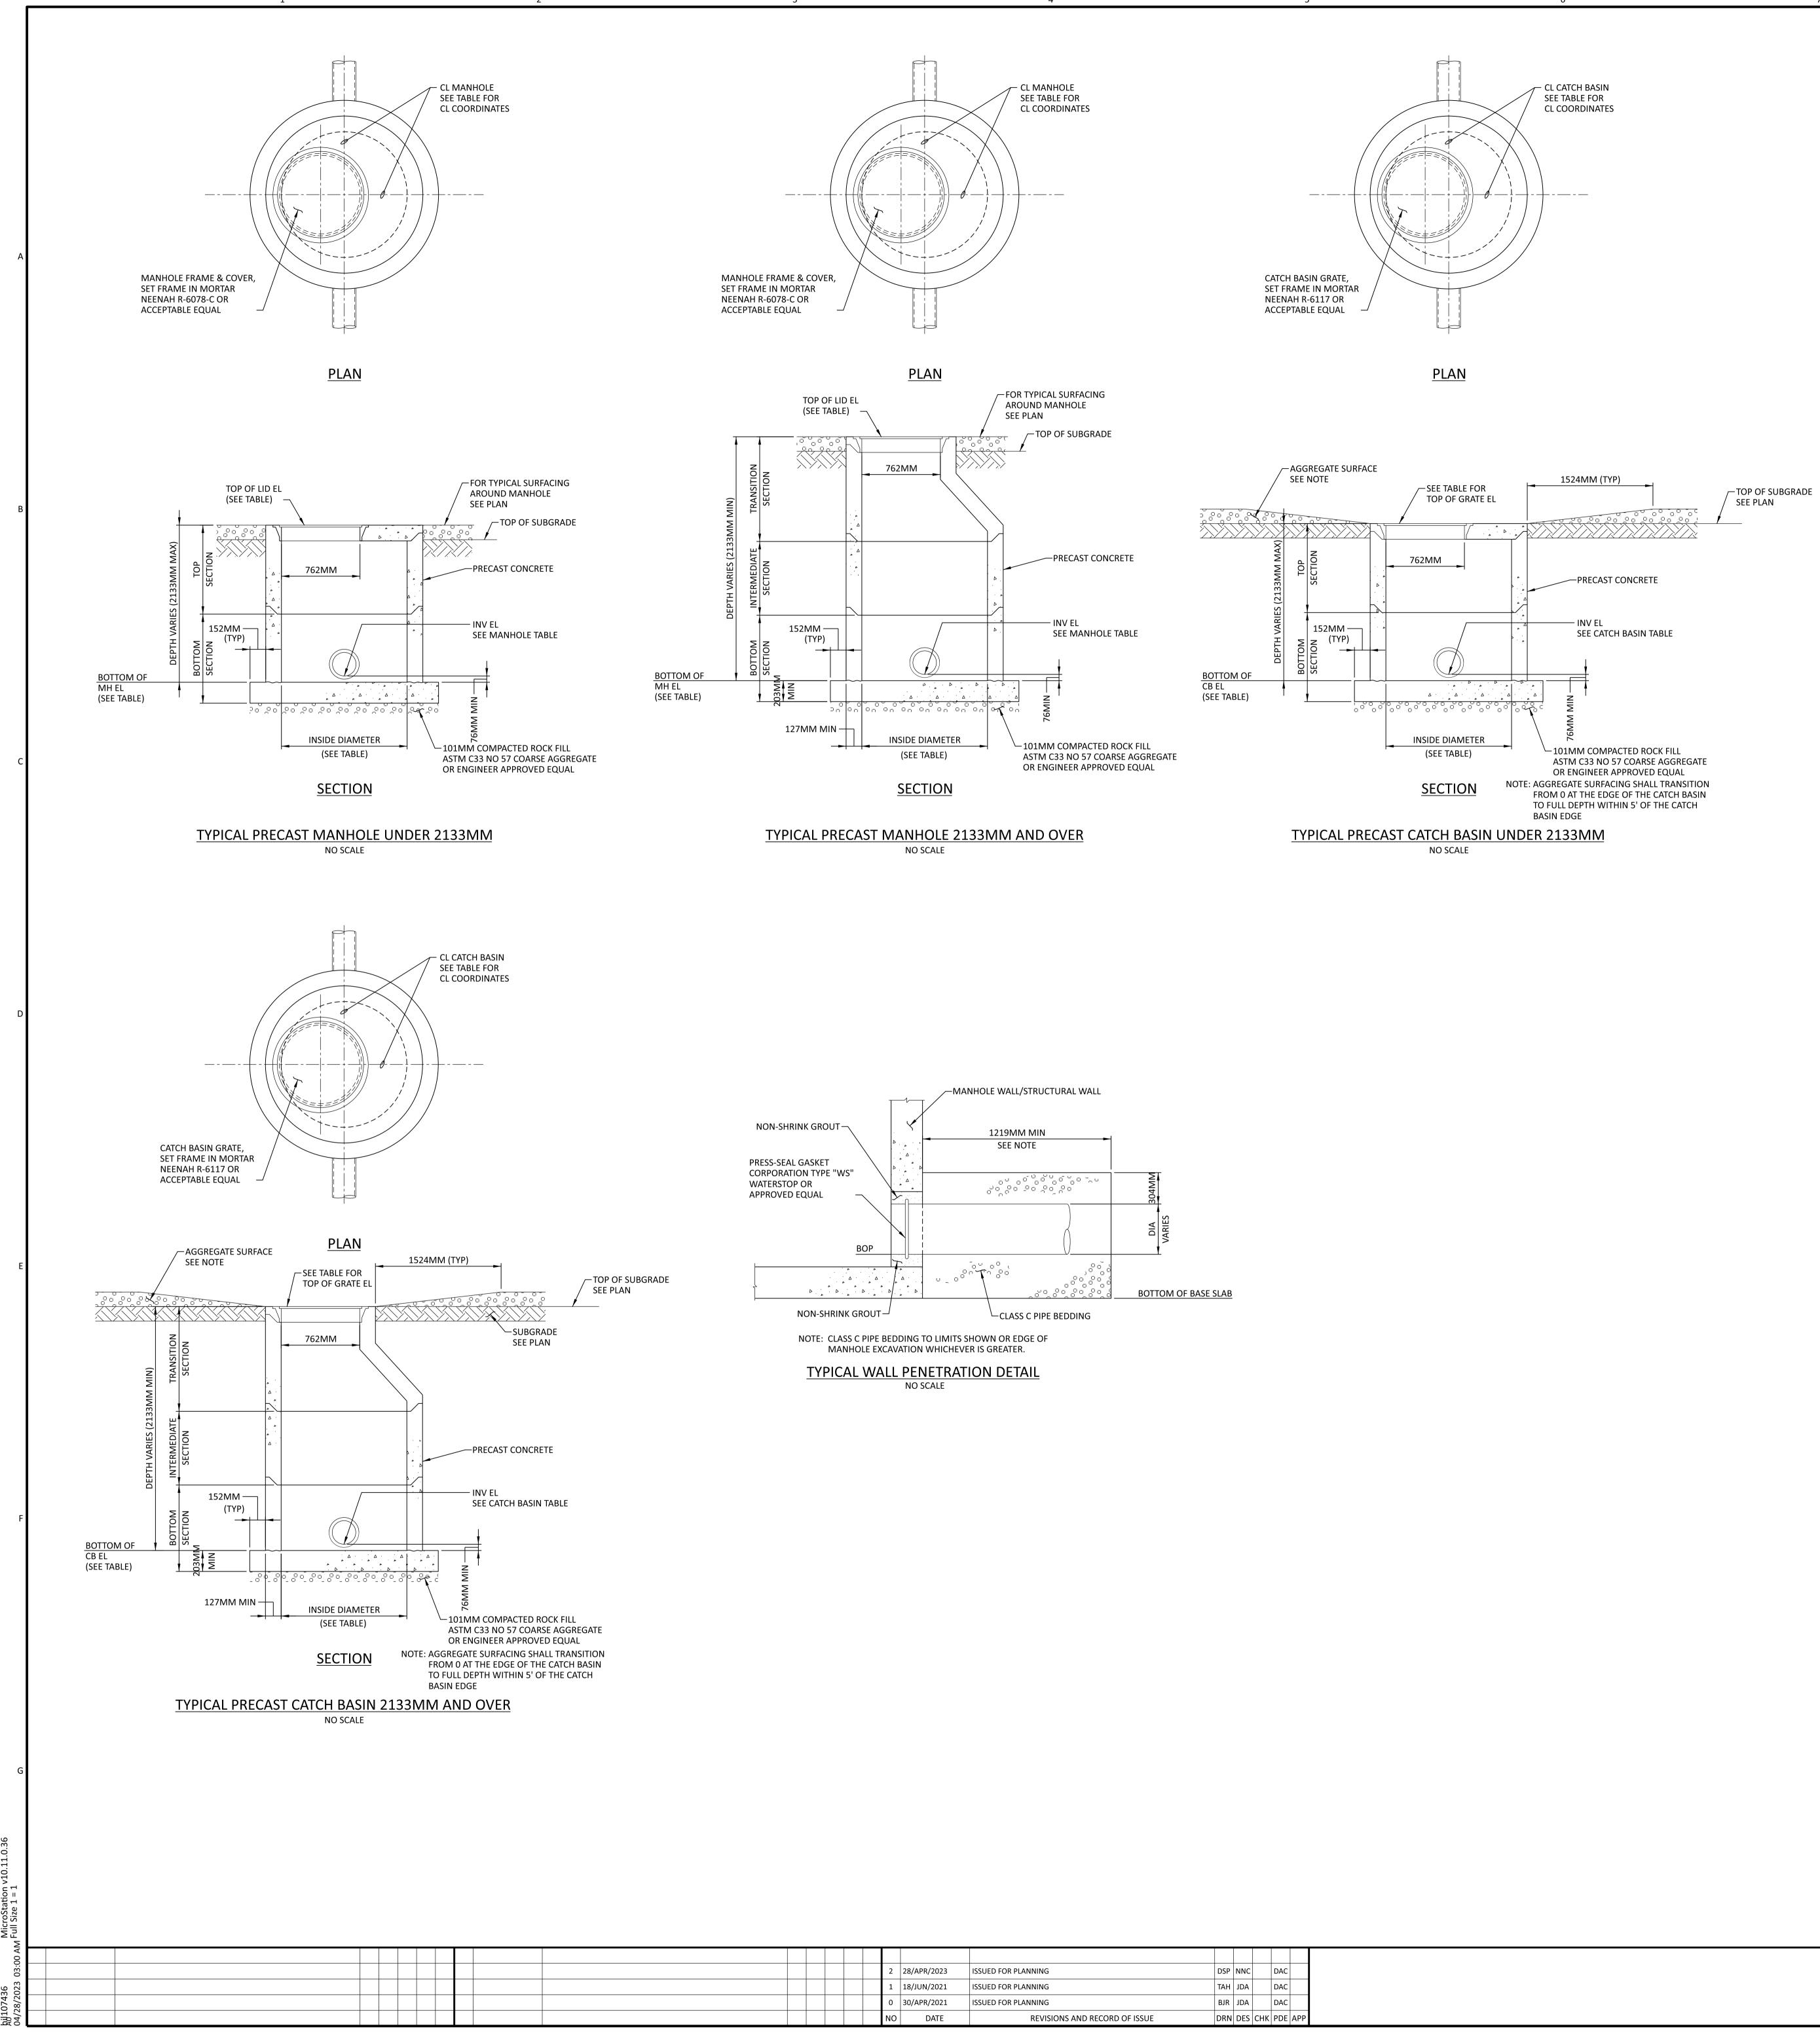


						LATEST CONTROLLED VERSION.			
				BLACK & VEATCH CORP HEADQUARTERS:	ACK & VEATCH	SHANNON LNG LIMITED	PROJECT		REV
	2 28/APR/2023	ISSUED FOR PLANNING	DSP NNC DAC	11401 LAMAR AVENUE, OVERLAND PARK,		SHANNON TECHNOLOGY AND ENERGY PARK (STEP)	198291-15	11-53900	2
	1 18/JUN/2021	ISSUED FOR PLANNING	AH JDA DAC	DESIGNER JDA	DRAWN BJR	GRADING AND DRAINAGE -SITE	CODE		
	0 30/APR/2021 NO DATE		BJR JDA DAC	CHECKED	DATE	TYPICAL MANHOLE AND CATCH BASIN DETAILS	AREA		

NOT <sup>-</sup>	ΤΟ ΒΕ Ι	JSED
FOR (	CONST	RUCTION

THE DISTRIBUTION AND USE OF THE NATIVE FORMAT CAD FILE OF THIS DRAWING IS UNCONTROLLED. THE USER SHALL VERIFY TRACEABILITY OF THIS DRAWING TO THE

## 1. SEE DRAWING S3000 FOR GENERAL NOTES AND LEGEND.

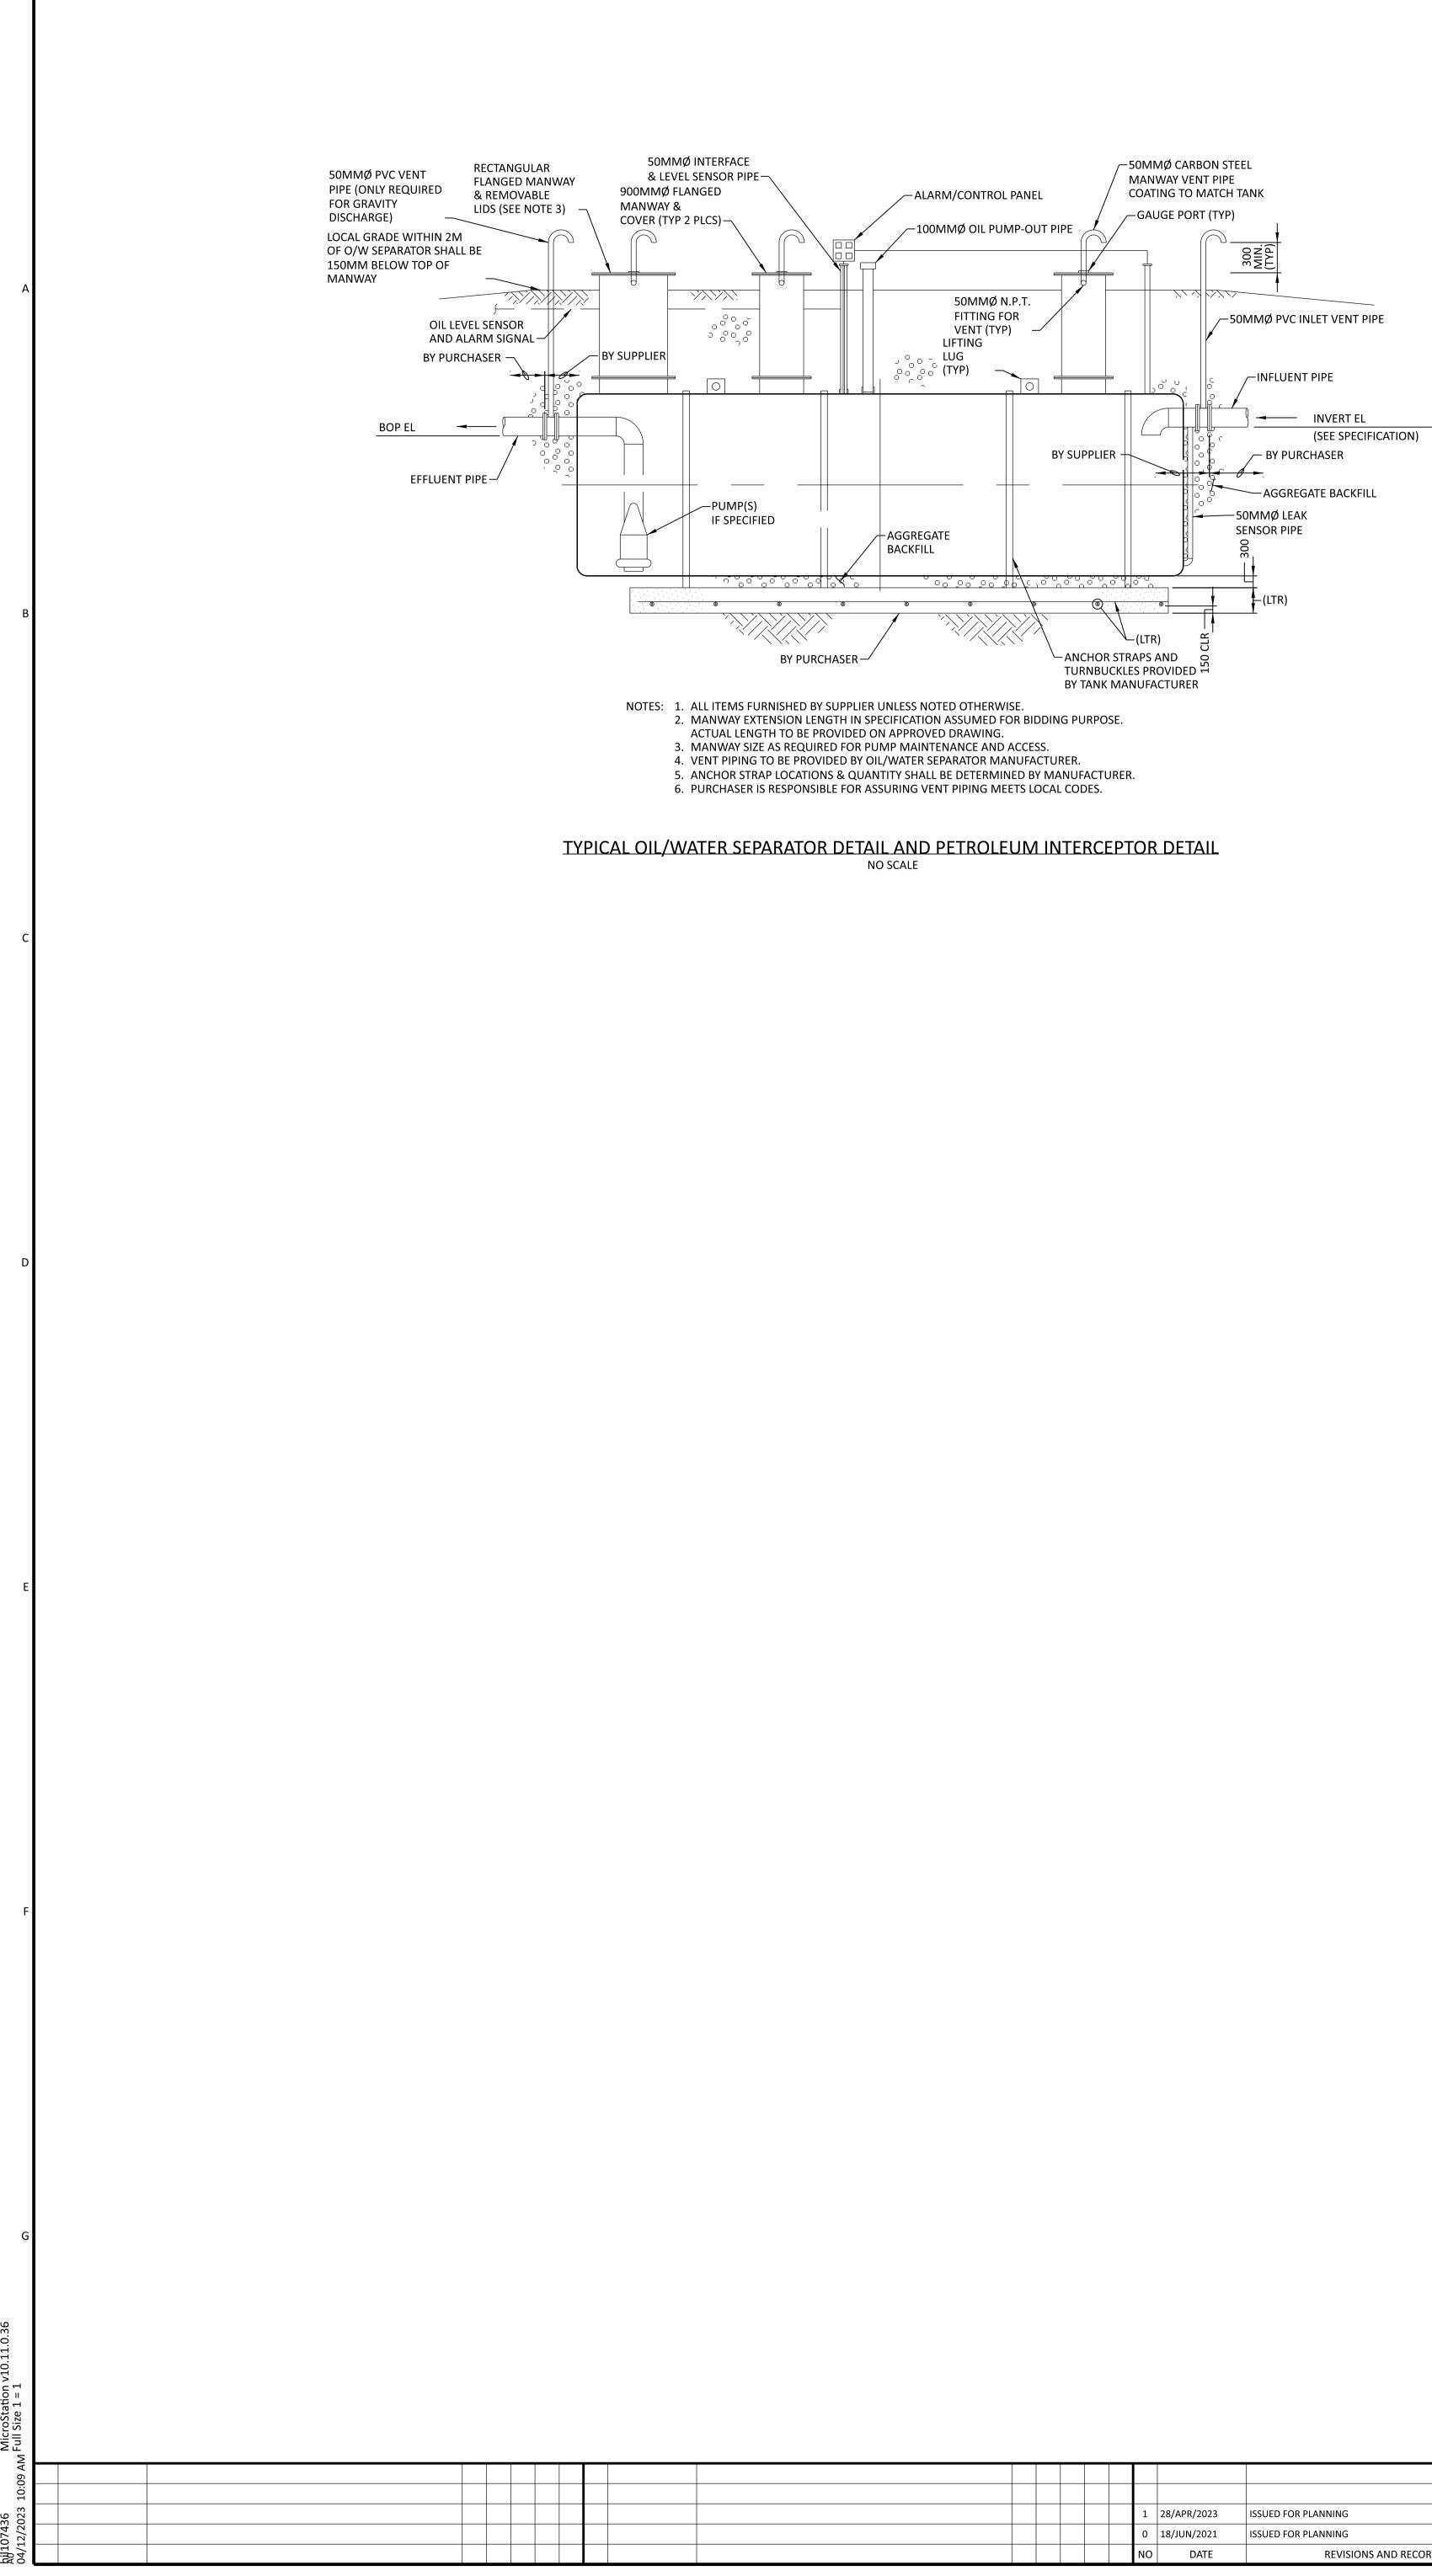

			1	28/APR/2023	ISSUED FOR PLANNING	DSP	NNC		DAC	
			0	18/JUN/2021	ISSUED FOR PLANNING	JRH	JDA		DAC	
			NO	DATE	REVISIONS AND RECORD OF ISSUE	DRN	DES	СНК	PDE	APP

CK & VEATCH CORP HEADQUARTERS: D1 LAMAR AVENUE, OVERLAND PARK, SAS, USA	BLACK	&VEATCH	SHANNON LNG LIMITED SHANNON TECHNOLOGY AND ENERGY PARK (STEP)	PROJECT 198291-15	DRAWING NUMBER	<sup>REV</sup>
DESIGNER	NER DR JDA	RAWN JRH	GRADING AND DRAINAGE - SITE TYPICAL OIL WATER SEPARATOR DETAIL	CODE		
CHECKED	ED DA	ATE	ITFICAL OIL WATER SEPARATOR DETAIL	AREA		

# NOT TO BE USED FOR CONSTRUCTION THE DISTRIBUTION AND USE OF THE NATIVE FORMAT CAD






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						1	18/JUN/2021	ISSUED FOR PLANNING	TAH	JDA		DAC	
						0	30/APR/2021	ISSUED FOR PLANNING	BJR	JDA		DAC	
NO     DATE     REVISIONS AND RECORD OF ISSUE     DRN     DES     CHK     PDE     APP						NO	DATE	REVISIONS AND RECORD OF ISSUE	DRN	DES	СНК	PDE	APP

BLACK & VEATCH CORP HEADQUARTERS 11401 LAMAR AVENUE, OVERLAND PAR KANSAS, USA		SHANNON LNG LIMITED SHANNON TECHNOLOGY AND ENERGY PARK (STEP)	PROJECTDRAWING NUMBERRE198291-1STA-S39102	:∨ 2
	DESIGNER DRAWN JDA BJR CHECKED DATE	ROADS AND PARKING - SITE TYPICAL ROADS AND PARKING DETAILS	CODE	





PRECAST CONCRETE BRIDGE TYPICAL DETAIL NO SCALE

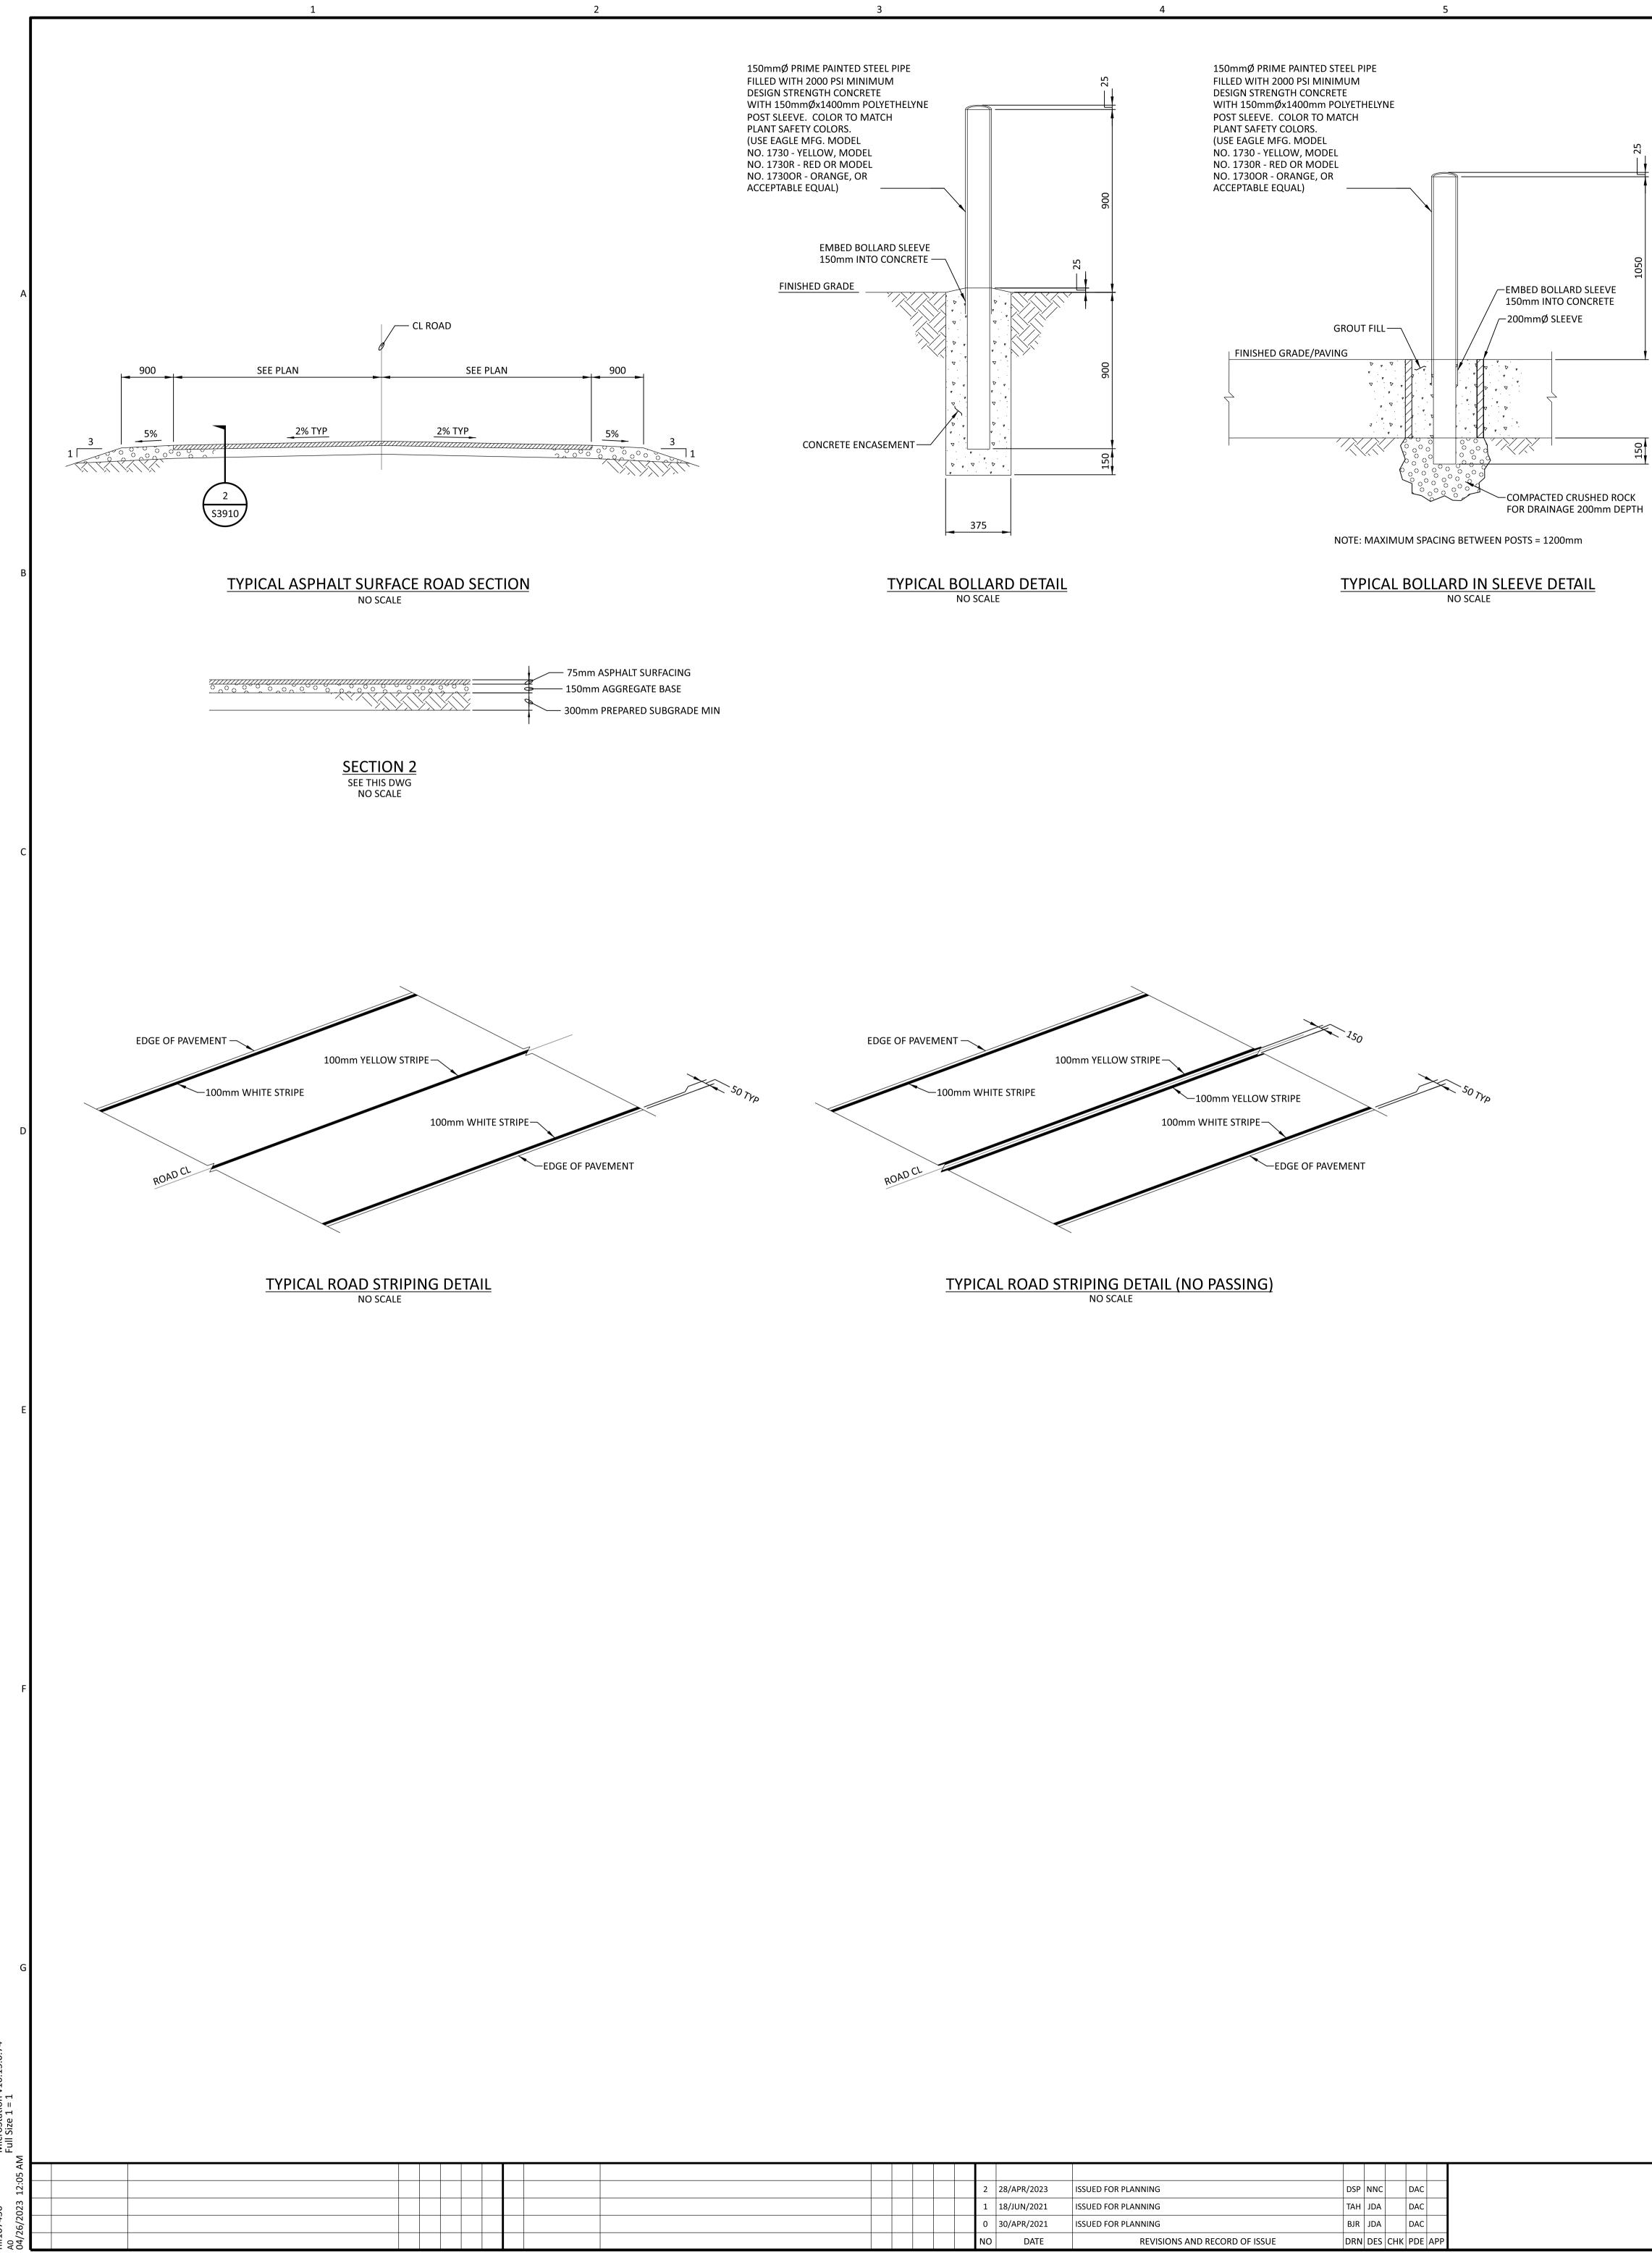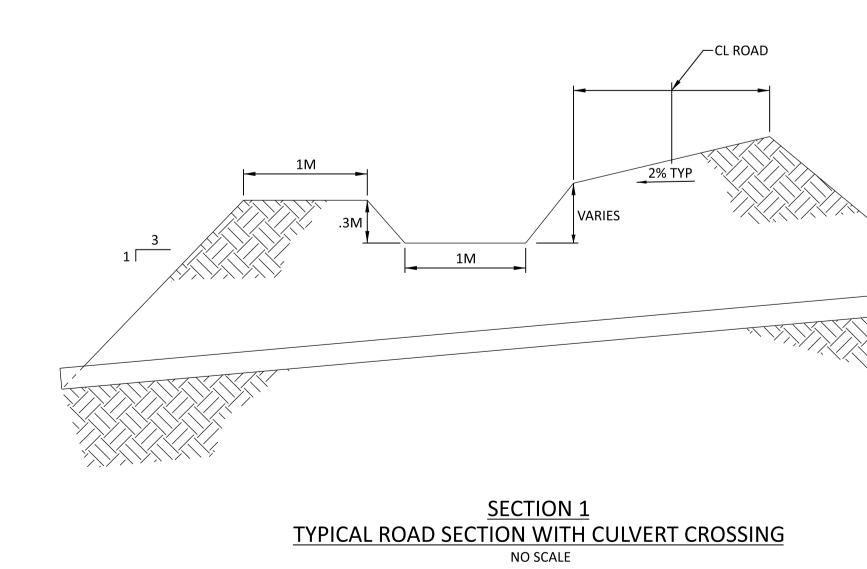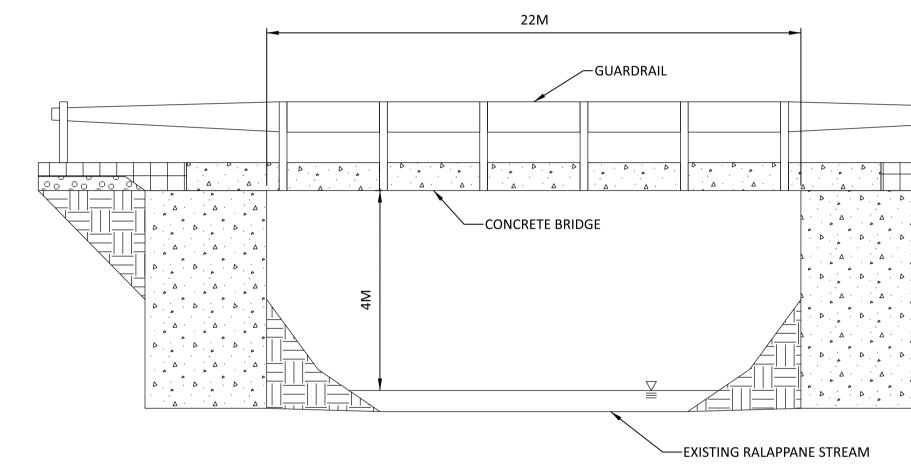


CONCRETE PARKING BUMPER DETAIL NO SCALE

NOTE: CENTER PARKING BUMPER IN PARKING SPACE UNO.

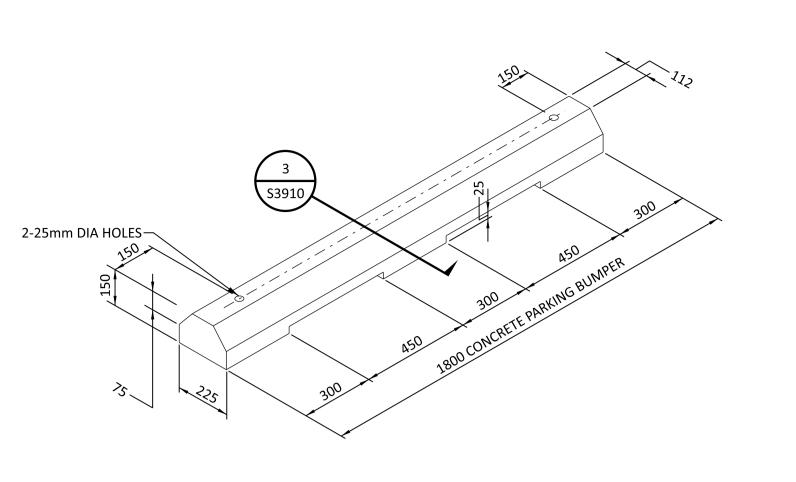


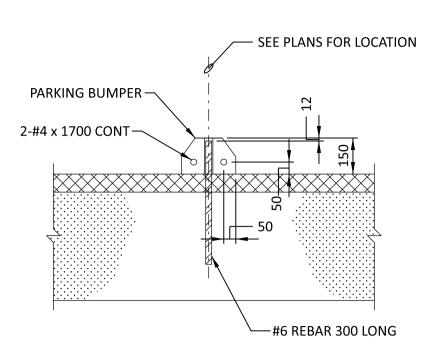

SECTION 3 SEE THIS DWG NO SCALE

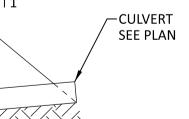

## NOT TO BE USED FOR CONSTRUCTION THE DISTRIBUTION AND USE OF THE NATIVE FORMAT CA

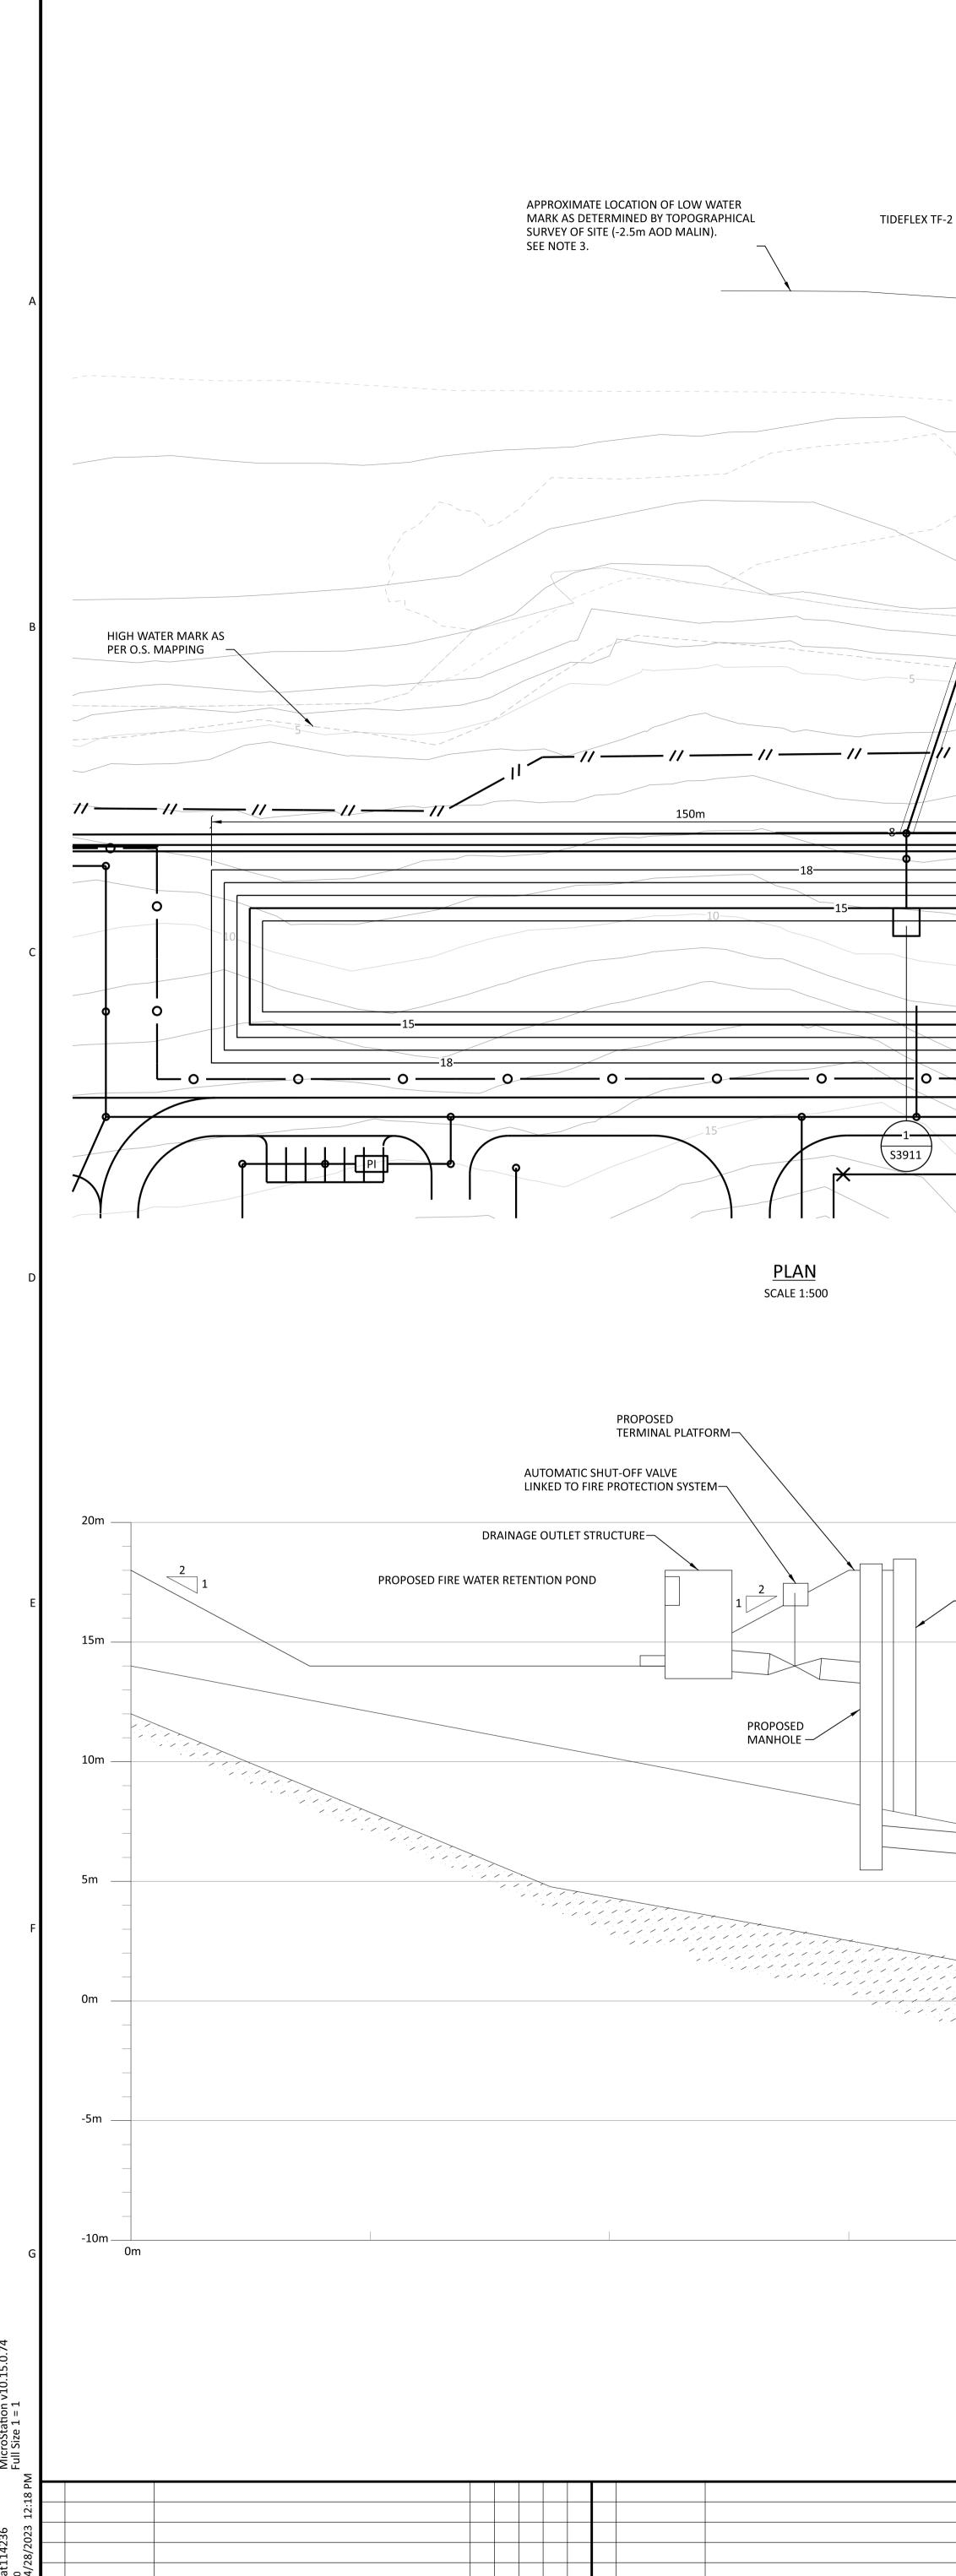


(TF-2 OR SIMILAR	PROPOSED EDGE OF TRENCH EXCAVATION: SIDES OF TRENCH SLOPED BACK TO PREVENT SILTATION	BOTTOM AND SII PREDIMINANTLY
	N 148936 E 102554 PROPOSED EDGE OF EXCAVATED TRENCH	PR OL
	ROPOSED 900MMØ CONCRETE UTFALL PIPE HIGH WATER MARK AS PER O.S. MAPPING 5 11 - 11 - 11 - 11 - 11	BOTTOM AN PREDIMINAL
7 ×	× 15	


-PROPOSED RETAINING WALL MEAN HIGH WATER SPRINGS TOP OF CLIFF/EDGE OF GRASS MARK (+2.0m AOD). (+4.5m AOD) -PROPOSED MANHOLE EXISTING GROUND LEVEL APPROXIMATE LOCATION OF BOTTOM OF PROPOSED TRENCH FOR OUTFALL PIPE PROPOSED 900mmø CONCRETE OUTFALL PIPE

### FALL OF OUTFALL PIPE DETERMINED BY FORESHORE TOPOGRAPHY AND NOT TO BE LESS THAN 1/200

50m SECTION 1 SCALE 1:200

									0	1	2	3
								1:50				
	1	28/APR/2023	ISSUED FOR PLANNING	DSP	NNC		DAC		0	SCA 2	LE IN METERS	6
	0	13/AUG/2021	ISSUED FOR PLANNING	ОГИ	JDA		DAC	1:100				
	NO	DATE	REVISIONS AND RECORD OF ISSUE	DRN	DES	СНК	PDE APP	•		SCA	LE IN METERS	

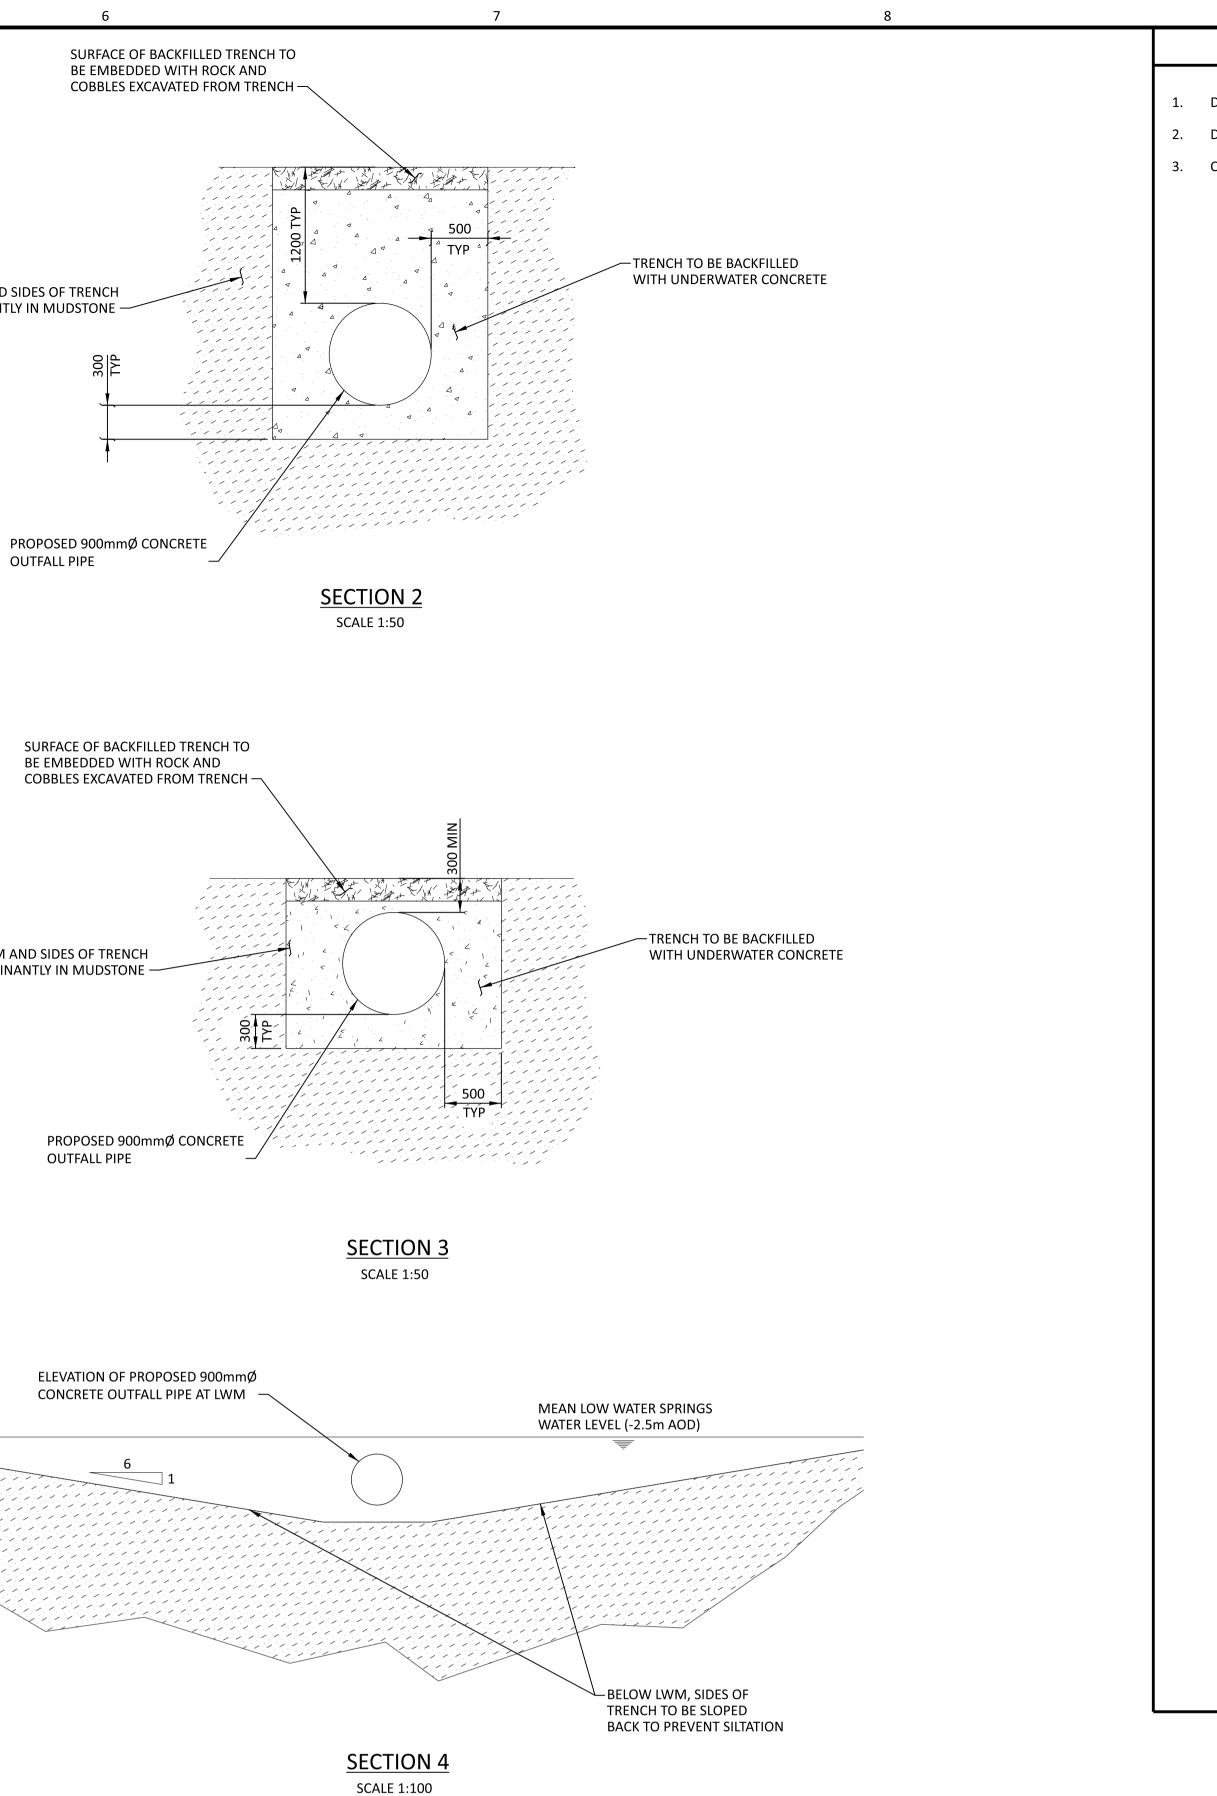

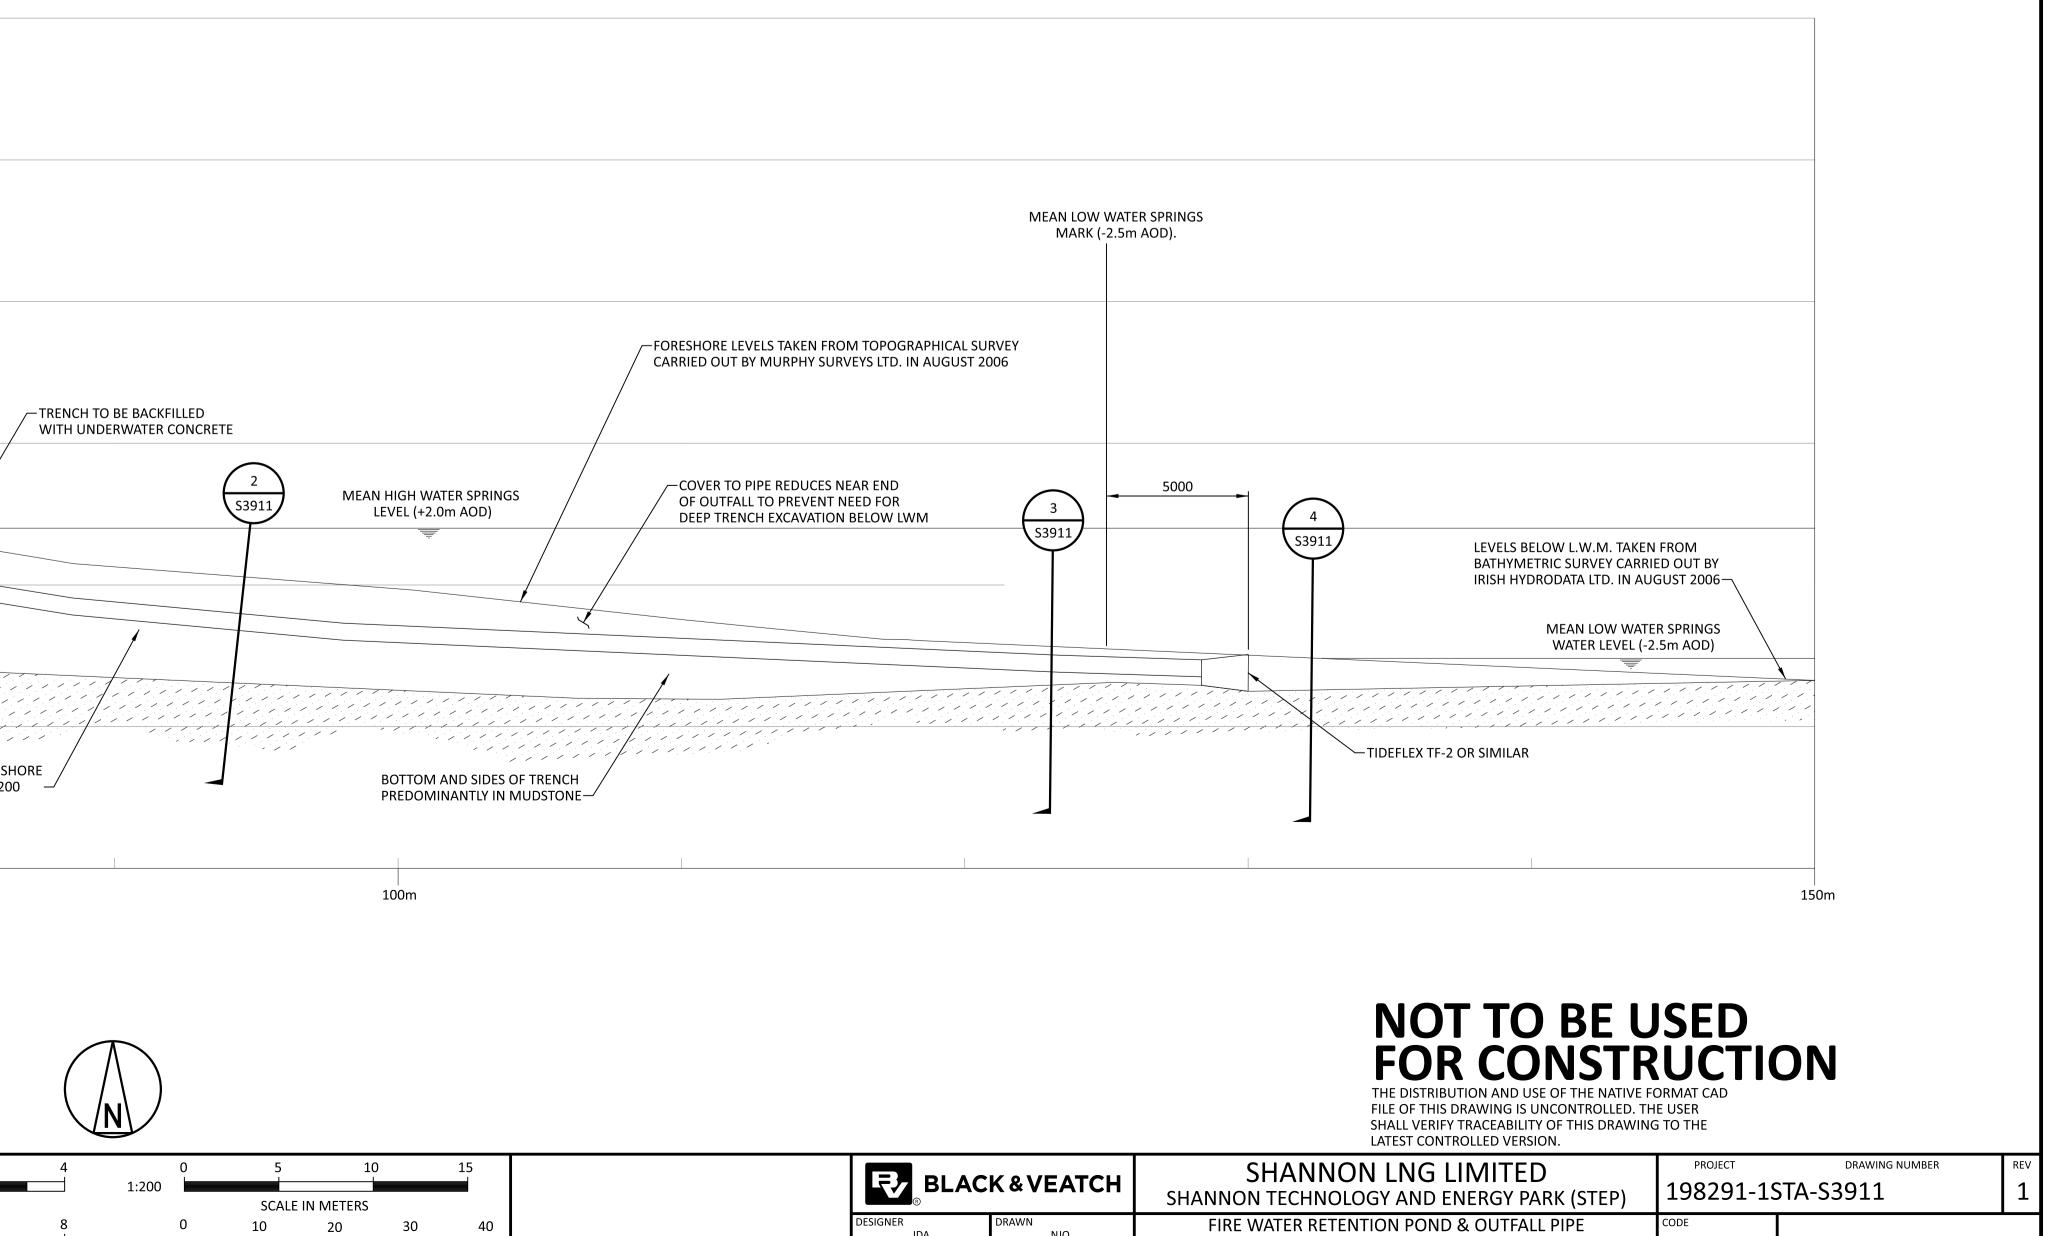


PLAN, SECTION & DETAILS

10 20 30 40 OLM IDA 1:500 DATE SCALE IN METERS

1. DO NOT SCALE, USE FIGURED DIMENSIONS ONLY.


2. DRAWINGS FOR PLANNING PURPOSES ONLY, NOT FOR BID OR CONSTRUCTION.


3. CO-ORDINATES SHOWN ARE TO IRISH NATIONAL GRID IN METRES.

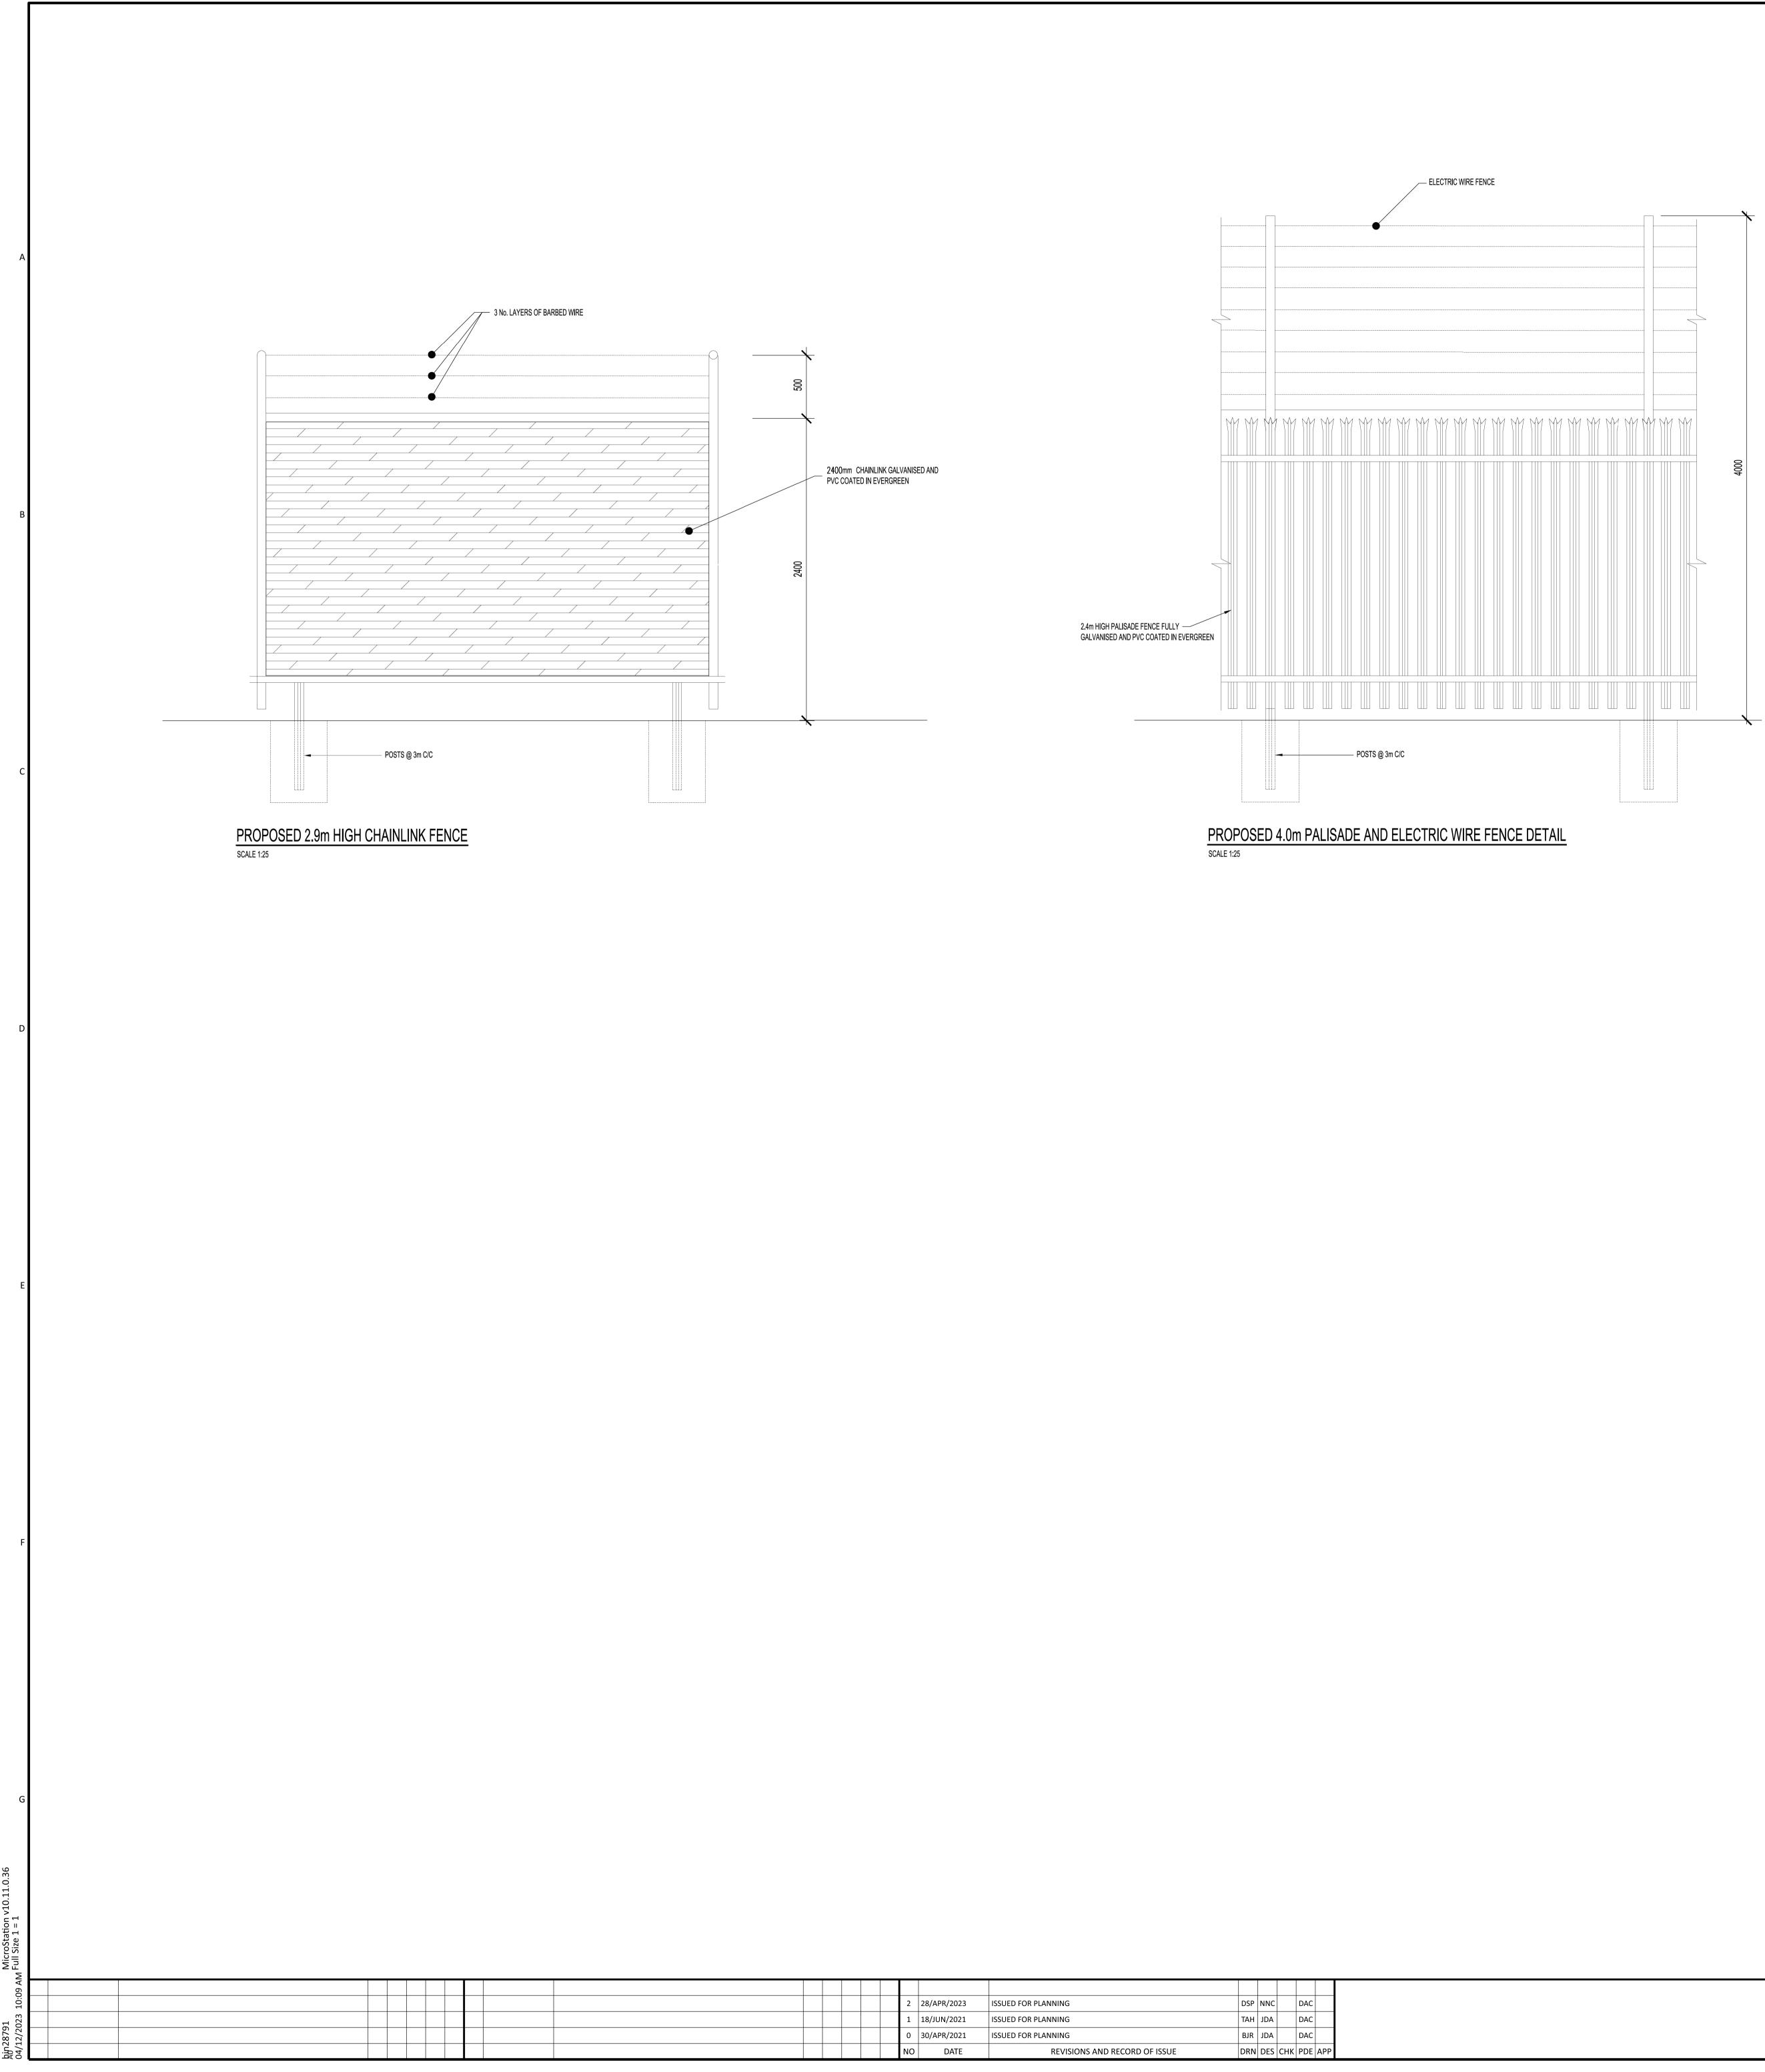

								EATEST CONTROLLED VERSION.		
					BLACK & VEATCH CORP HEADOUARTERS			SHANNON LNG LIMITED	PROJECT	DRAWING N
	2 28/APR/2023	ISSUED FOR PLANNING	DSP NNC	DAC	11401 LAMAR AVENUE, OVERLAND PARK	ζ, <b>Γ</b> ΖΖ BL	ACK & VEATCH	SHANNON TECHNOLOGY AND ENERGY PARK (STEP)	198291-19	STD-S3915
	1 18/JUN/2021	ISSUED FOR PLANNING	TAH JDA	DAC	KANSAS, USA	DESIGNER	DRAWN	TYPICAL FENCING DETAILS	CODE	1
	0 30/APR/2021	ISSUED FOR PLANNING	BJR JDA	DAC		JDA	BJR	TIFICALI ENCING DETAILS		
	NO DATE	REVISIONS AND RECORD OF ISSUE	DRN DES CH	K PDE APP		CHECKED	DATE		AREA	

## NOT TO BE USED FOR CONSTRUCTION THE DISTRIBUTION AND USE OF THE NATIVE FORMAT CAD

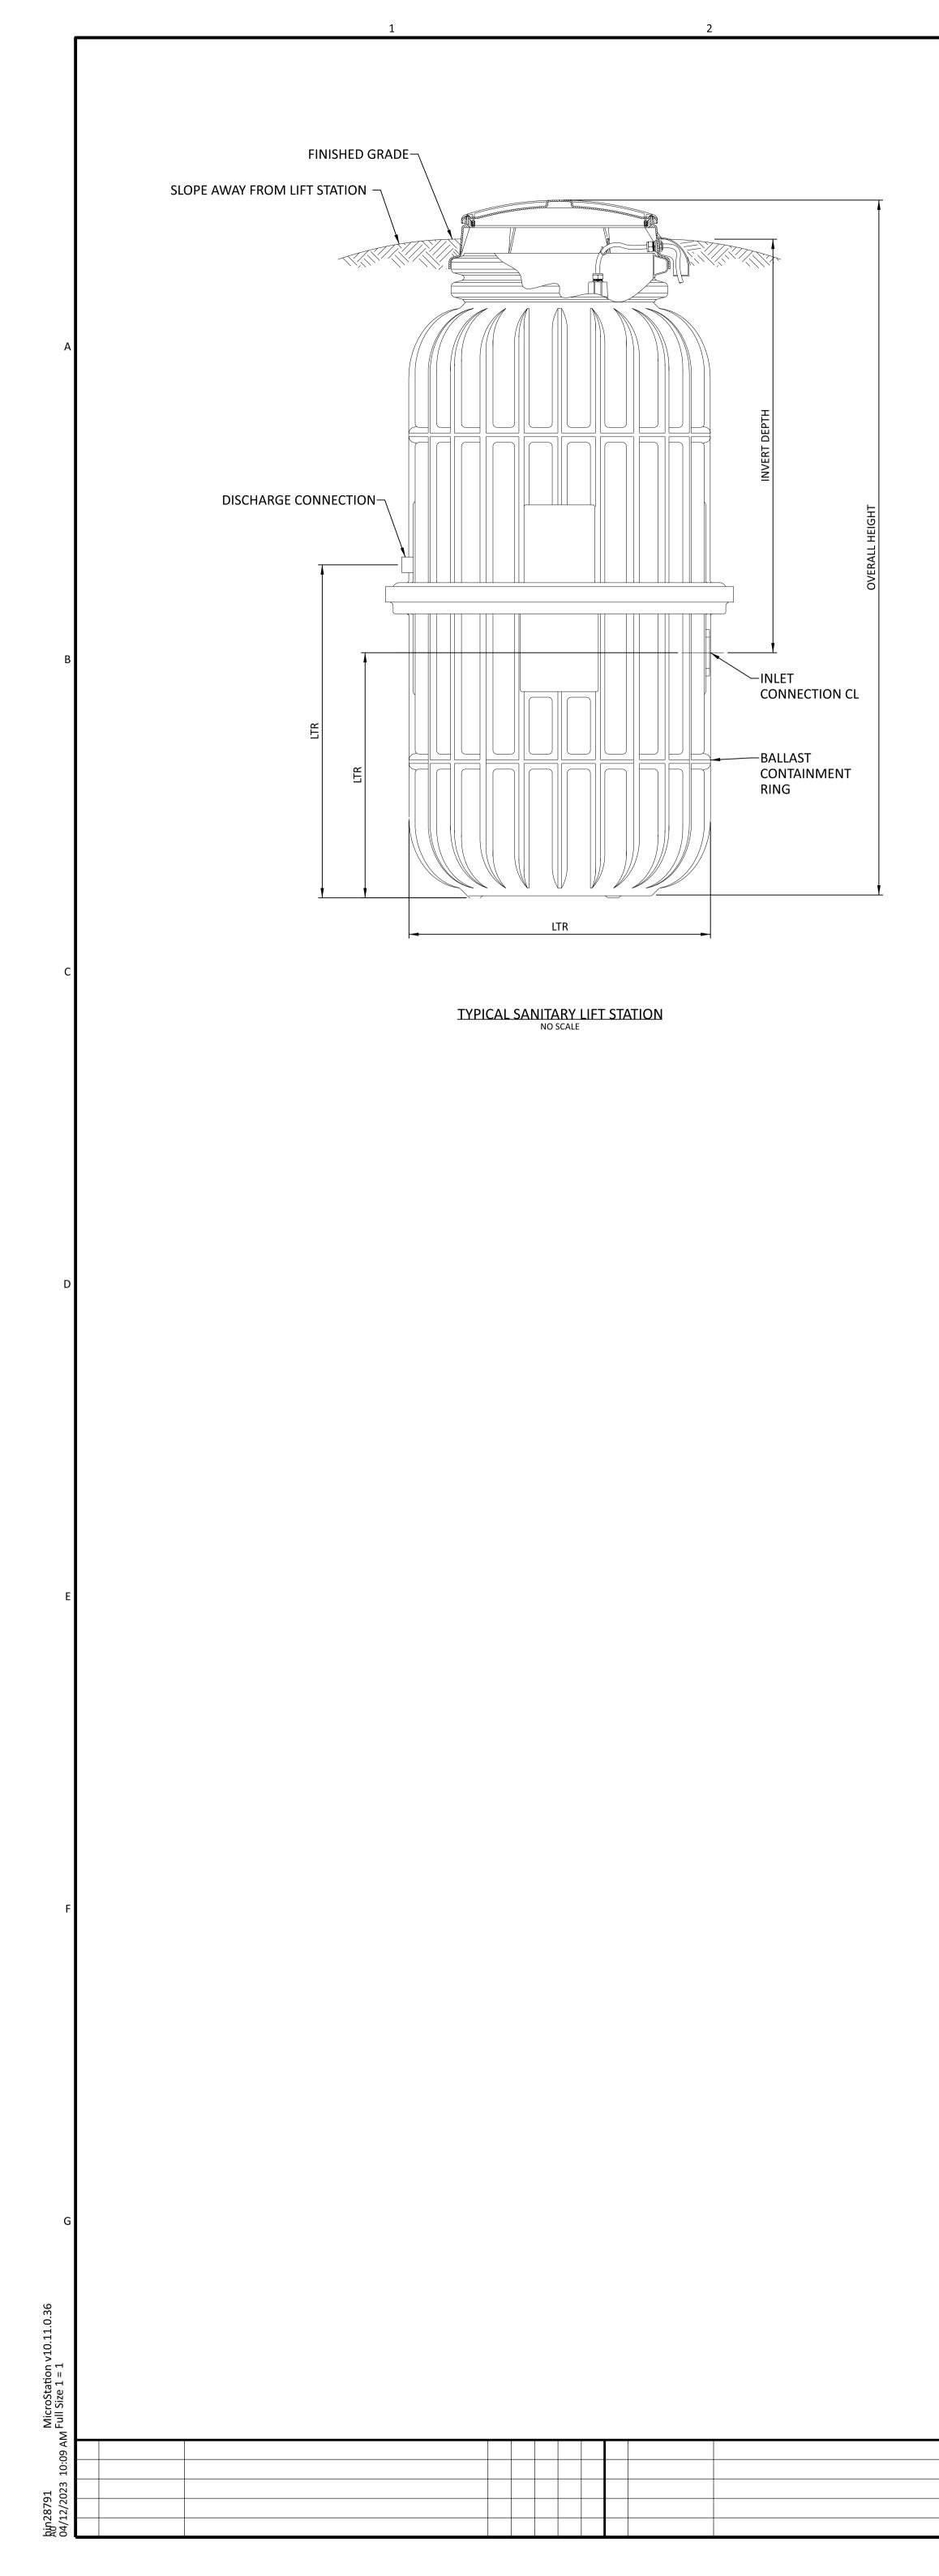

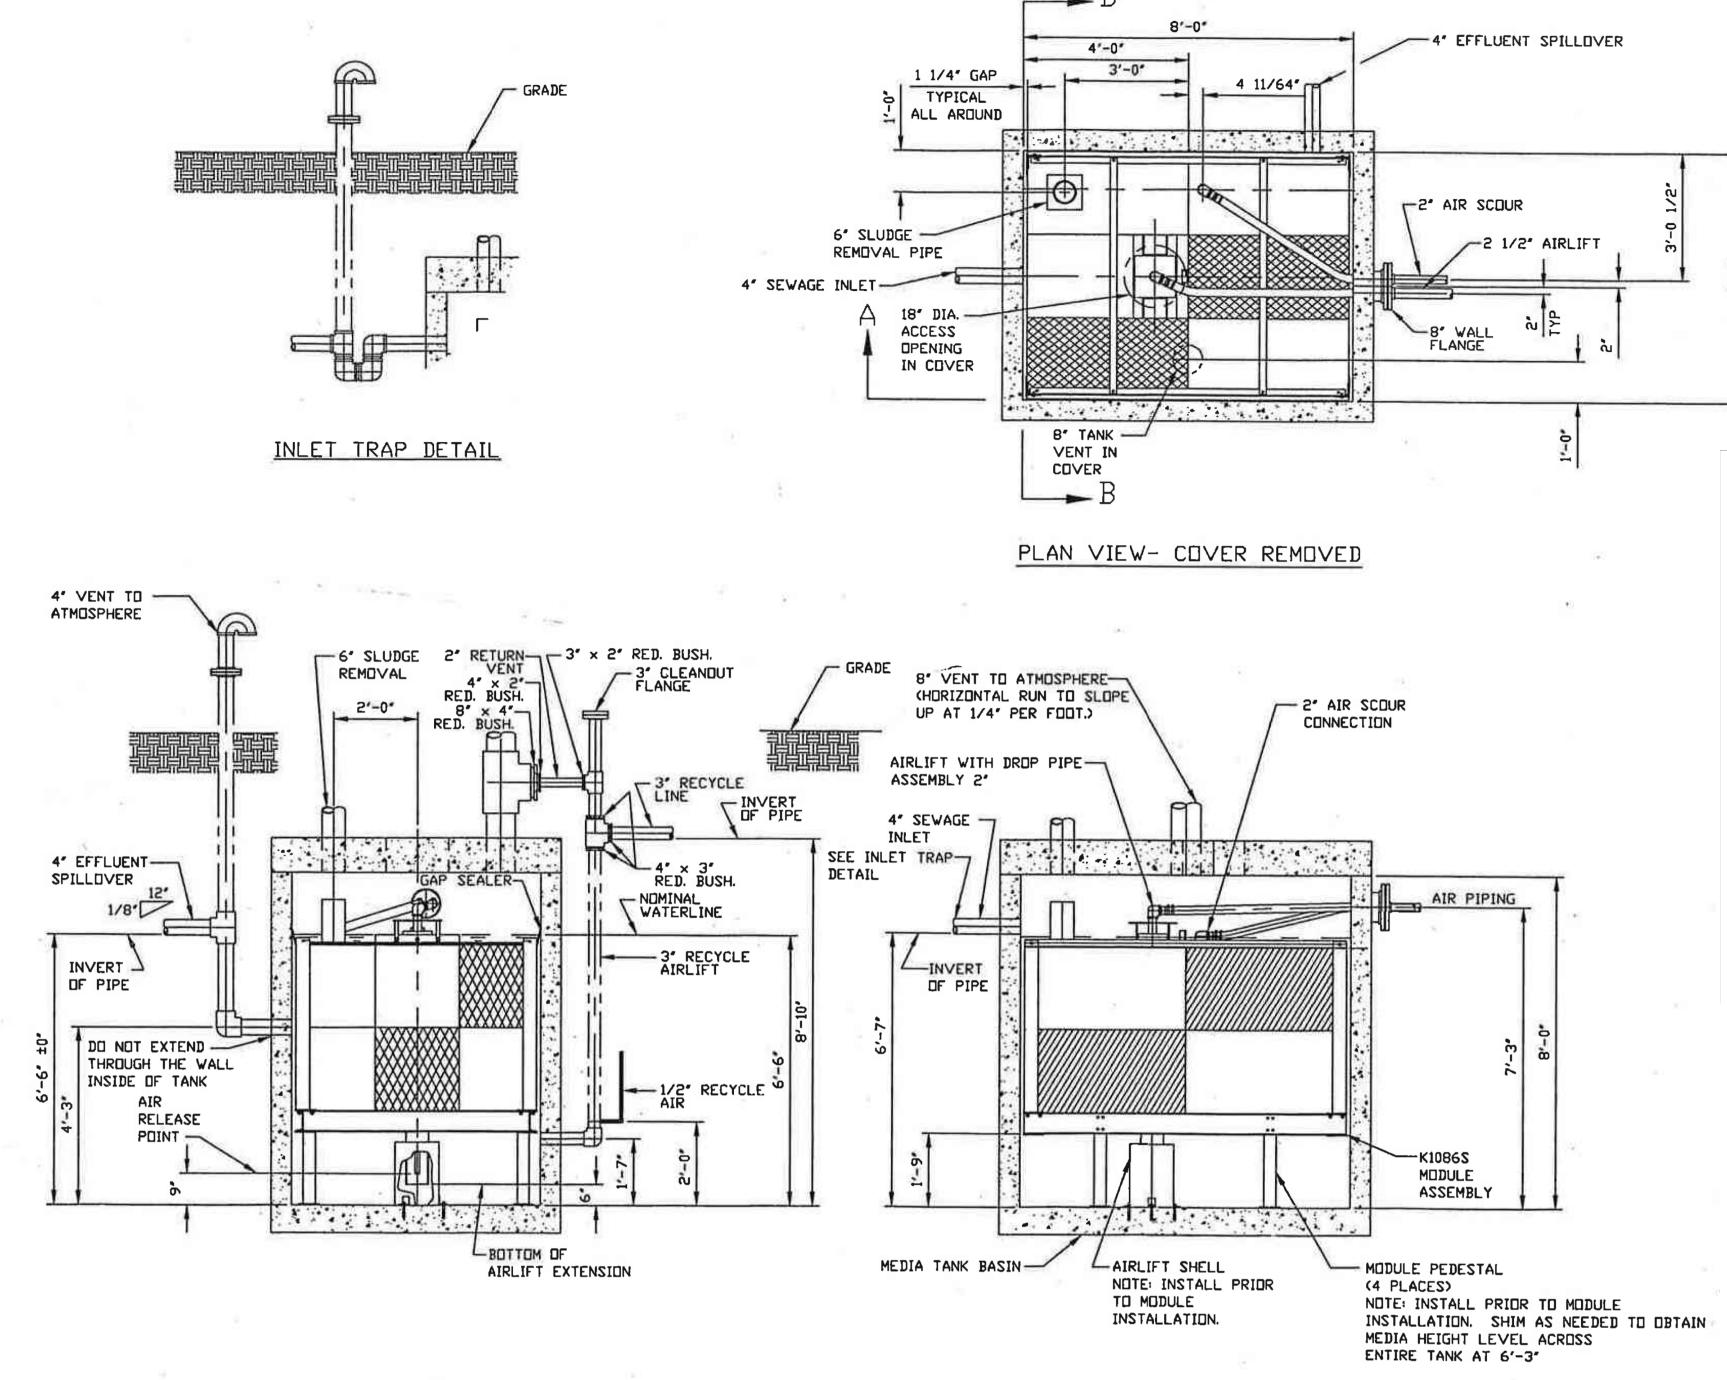


<u>end view- section B-B</u>

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TYPICAL WASTE WATER TREATMENT PLANT (WWTP) NO SCALE


					LATEST CONTROLLED VERSION.			
		BLACK & VEATCH CORP HEADQUARTERS:			SHANNON LNG LIMITED	PROJECT	DRAWING NUMBER	REV
2 28/APR/2023 ISSUED FOR PLANNING	DSP NNC DAC			CK&VEATCH	SHANNON TECHNOLOGY AND ENERGY PARK (STEP)	198291-19	STU-S3960	2
1 18/JUN/2021 ISSUED FOR PLANNING	TAH JDA DAC	KANSAS, USA	DESIGNER	DRAWN	SANITARY LAYOUT - SITE	CODE		
0 30/APR/2021 ISSUED FOR PLANNING	BJR JDA DAC		JDA	BJR	TYPICAL LIFT STATION DETAILS			
NO         DATE         REVISIONS AND RECORD OF ISSUE	DRN DES CHK PDE APP		CHECKED	DAIE		AREA		



ELEVATION- SECTION A-A
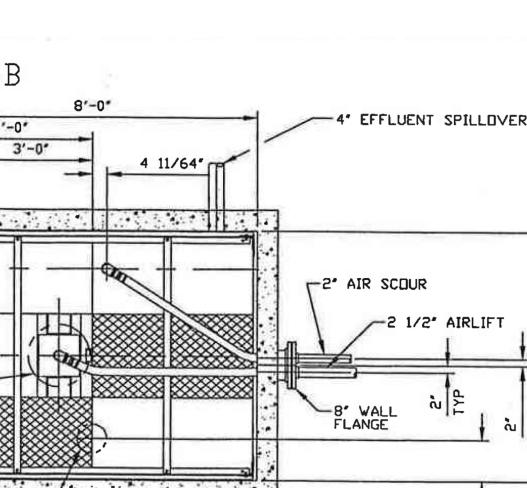
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2	28/APR/2023	ISSUED FOR PLANNING	DSP	NNC		DAC	
1	18/JUN/2021	ISSUED FOR PLANNING	ТАН	JDA		DAC	
0	30/APR/2021	ISSUED FOR PLANNING	BJR	JDA		DAC	
NO	DATE	REVISIONS AND RECORD OF ISSUE	DRN	DES	СНК	PDE	APP

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BLACK & VEATCH CORP HEADQUARTERS: 11401 LAMAR AVENUE, OVERLAND PARK, KANSAS, USA SHA BJR

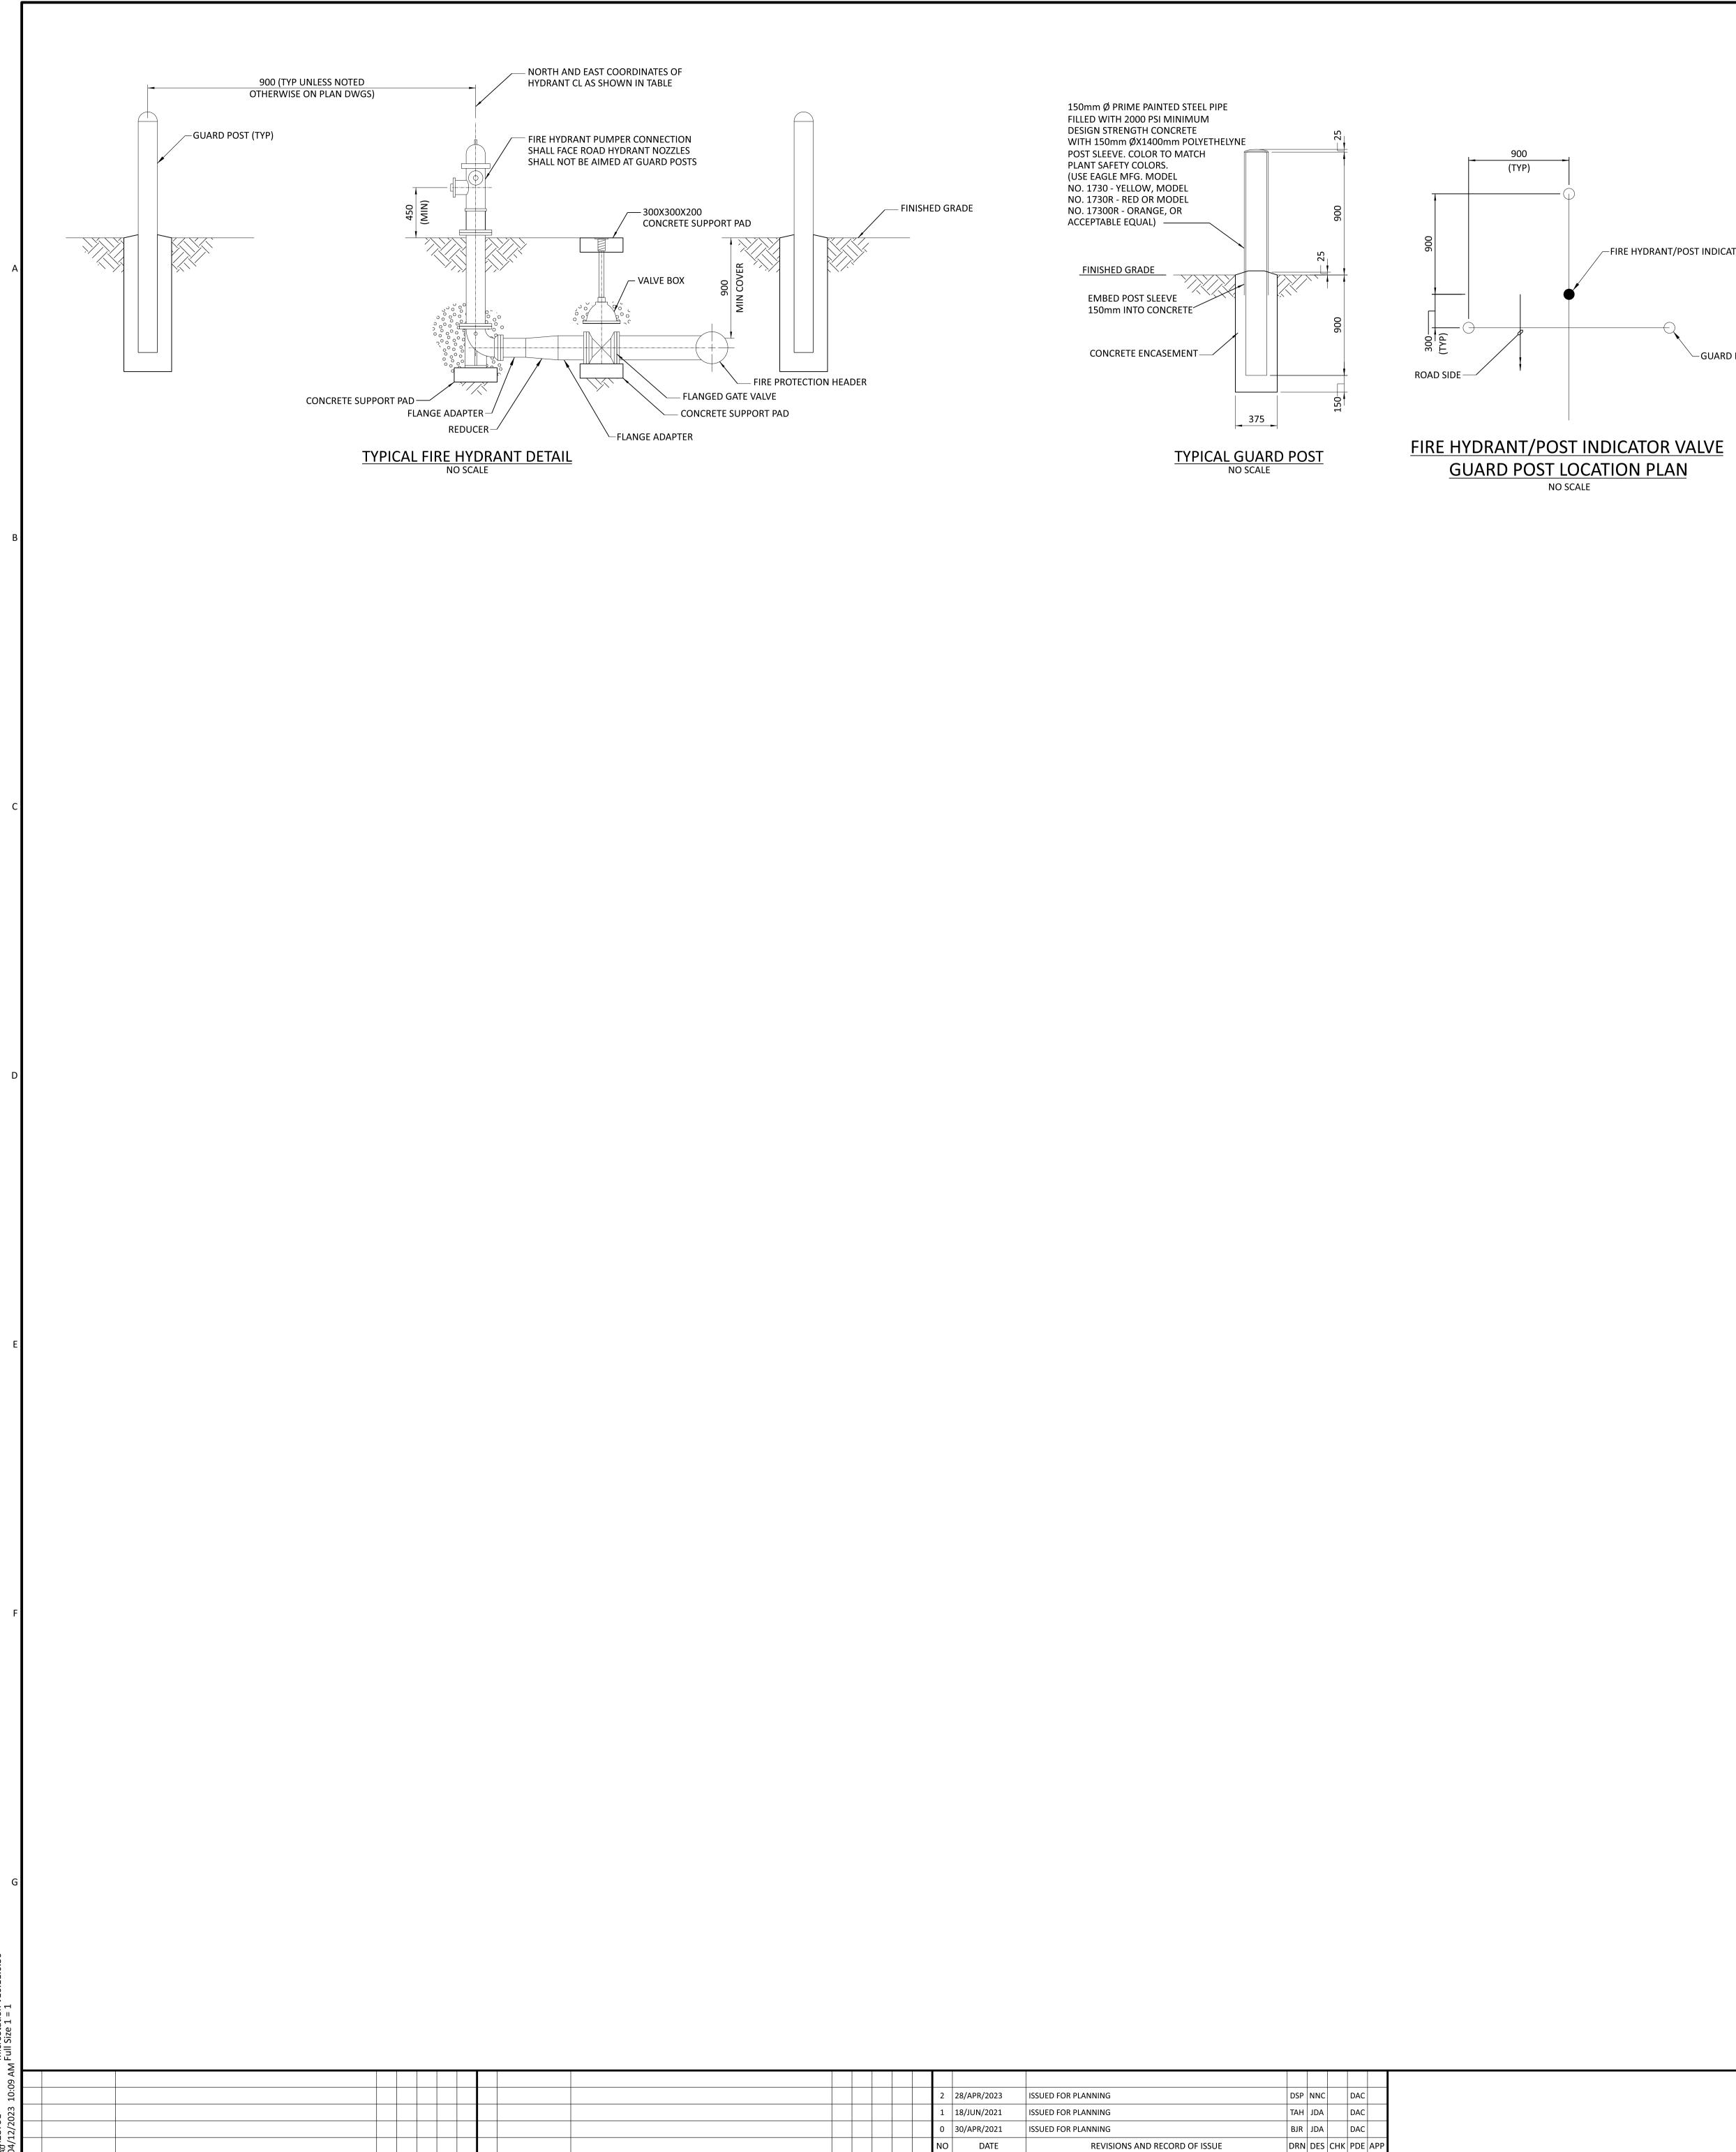DATE

JDA

-FIRE HYDRANT/POST INDICATOR VALVE	



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SHANNON LNG LIMITED	PROJECT	DRAWING NUMBER	REV
ANNON TECHNOLOGY AND ENERGY PARK (STEP)	198291-19	STU-S3962	2
FIRE WATER LAYOUT - SITE TYPICAL FIRE WATER DETAILS	CODE		
TIFICALTINE WATER DETAILS	AREA		